

A.C.	AIR CONDITIONING	LAM.	LAMINATE
ACOUS.	ACOUSTICAL	LAV.	LAVATORY
ADJ.	ADJUSTABLE	MAT.	MATERIAL
A.F.F.	ABOVE FINISH FLOOR	MAX.	MAXIMUM
ALUM.	ALUMINUM	M.B.	MACHINE BOLT
ANOD.	ANODIZED	M.C.	MEDICINE CABINET
BD.	BOARD	(M)	MODIFIED
BLDG.	BUILDING	MIN.	MINIMUM
BLKG.	BLOCKING	MIR.	MIRROR
BOT.	BOTTOM	MISC.	MISCELLANEOUS
BM.	BEAM	MTL.	METAL
CAB.	CABINET	MTD.	MOUNTED
CEM.	CEMENT	(N)	NEW
CER.	CERAMIC	N.I.C.	NOT IN CONTRACT
C.G.	CORNER GUARD	NO.	NUMBER
C.L.	CENTER LINE	NTE	NOT TO EXCEED
CLG.	CEILING	N.T.S.	NOT TO SCALE
CLR.	CLEARANCE	O.C.	ON CENTER
CMU.	CONCRETE MASONRY UNIT	O.D.	OUTSIDE DIAMETER
COL.	COLUMN	O.H.	OVER HEAD
CONC.	CONCRETE	PL.	PLATE
CONST.	CONSTRUCTION	PLAM.	PLASTIC LAMINATE
CONTR.	CONTRACTOR	PLYWD.	PLYWOOD
C.T.	CERAMIC TILE	PSI	POUNDS/SQ. INCH
CTSK.	COUNTERSINK	PT	PRESSURE TREATED
CTR.	CENTER	Q.T.	QUARRY TILE
DA	DISABLED ACCESSIBLE	R	RISER
DBL.	DOUBLE	(R)	REPLACE
D.F.	DOUGLAS FIR	REINF.	REINFORCING
DET.	DETAIL	REQD	REQUIRED
DIAG.	DIAGONAL	REV.	REVISED
DIA.	DIAMETER	RM.	ROOM
DIM.	DIMENSION	RO.	ROUGH OPENING
DN.	DOWN	RWL	RAIN WATER LEADER
DR.	DOOR	SAD	SUPPLY AIR DUCT
DWG.	DRAWING	SCHED.	SCHEDULE
D.S.	DOWNSPOUT	SEC.	SECTION
(E)	EXISTING	SHT.	SHEET
EA.	EACH	S&P	SHELF AND POLE
ELEC.	ELECTRICAL	SL	SKYLIGHT
E.P.	ELECTRICAL PANEL	SLM.	SIMILAR
ELEV.	BUILDING ELEVATION	SPEC.	SPECIFICATION
EQ.	EQUAL	SQ.	SQUARE
EXP.	EXPOSED	S.S.	STAINLESS STEEL
EXT.	EXTERIOR	S.S.D.	SEE STRUTURAL, DRAWINGS
F.FLR.	FINISH FLOOR	S.M.D.	SEE MECH. DRAWINGS
FLASH.	FLASHING	STD.	STANDARD
F.O.F.	FACE OF FINISH	STL.	STEEL
F.O.S.	FACE OF STUD	STOR.	STORAGE
FR.C.	FRENCH CASEMENT	STRUCT.	STRUCTURAL
FTG.	FOOTING	SUSP.	SUSPENDED
FX.	FIXED	T.B.	TOWEL BAR
GA.	GAUGE	T.O.S.	TOP OF SLAB
GALV.	GALVANIZED	TGL.	TEMPERED GLASS
GL.	GLASS	T&G	TONGUE AND GROOVE
GR.	GRADE	TYP.	TYPICAL
GWB.	GYPNUM WALL BOARD	U.B.C.	UNIFORM BUILDING CODE
GYP.	GYPNUM	U.O.N.	UNLESS OTHERWISE NOTED
H.A.R.	HOT AIR REGISTER	V.G.	VERTICAL GRAIN
HGR.	HEADER	VERT.	VERTICAL
HDWD.	HARDWOOD	V.I.F.	VERIFY IN FIELD
HORZ.	HORIZONTAL	W/	WITH
HT.	HEIGHT	WC	WATER CLOSET
HVAC.	HEATING, VENTILATING	WD.	WOOD
INT.	INTERIOR	W.P.	WATERPROOF
INST.	INSTALLATION		
INSUL.	INSULATION		

ABBREVIATIONS

DESERT HAVEN (QUEENS MOTEL) RENOVATION PROJECT

16959 STODDARD WELLS ROAD VICTORVILLE, CA 92395

APN: 0472-181-68

- ALL WORK SHALL CONFORM TO THE FOLLOWING BUILDING CODES AND CALIFORNIA STATE BUILDING CODE AMENDMENTS, AS WELL AS AND ALL OTHER VICTORVILLE MUNICIPAL CODES - BUILDING AND CONSTRUCTION, ADDITIONAL VICTORVILLE REGULATIONS, AND NFPA STANDARDS.

2016 CALIFORNIA BUILDING CODE (CBC)
2016 CALIFORNIA ELECTRICAL CODE (CEC)
2016 CALIFORNIA PLUMBING CODE (CPC)
2016 CALIFORNIA MECHANICAL CODE (CMC)
2016 CALIFORNIA GREEN BUILDING STANDARDS CODE (CALGREEN)
- THE CONTRACTOR SHALL VERIFY ALL DIMENSIONS, CONDITIONS & SHALL NOTIFY THE ARCHITECT OF ANY DIMENSIONS & CONDITIONS, WHICH DIFFER FROM THOSE SHOWN, BEFORE STARTING WORK. DIMENSIONS GIVEN AS (CLR.) ARE CODE REQUIRED & SHALL BE MAINTAINED.
- ALL DIMENSIONS FOR NEW CONSTRUCTION ARE TO FACE OF STUD. ALL DIMENSIONS FROM EXISTING CONSTRUCTION ARE FROM FACE TO FINISH, UNLESS OTHER WISE NOTED (U.O.N.).
- DO NOT SCALE DRAWINGS. WRITTEN DIMENSIONS TAKE PRECEDENCE OVER SCALED DIMENSIONS, DIMENSIONS FOR EXISTING CONDITIONS & ELEVATIONS MAY BE APPROXIMATE.
- ALL INSTALLATIONS TO BE IN ACCORDANCE WITH BEST INDUSTRY STANDARDS & MANUFACTURER'S REQUIREMENTS, SEE ATTACHED SPECIFICATIONS.
- ALL THE DRAWINGS SHOW REPRESENTATIVE & TYPICAL ATTACHMENTS, CONNECTIONS, FASTENINGS & ETC. SHALL BE PROPERLY SECURED IN CONFORMANCE WITH BEST PRACTICE.
- THE PLANS MAY OR MAY NOT BE BASED ON A SURVEY & ARE INTENDED ONLY TO SHOW GENERAL LAYOUT OF PROPERTY & WORK LOCATIONS. CONDITIONS SHOWN APPROXIMATE.
- ALL WORK TO BE PAINTED TO MATCH (E), UNLESS OTHERWISE NOTED.
- ALL WORK SUBJECT TO ASSOCIATED PROJECT MANUAL SPECIFICATIONS AND INSTRUCTIONS BY ARCHITECT.
- ALL CONDITIONS ARE EXISTING UNLESS OTHERWISE NOTED.
- PROJECT IS "PUBLIC HOUSING" PER CBC 11B IS THE STANDARD FOR DESIGN. SOME 11 B ELEMENTS ARE TECHNICALLY INFEASIBLE DUE TO EXISTING CONDITIONS.
- PROJECT CONVERTS OCCUPANCY FROM R1 TO R2

HAZARDOUS MATERIALS IN EXISTING CONSTRUCTION
BASIS ARCHITECTURE & CONSULTING ASSUMES NO RESPONSIBILITY FOR THE MANAGEMENT OF HAZARDOUS MATERIALS THAT MAY BE ON SITE. THE CONTRACTOR SHALL BE RESPONSIBLE FOR INSURING THAT PERSONNEL WITHIN THE WORK AREA ARE PROTECTED FROM EXPOSURE TO HAZARDOUS MATERIALS. IF MATERIALS ARE DISCOVERED THAT MAY BE HAZARDOUS, THE CONTRACTOR SHALL IMMEDIATELY NOTIFY THE OWNER AND CEASE WORK UNTIL CONDITIONS CAN BE MAINTAINED IN COMPLIANCE WITH ALL APPLICABLE REGULATIONS.

GENERAL NOTES, CODE INFO

SITE

OVERLAY PAVING, ADD (N) PERIMETER FENCE, ROLLING VEHICLE GATE AND PEDESTRIAN GATE. FILL POOL AND DEVELOP SITE AMENITIES

BUILDING

CONVERT EXISTING MOTEL TO SUPPORTIVE HOUSING WITH COMMUNITY ROOM, MANAGER'S UNIT, 7 "EFFICIENCY" UNITS (ORIGINAL MOTEL ROOMS) AND 24 APARTMENTS CONVERTED FROM PAIRS OF MOTEL ROOMS, LAUNDRY, OFFICE AND MECHANICAL SPACES. ACCESSIBLE AND ADAPTABLE UNITS TO BE PROVIDED AT GROUND FLOOR.

RESTORE AND REFURNISH EXISTING BUILDING ELEMENTS TO REMAIN

SYSTEMS:

INSTALL (N) FIRE SPRINKLER AND LIFE SAFETY ALARMS W/ STROBE NOTIFIER AND CENTRAL NOTIFIER. UPDATE ELECTRICAL, PROVIDE INDIVIDUAL UNIT BREAKERS.

SCOPE OF WORK



PHOTO - EXISTING CONDITIONS

A0 COVER SHEET

SITE / LANDSCAPE

- L-0 COVER
- L-1 TOPO SURVEY
- L-2 SITE PLAN
- L-3 SITE PLAN
- L-4 PLANTING PLAN
- L-5 IRRIGATION PLAN
- L-6 LANDSCAPE
- L-7 DETAILS
- L-8 DETAILS
- L-9 DETAILS
- L-10 CONTROL PLAN
- L-11 GRADING AND DRAINAGE
- L-12 EROSION CONTROL PLAN
- L-13 ASPHALT SLURRY SPECS

ARCHITECTURAL

COVER SHEET

- A1.0 REMODELED GROUND FLOOR PLAN
- A1.1 REMODELED SECOND FLOOR PLAN
- A1.2 TYPICAL UNIT PLANS
- A1.3 DETAIL PLANS
- A1.4 DETAIL PLANS
- A1.5 DETAIL PLANS
- A1.6 DETAIL PLANS
- A3.0 INTERIOR ELEVATIONS
- A3.1 INTERIOR ELEVATIONS
- A4.0 EXTERIOR ELEVATIONS
- A5.0 WALL DETAILS
- A5.1 RAILING DETAILS
- A5.2 RAILING DETAILS
- A5.3 ACCESSIBILITY DETAILS: EXTERIOR
- A5.4 ACCESSIBILITY DETAILS: INTERIOR
- A6.0 WINDOW AND DOOR SCHEDULES
- S1.0 STRUCTURAL (RAILING)

MEP

MECHANICAL LEAD SHEET

- M0.10 MECHANICAL SCHEDULE & DETAILS
- M1.10 MECHANICAL GROUND FLOOR PLAN
- M1.20 MECHANICAL SECOND FLOOR PLAN
- M2.10 MECHANICAL UNIT PLANS
- M2.20 MECHANICAL UNIT PLANS
- M3.10 MECHANICAL COMMON AREA
- M4.10 TITLE 24
- M4.20 TITLE 24
- P0.10 PLUMBING LEAD SHEET
- P1.0 PLUMBING GROUND FLOOR PLAN
- P1.1 PLUMBING SECOND FLOOR PLAN
- P1.2 PLUMBING UNIT PLANS TYPICAL
- P1.3 PLUMBING UNIT PLANS TYPICAL
- P1.4 PLUMBING UNIT PLANS TYPICAL
- P1.5 PLUMBING UNIT PLANS TYPICAL
- E1.0 GENERAL NOTES, LEGEND, FIXT., SCHED.
- E1.1 ELECTRICAL SITE PLAN
- E2.0 FIRST FLOOR EXT. LIGHTING PLAN
- E2.1 SECOND FLOOR EXT. LIGHTING PLAN
- E3.0 ELECTRICAL UNITS, FIRST FLOOR PLAN
- E3.1 ELECTRICAL UNITS, SECOND FLOOR PLAN
- E3.2 ELECTRICAL MANAGER UNIT PLAN
- E3.3 ELECTRICAL COMM. & LAUNDRY PLAN
- E4.0 ELECTRICAL DETAILS
- E5.0 PANEL SCHEDULE
- E5.1 ONE LINE DIAGRAM
- E7.0 TITLE 24 OUTDOOR
- E7.1 TITLE 24 OUTDOOR

SHEET INDEX

OCCUPANCY: R-2, B

BUILDING GROSS AREA: 16,140 S.F.
(NO CHANGES)

SEE A4.0 FOR UNIT AND AREA BREAKDOWN.

ZONING: SP (SPECIAL PROJECT)

TYPE V-B BUILDING, NO SPRINKLER

PROVIDED PARKING: 31 (INC. 3 ACCESSIBLE), OPEN

LOT COVERAGE:

LOT SIZE: 1.34 ACRES, 58,370 S.F.

LOT COVERAGE RATIO: 13.8%

LANDSCAPE AREA: 7,801 S.F.

LANDSCAPE COVERAGE AREA RATIO: .13%

ACCESSIBILITY NOTE:

PROJECT IS PUBLICLY FUNDED HOUSING AND IS SUBJECT TO CBC 11B REQUIREMENTS. 5% OF UNITS TO BE ACCESSIBLE, TWO ACCESSIBLE UNITS, BOTH TO BE LOCATED AT LOWER LEVEL. BALANCE OF LOWER LEVEL UNITS TO BE ADAPTABLE EXCEPT "EFFICIENCY" UNITS THAT ARE ORIGINAL MOTEL ROOMS, NOT ALTERED. ALL UPPER LEVEL UNITS TO BE "STANDARD".

PROJECT DATA



OWNER
DESERT HAVEN LP
715 E. BRIER DRIVE
SAN BERNARDINO, CA 92408
RON RUHL
909-332-6316
rruhl@hacsb.com


ARCHITECT
BASIS ARCHITECTURE & CONSULTING INC
2130 4TH STREET, STE. B
SAN RAFAEL, CA 94915
Architect: Charles Pick
415-457-6035
cpick@basisarch.com
Project Manager: Tessa Lombardi
tlombardi@basisarch.com

SITE DESIGN AND LANDSCAPE


BISNETT DESIGN
16046 BEAR COURT
GRASS VALLEY, CA 95949
BRIAN BISNETT
530-277-9733
brian@bisnettdesign.com

MEP
AME DESIGN GROUP, INC.
2062 BUSINESS CENTER DRIVE, SUITE 250
IRVINE, CA 92612
GHASSAN SHREIM
949-953-0170
ghassan@amegroup.net

TEAM INDEX

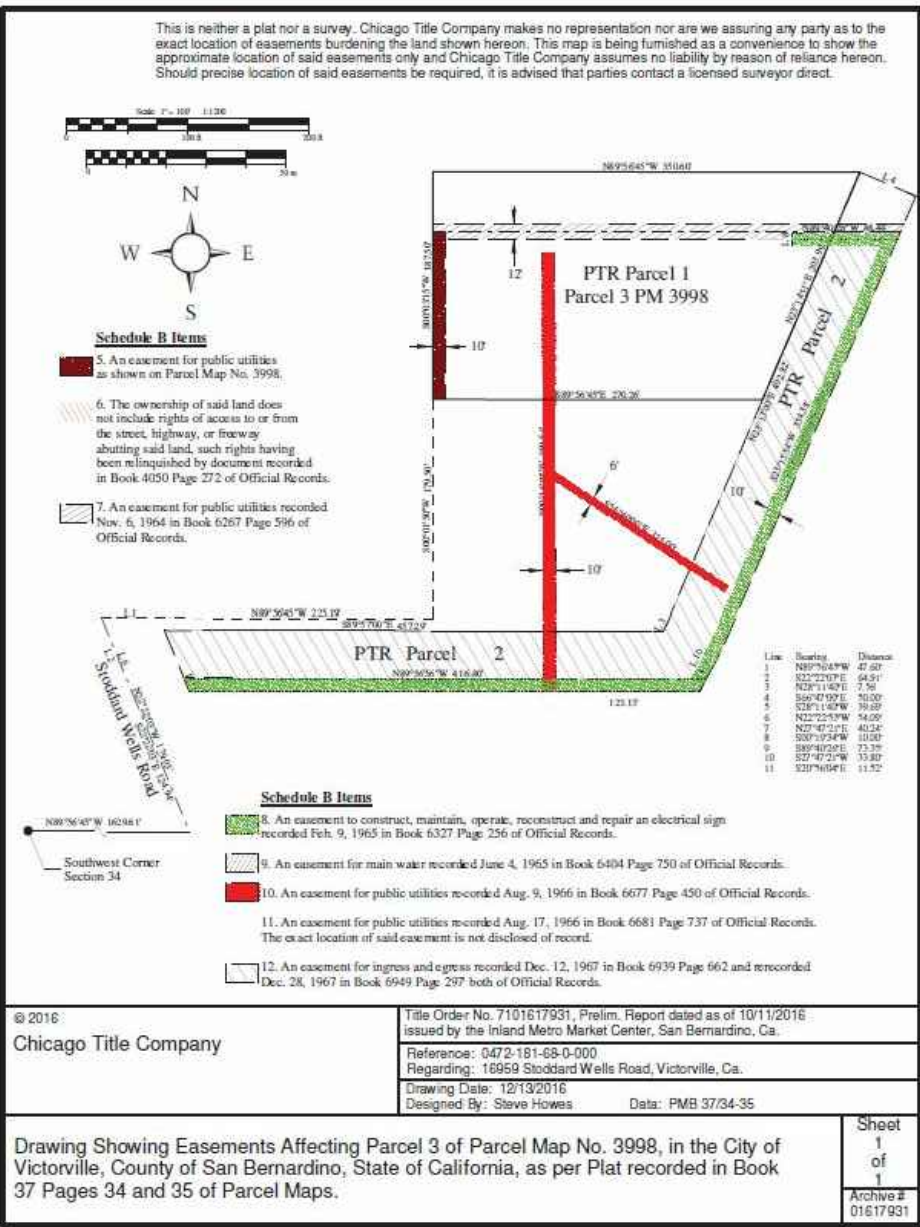

EASEMENTS

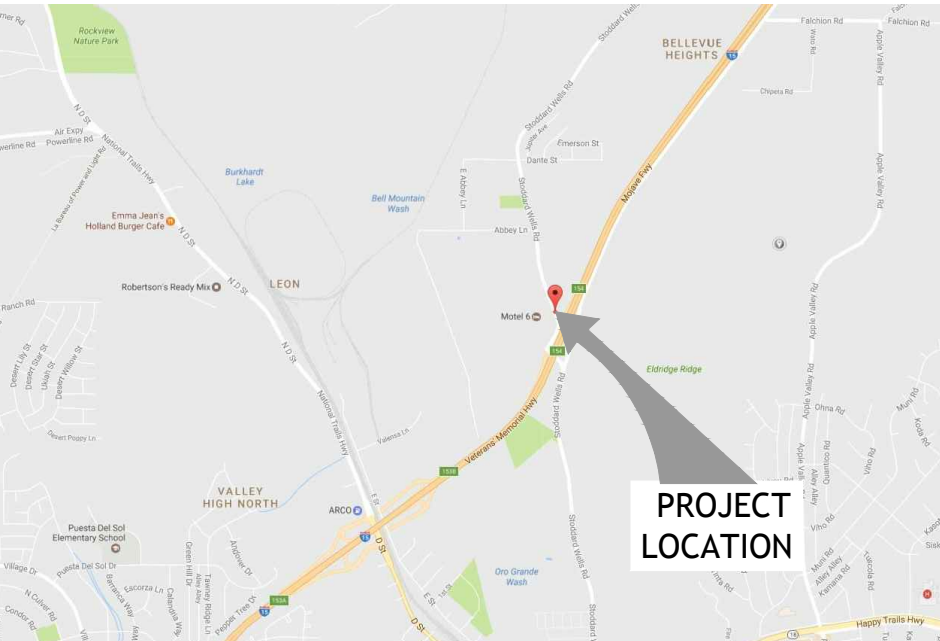


VICINITY MAP

BASIS Architecture
& Consulting

2130 FOURTH ST
SAN RAFAEL, CA 94901
PHONE (415) 457-6035
FAX (415) 457-6036

P.O.BOX 150539
SAN RAFAEL, CA 94915

CHARLES PICK, ARCHITECT

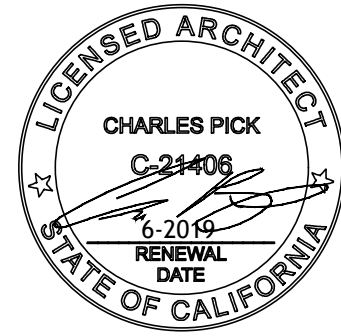

DRAWING REVISION LOG

FOR BIO	5-15-2018

PROJECT NAME:

DESERT HAVEN
(QUEEN'S MOTEL)
RE-DEVELOPMENT

PROJECT LOCATION:

16959 STODDARD WELLS RI
VICTORVILLE, CA 92395

SHEET TITLE:

COVER SHEET

ZONING PLAN


A0

SURVEYOR'S STATEMENT

- I, I FURTHER CERTIFY THAT THIS MAP OR PLAT AND THE SURVEY ON WHICH IT IS BASED WERE MADE IN ACCORDANCE WITH THE 2016 MINIMUM STANDARD DETAIL REQUIREMENTS FOR ALTA/NSPS LAND TITLE SURVEYS, JOINTLY ESTABLISHED AND ADOPTED BY ALTA AND NSPS, AND INCLUDES ITEMS 2, 3, 4, 6a, 6b, 7a, 7b, 1, 7c, 8, 9, 11, 13, 14, 16 AND 20 OF TABLE A THEREOF. THE FIELD WORK WAS COMPLETED ON 8-9-17.
2. THE ACCOMPANYING SURVEY WAS MADE ON THE GROUND AND CORRECTLY SHOWS THE LOCATION OF ALL BUILDINGS, STRUCTURES AND OTHER IMPROVEMENTS SITUATED ON THE PROPERTY DESCRIBED HEREIN AND THAT THERE ARE NO VISIBLE ENCROACHMENTS ON THE SUBJECT PROPERTY OR UPON ADJACENT LAND ABUTTING SAID PROPERTY, EXCEPT AS SHOWN HEREON.
3. THE PROPERTY DESCRIBED HEREIN IS THE SAME AS THE PROPERTY DESCRIBED IN CHICAGO TITLE COMPANY ORDER NO 7101620377, DATED MARCH 20, 2017, AND THAT ALL EASEMENTS, COVENANTS, AND RESTRICTIONS REFERENCED IN SAID TITLE COMMITMENT OR APPARENT FROM PHYSICAL INSPECTION OF THE SITE OR OTHERWISE KNOWN TO ME HAVE BEEN PLOTTED HEREON OR OTHERWISE NOTED AS TO THEIR EFFECT ON THE SUBJECT PROPERTY.
4. SAID PROPERTY IS LOCATED WITHIN AN AREA HAVING A ZONE DESIGNATION 'X' BY THE FEDERAL EMERGENCY MANAGEMENT AGENCY (FEMA), ON FLOOD INSURANCE RATE MAP NO. 06071C5820J, WITH A DATE OF IDENTIFICATION OF 09-02-2016, FOR THE CITY OF VICTORVILLE, IN SAN BERNARDINO COUNTY, STATE OF CALIFORNIA, WHICH IS THE CURRENT FLOOD INSURANCE RATE MAP FOR THE COMMUNITY IN WHICH SAID PROPERTY IS SITUATED.
5. THE PROPERTY DESCRIBED HEREIN HAS ACCESS VIA EASEMENT TO STODDARD WELLS ROAD, A DEDICATED PUBLIC STREET.
6. THE TOTAL NUMBER OF STRIPED PARKING SPACES ON THE PROPERTY DESCRIBED HEREIN IS 47, INCLUDING 1 DESIGNATED HANDICAP SPACE.
7. EXCEPT AS SHOWN HEREIN, ALL VISIBLE UTILITIES SERVING THE PROPERTY DESCRIBED HEREIN ENTER THROUGH ADJOINING PUBLIC STREETS AND/ OR EASEMENTS OF RECORD.
8. THERE ARE NO OBSERVABLE ABOVE GROUND ENCROACHMENTS (a) BY THE IMPROVEMENTS ON THE SUBJECT PROPERTY UPON ADJOINING PROPERTIES, STREETS OR ALLEYS, OR (b) BY THE IMPROVEMENTS ON ADJOINING PROPERTIES, STREETS, OR ALLEYS UPON THE SUBJECT PROPERTY.
9. THERE IS NO OBSERVABLE EVIDENCE OF EARTH MOVING WORK, BUILDING CONSTRUCTION OR BUILDING ADDITIONS UPON THE SUBJECT PROPERTY.
10. ACCORDING TO LOCAL AGENCY THERE ARE NO PROPOSED CHANGES IN STREET RIGHT OF WAY LINES. THERE IS NO OBSERVABLE EVIDENCE OF RECENT STREET OR SIDEWALK CONSTRUCTION REPAIRS.
11. THERE IS NO OBSERVABLE EVIDENCE THAT THE SUBJECT PROPERTY IS OR HAS BEEN USED AS A SOLID WASTE DUMP, SUMP OR SANITARY LANDFILL.
12. THERE IS NO OBSERVABLE EVIDENCE THAT THERE ARE ANY CEMETERIES OR FAMILY BURIAL SITES ON SUBJECT PROPERTY.
13. THERE IS NO EVIDENCE OF RECORD THAT THERE ARE ANY GAPS OR GORES ON THE SUBJECT PROPERTY.
14. PROFESSIONAL LIABILITY INSURANCE POLICY OBTAINED BY THE SURVEYOR IN THE MINIMUM AMOUNT OF \$1,000,000.00 IS IN EFFECT THROUGHOUT THE SURVEY TERM.
15. THERE IS NO OBSERVABLE EVIDENCE OF ANY CREEKS, STREAMS, RIVERS, LAKES, PONDS, WATERWAYS OR WETLANDS ON SUBJECT PROPERTY.



SURVEYOR
REGISTRATION NO. _____
DATE: _____
JOB NO.
CALIFORNIA SURVEY CO.
136 IDAHO MARYLAND RD.
GRASS VALLEY, CA 95945
TELE (530) 273-6651

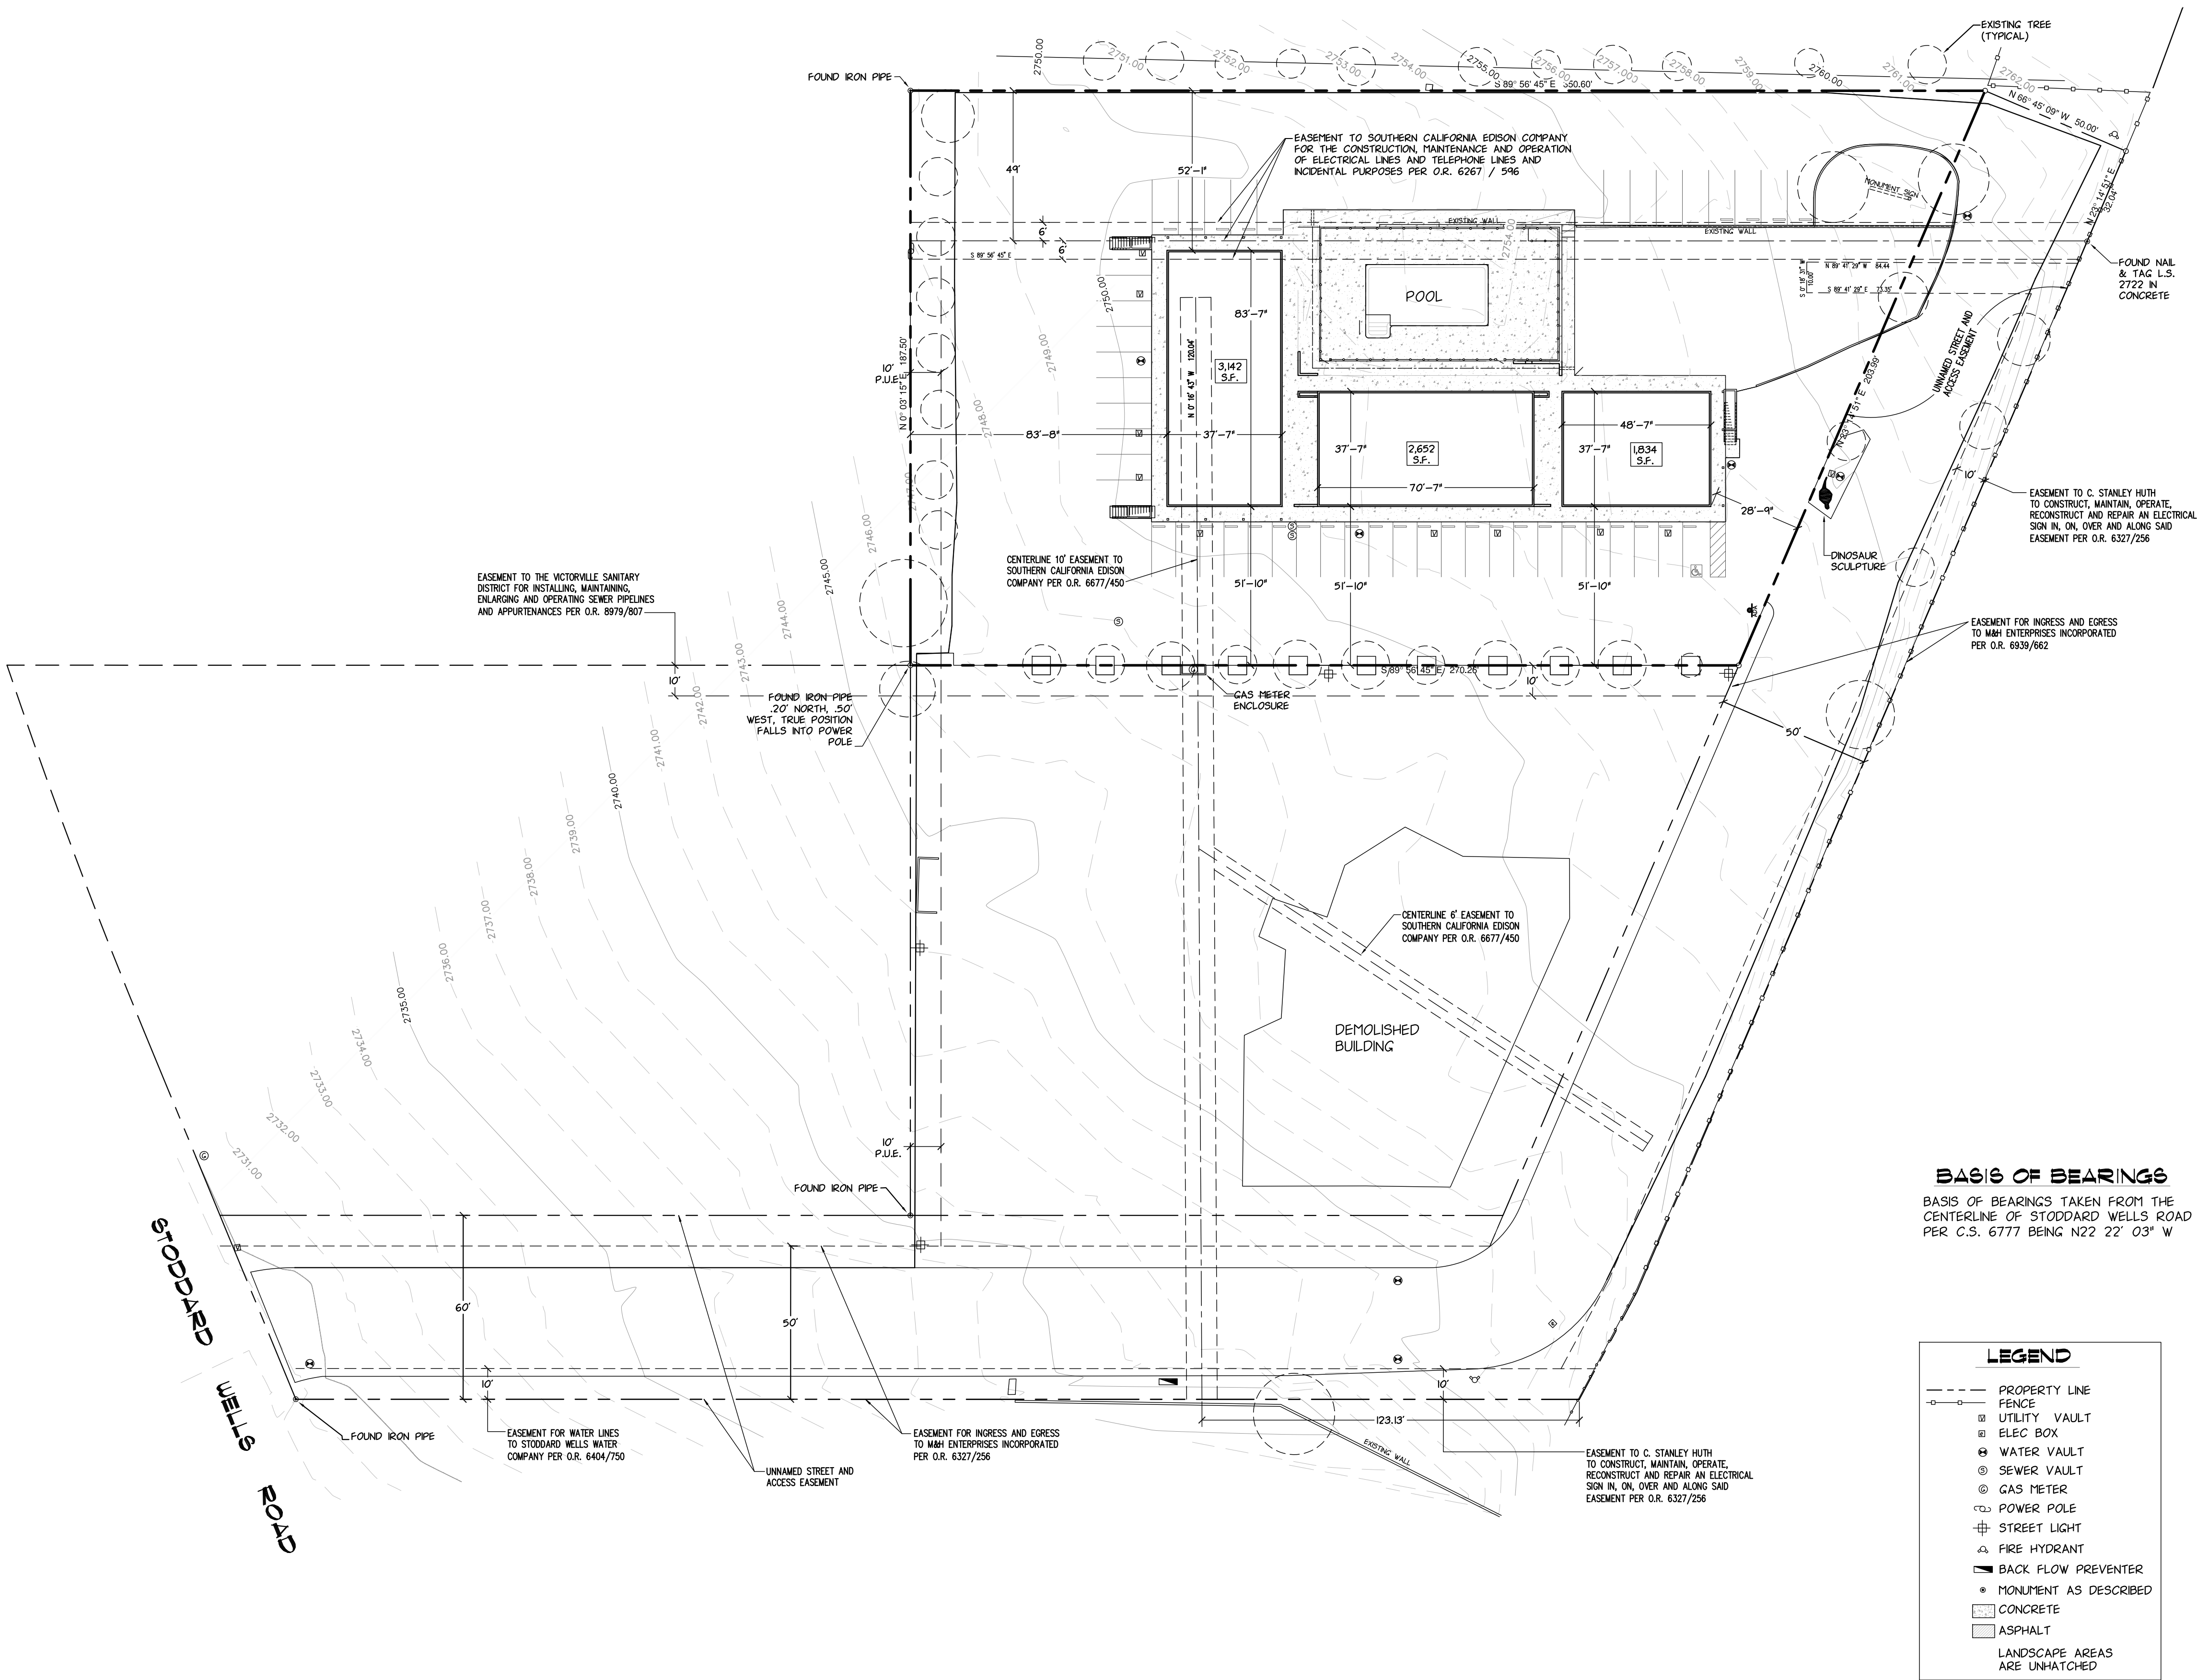

NO.	DATE	ISSUED FOR	BY
1	4-17-18	FOR REVIEW	


NOTE	0 1/2 1
SCALE: BAR SHOULD MEASURE 1" OR DRAWING IS NOT TO SCALE	
DESIGNED: JCS	
DRAWN: JCS	
CHECKED: JCS	
APPROVED: JCS	
CAD REF. FILE:	

Bisnett Design Associates

bda

16445 Bldg 200
Grass Valley, CA 95949
530.277.0733
bda@bisnettdesign.com
Landscape Architecture & Environmental Planning

DESERT HAVEN APARTMENTS CALIFORNIA VICTORVILLE, TOPOGRAPHIC SURVEY

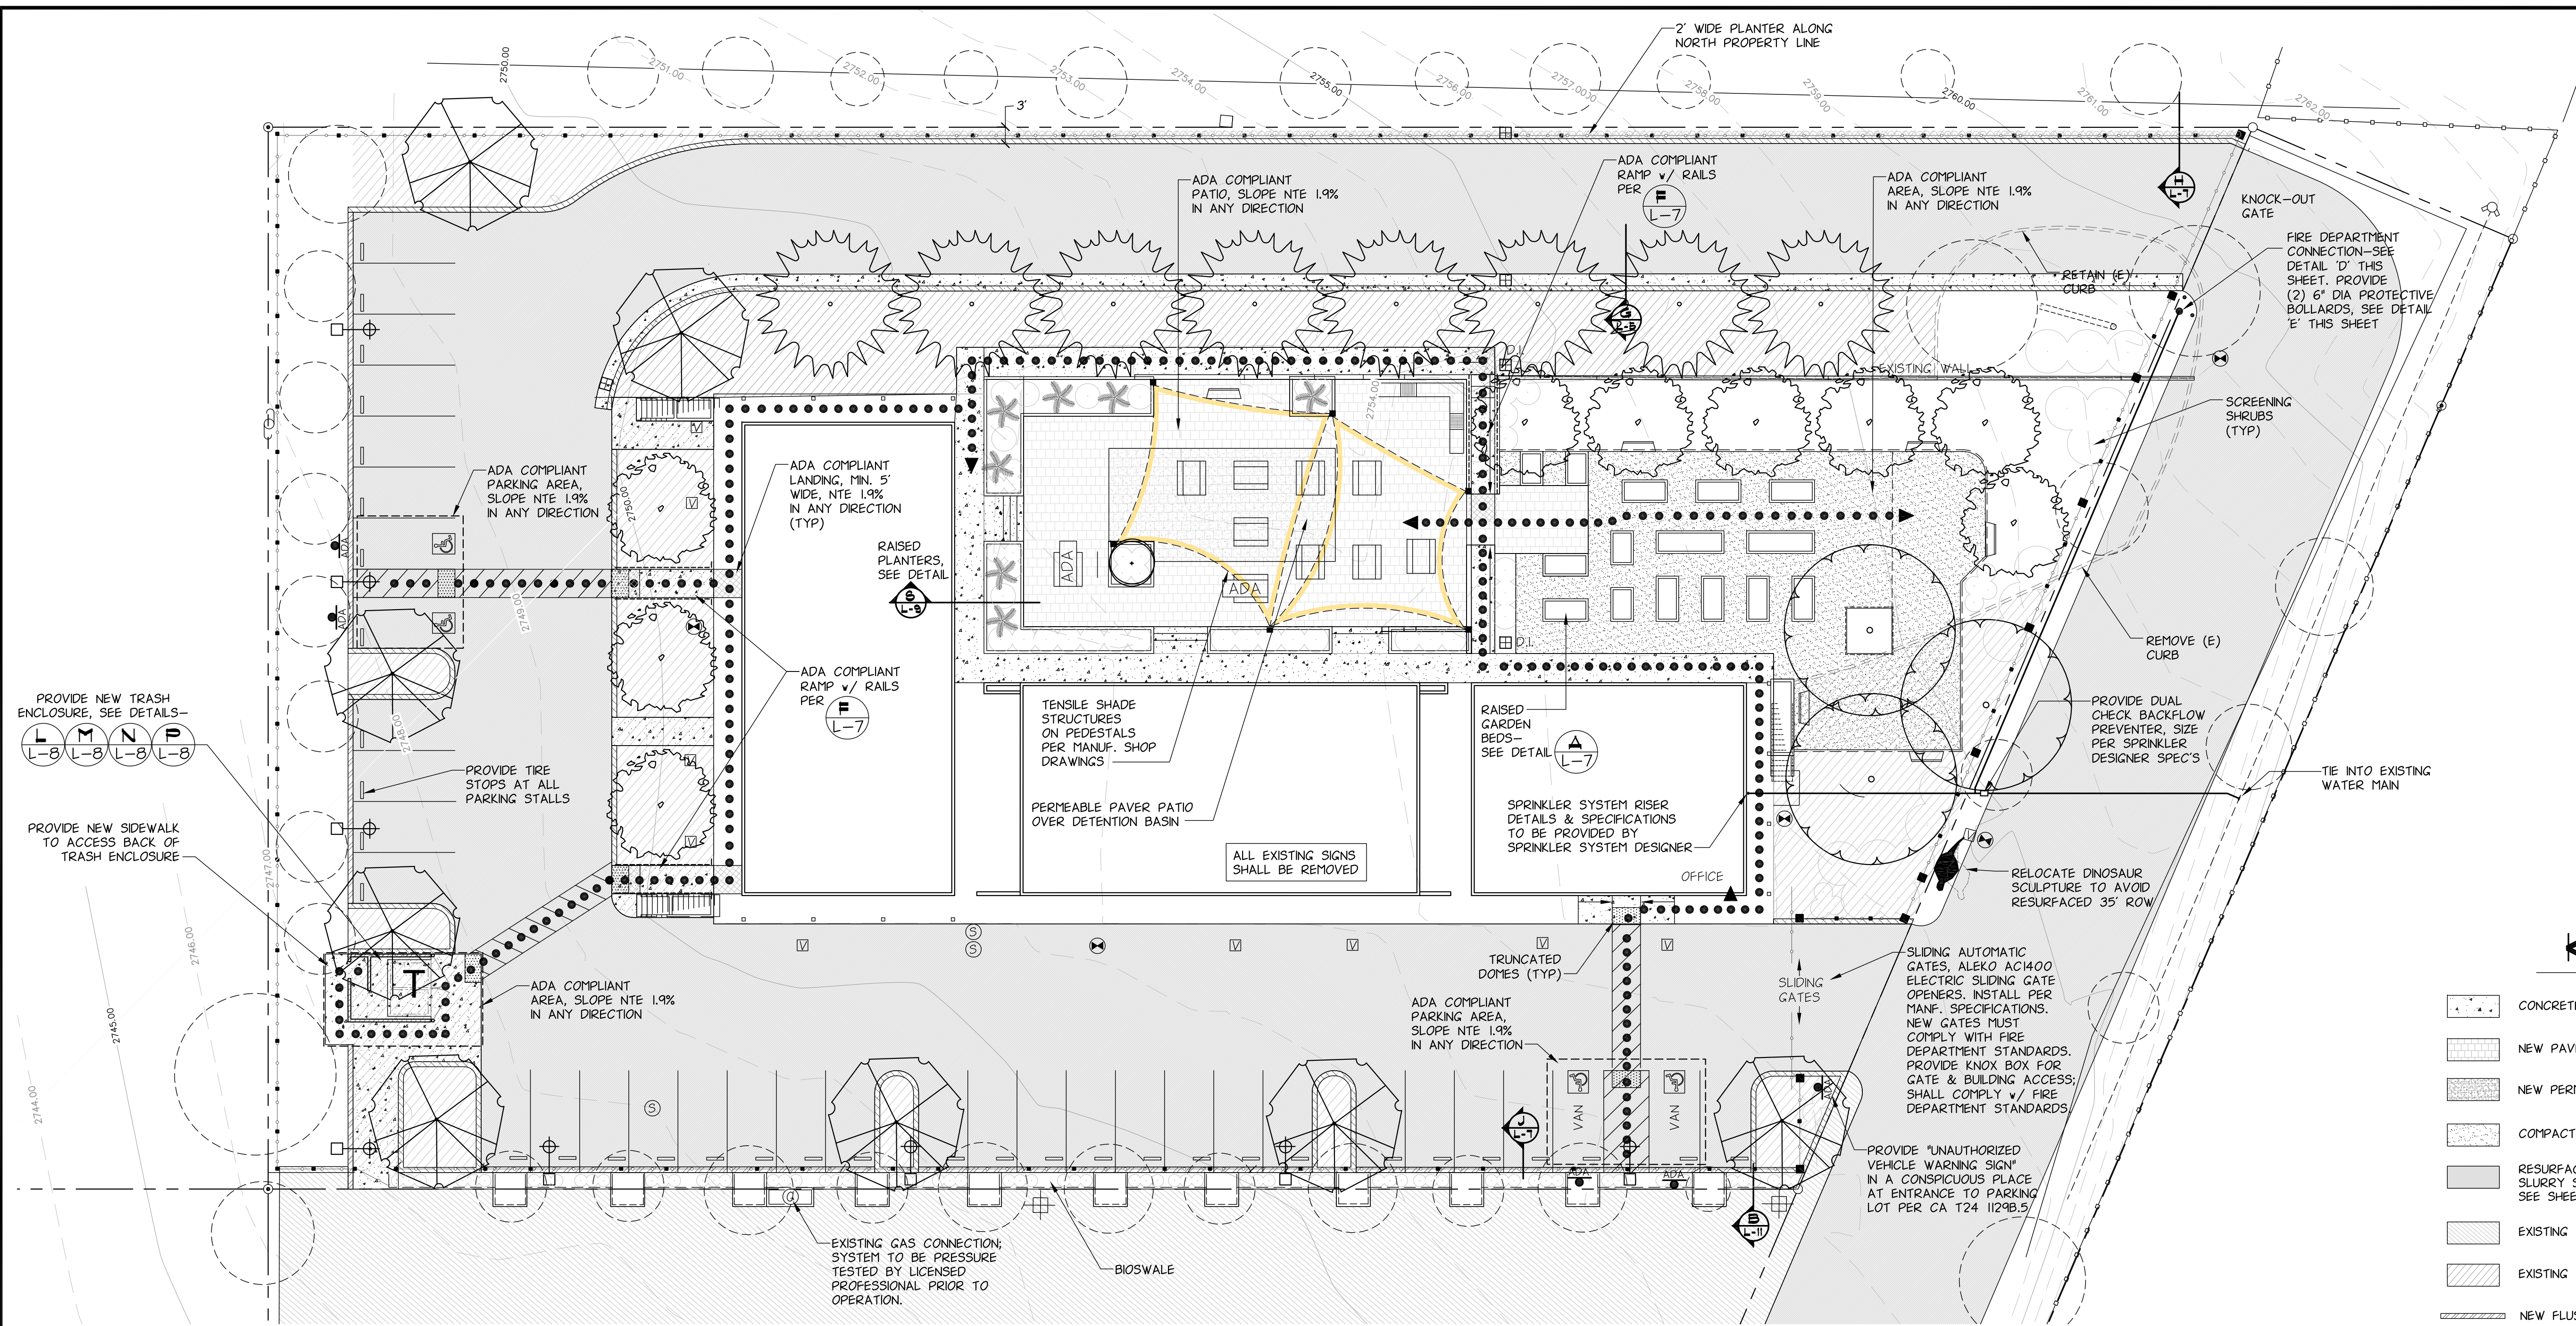


PROVIDE NEW TRASH ENCLOSURE, SEE DETAILS--
L-8 L-8 L-8 L-8 L-8
PROVIDE NEW SIDEWALK TO ACCESS BACK OF TRASH ENCLOSURE

AREAS	
COMMUNITY SPACE	
PATIO	3,540 S.F.
GARDEN	3,272 S.F.
LANDSCAPE	13,802 S.F.
CIRCULATION	
(E) RESURFACED ASPHALT	22,426 S.F.
(E) CONCRETE SIDEWALK	2,398 S.F.
(N) CONCRETE SIDEWALK	2,130 S.F.
(N) TRASH ENCLOSURE PAD	288 S.F.


SITE FURNISHING NOTES

1. 4' BENCH--COMMERCIAL SITE FURNISHINGS 4-FOOT U-LEG PERFORATED METAL COMMERCIAL PARK BENCH w/ SURFACE MOUNT, SKU# CF-FRDVX, COLOR BROWN. (6) TOTAL. SECURE w/ 4-3/8" DIA ANCHOR BOLTS SET IN CONCRETE SLAB w/ EPOXY PER MFG. SPECS AT EACH LEG. FOR DECOMPOSED GRANITE PATIO APPLICATIONS POUR 8" DIAMETER SONOTUBE FOOTING 8" DEEP @ EACH LEG & SET FLUSH w/ ADJACENT SURFACE. SECURE BENCH LEGS AS ABOVE.
2. PICNIC TABLE--COMMERCIAL SITE FURNISHINGS 6-FOOT STANDARD PERFORATED METAL TABLE w/ SURFACE MOUNT, SKU# CF-XWZH, COLOR BROWN. (8) TOTAL.
3. ACCESSIBLE PICNIC TABLE--COMMERCIAL SITE FURNISHINGS 8-FOOT STANDARD EXPANDED METAL PICNIC TABLE WITH HANDICAP ACCESS & SURFACE MOUNT, SKU# CF-QG6B, COLOR BROWN. (2) TOTAL.

CONTACT INFORMATION FOR SITE FURNISHINGS:
COMMERCIAL SITE FURNISHINGS 1-800-510-8325, commercialsitefurnishings.com

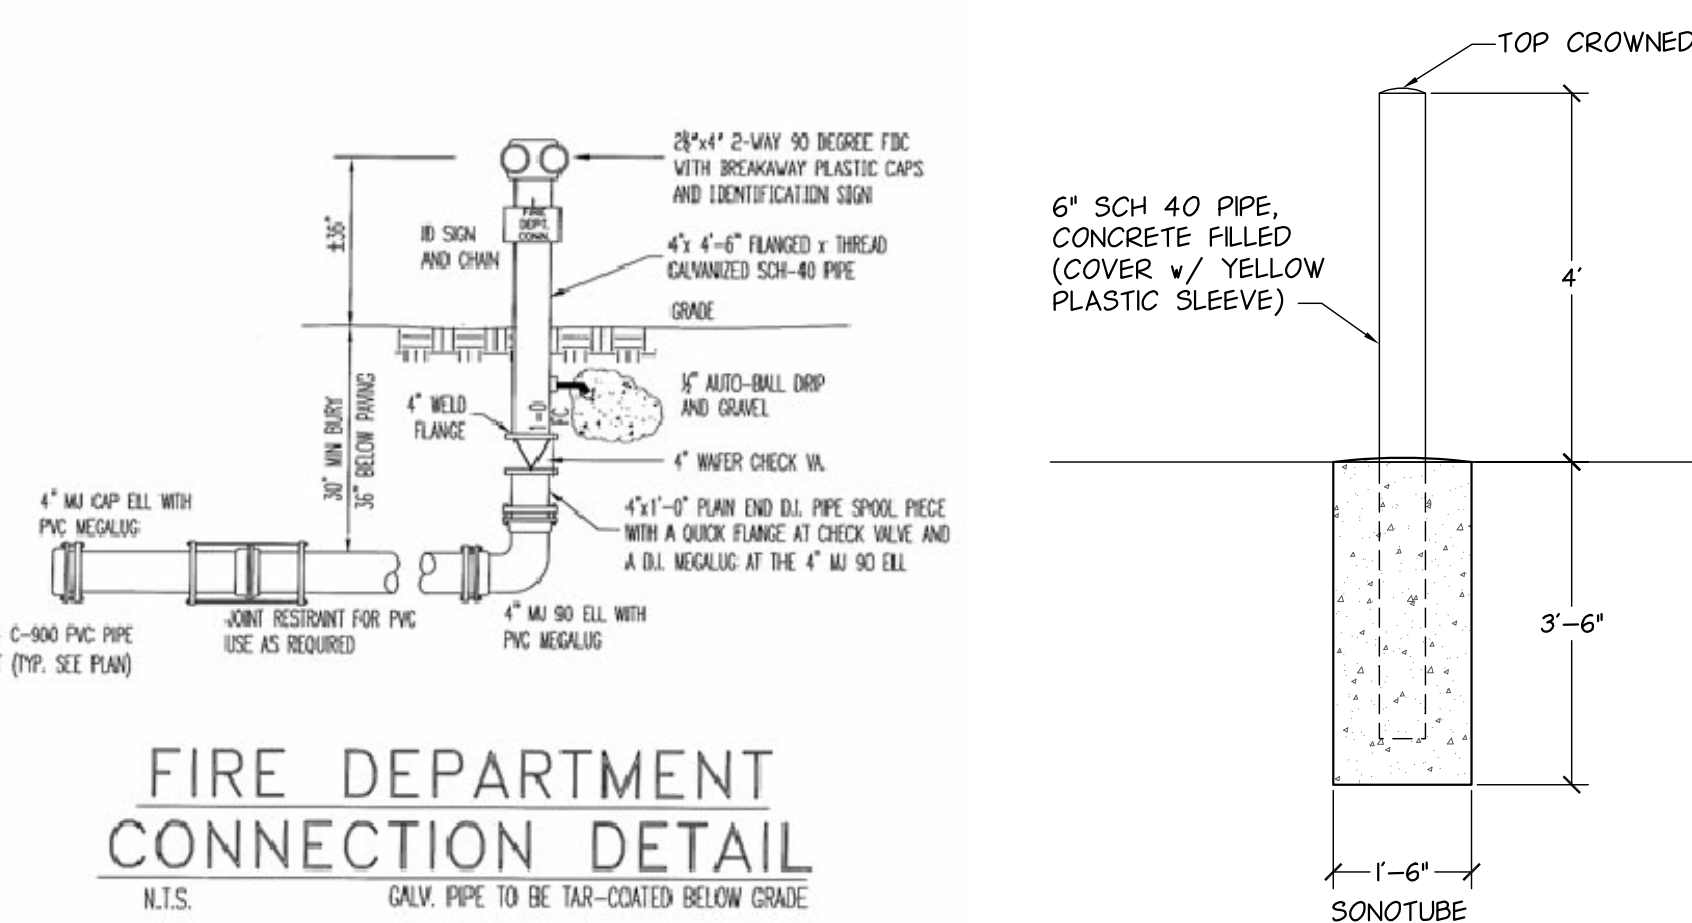


DETAIL 'D'
NOT TO SCALE

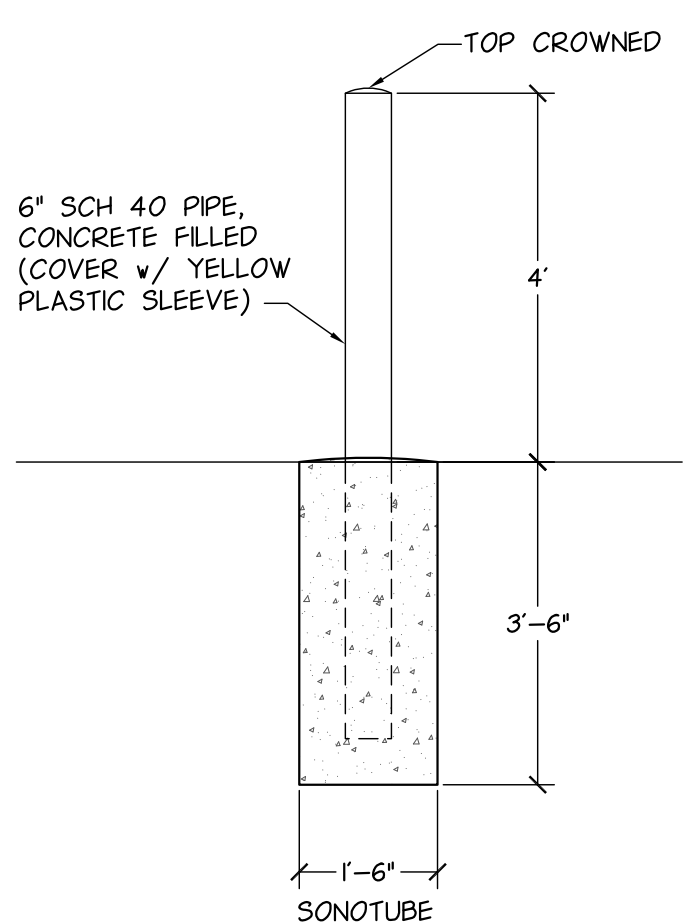

DETAIL 'E'
BOLLARD DETAIL
NOT TO SCALE

PATH OF TRAVEL NOTES:

- SLOPE NTE 4.9% IN LINE OF TRAVEL
- CROSSPITCH NTE 1.9%
- SLOPE NTE 1.9% IN ANY DIRECTION FOR LANDINGS & PARKING AREAS AS NOTED

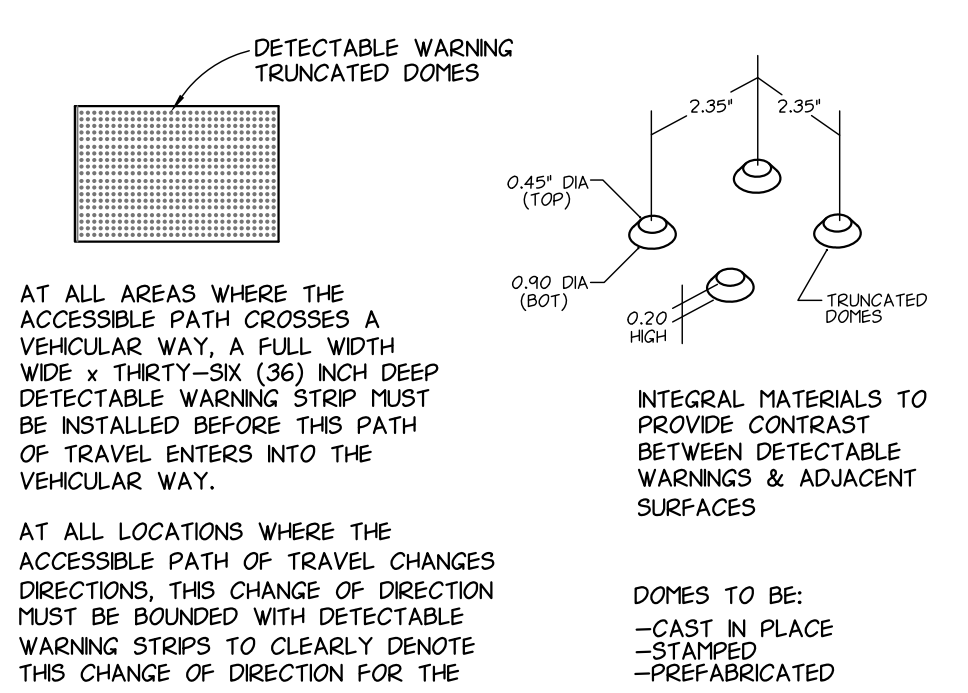

DETAIL 'F'
TRUNCATED DOME DETAIL
NOT TO SCALE


- KEY**
- CONCRETE PAVING (NEW), SEE-- (C) L-7
 - NEW PAVERS IN MORTAR BED, SEE-- (A-A) L-11
 - NEW PERMEABLE PAVERS, SEE-- (A-A) L-11
 - COMPACTED DECOMPOSED GRANITE, SEE NOTES L-6
 - RESURFACE PAVING: PATCH REPAIR POTHOLES, SLURRY SEAL AS SHOWN IN PARKING & DRIVE AREAS. SEE SHEET L-13 FOR SPECIFICATIONS
 - EXISTING ASPHALT PAVING TO REMAIN
 - EXISTING ASPHALT PAVING TO BE REMOVED
 - NEW FLUSH CURB, SEE-- (J) L-7
 - NEW RAISED CURB, SEE-- (H) L-7
 - POLE LIGHT (7), SEE-- (G) L-8
 - BENCH (6)--SEE NOTE 1 THIS SHEET
 - PICNIC TABLE (8)--SEE NOTE 2 THIS SHEET
 - ADA PICNIC TABLE (2)--SEE NOTE 3 THIS SHEET
 - BUILT-IN CHARCOAL GRILL, SEE-- (T) L-9
 - RAISED GARDEN PLANTERS (15) SEE-- (A) L-7
 - 6' ORNAMENTAL IRON FENCE SEE-- (R) L-7
 - 16" SQ. SLUMP-STONE PLASTERS ALONG NEW FENCELINE @ 24" O.C. SEE-- (E) L-7
 - ORNAMENTAL IRON FENCE w/ 2"x2" METAL POSTS @ 8' O.C. SEE-- (R) L-8
 - SURE-LOCK STEEL EDGING HEADER, SEE-- (B) L-7
 - ADA PATH OF TRAVEL--SEE NOTES THIS SHEET
 - EXISTING GAS METER
 - ADA PARKING SIGN PER (Z) L-9
 - TRUNCATED DOMES PER (F) L-2

Bisnett Design Associates
16445 Ridge Road
Great Valley, CA 95949
530.277.9735
bisnett@bisnettdesign.com
Landscape Architecture & Environmental Planning

DESERT HAVEN APARTMENTS
VICTORVILLE, CALIFORNIA


SITE PLAN

6-11-18
DRAWING: L-2

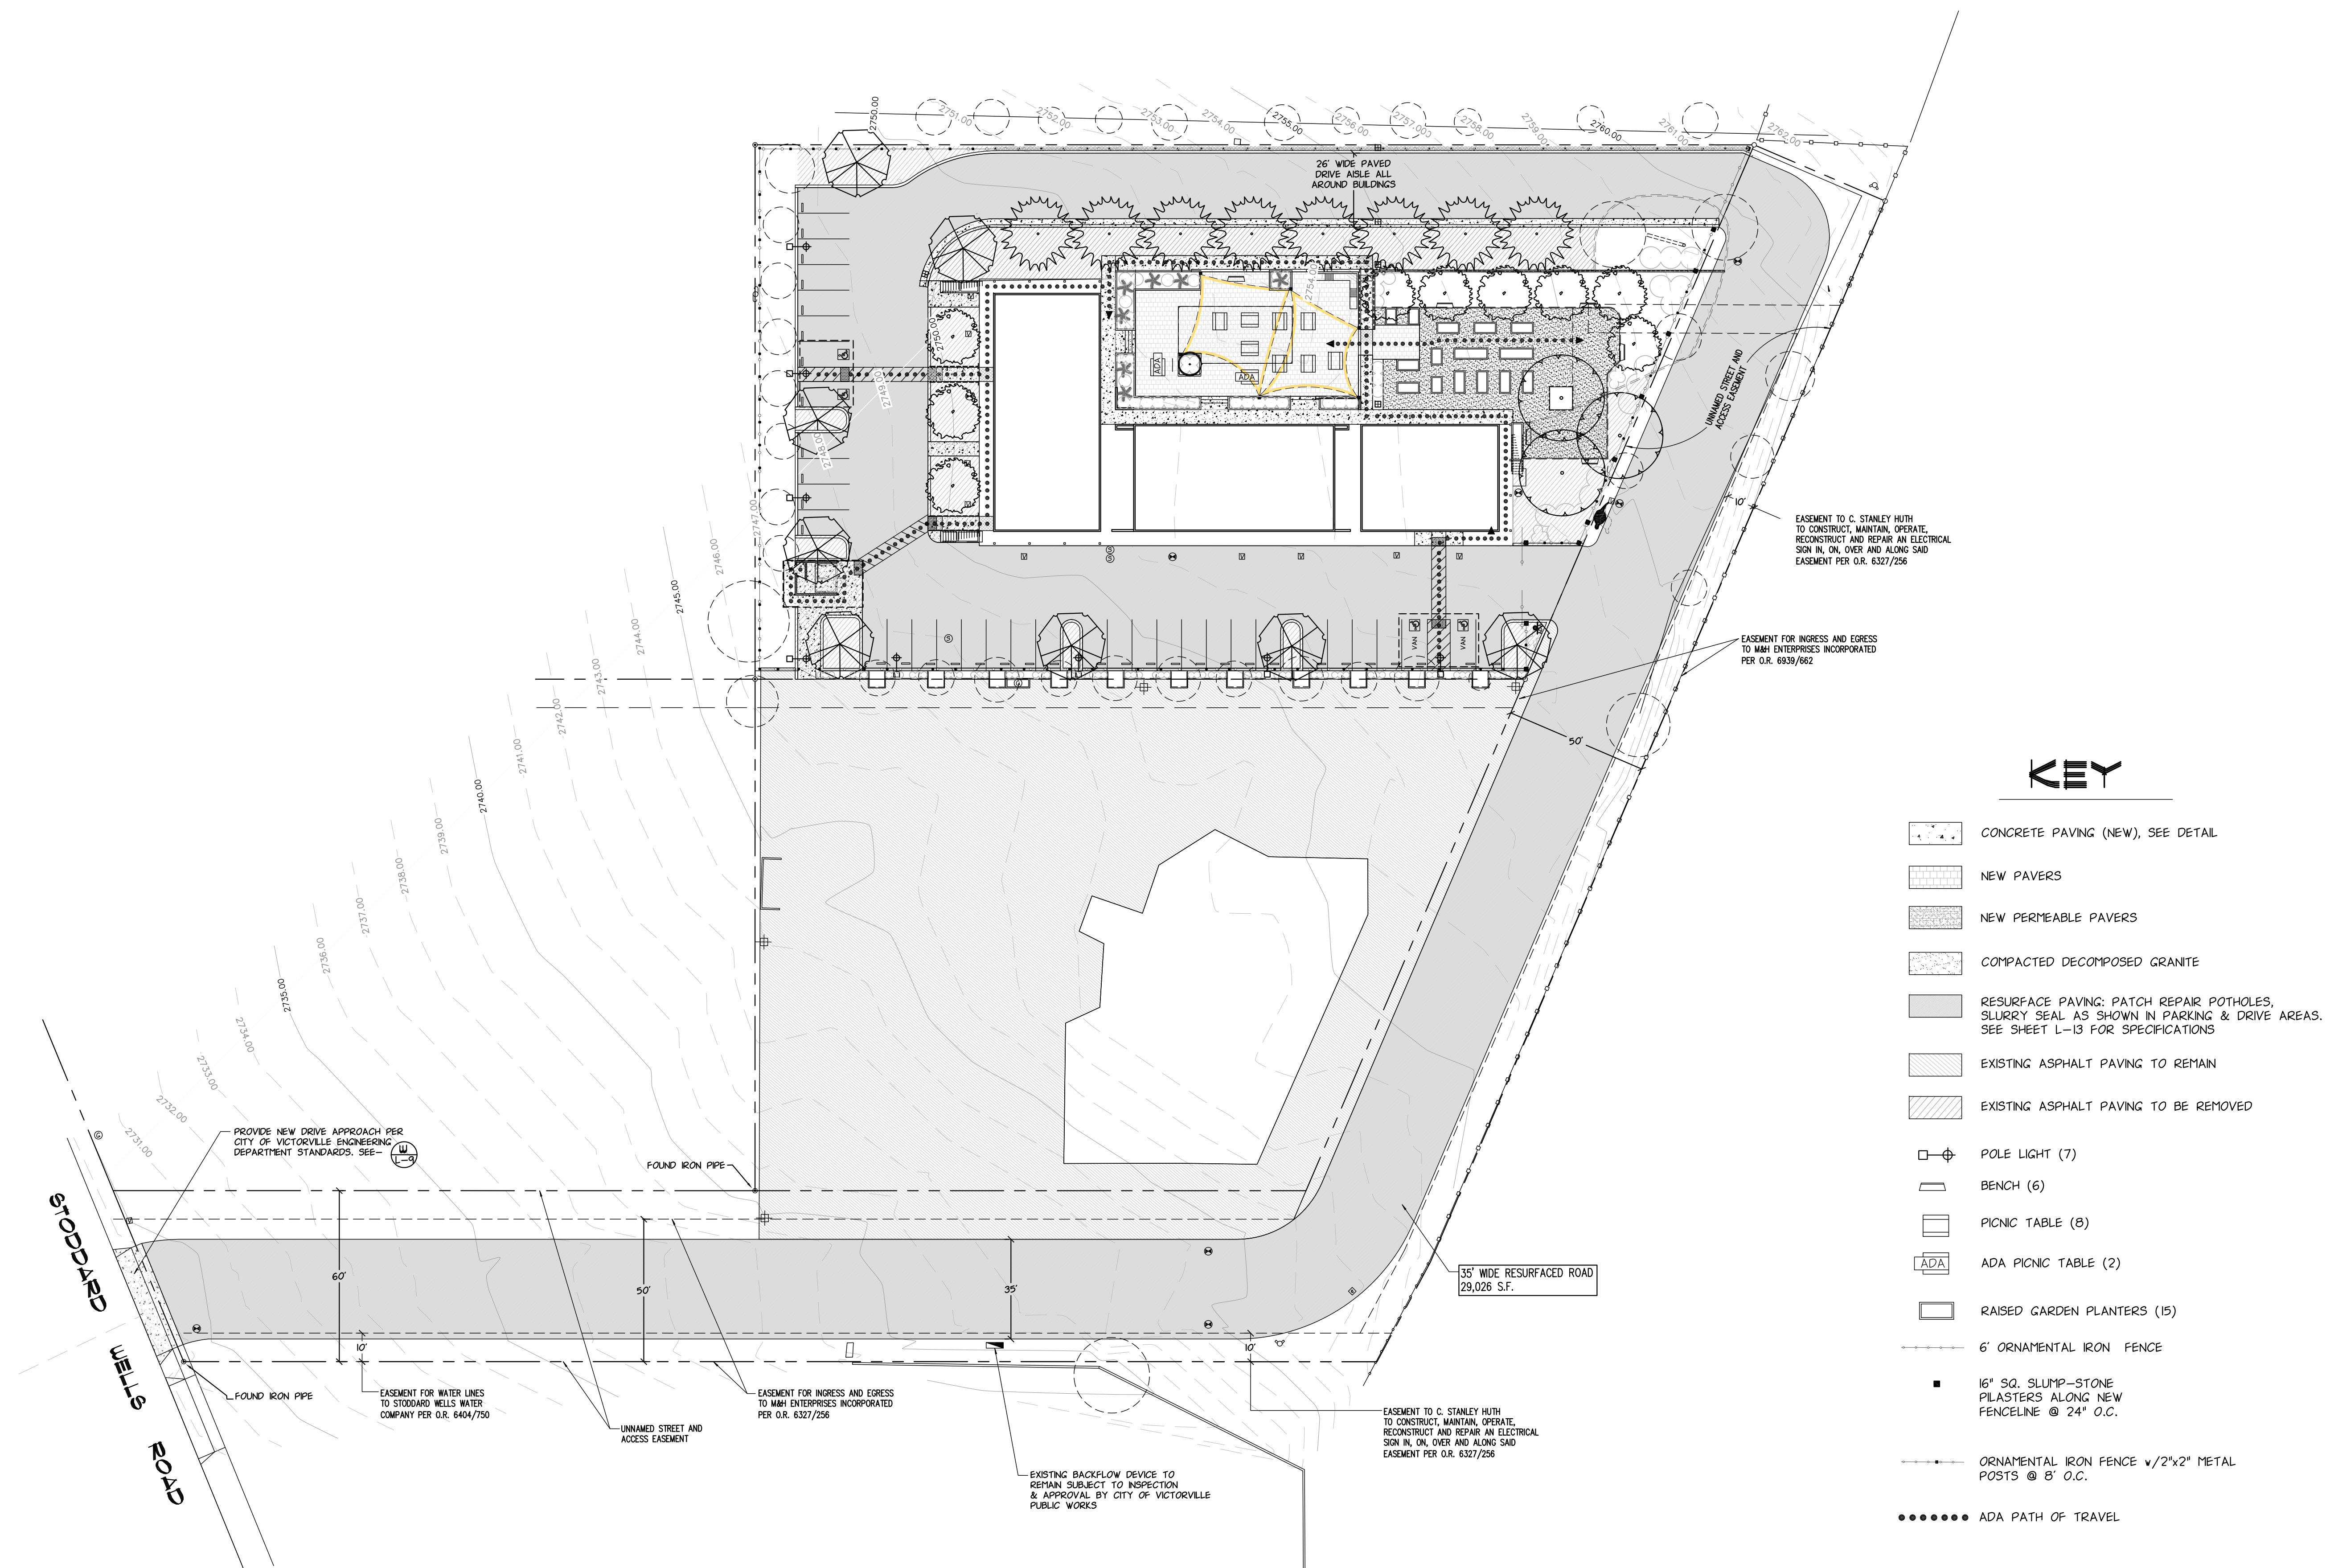

30 15 0 30
SCALE: 1"=30'
CAUTION: GRAPHIC SCALE MUST BE USED EXCEPT WHERE DIMENSIONED

[illegible]

NOTE
0 1/2 1

BAR SHOULD MEASURE
1" OR DRAWING IS
NOT TO SCALE

SCALE:
DESIGNED:
DRAWN: JRS
CHECKED:
APPROVED:

**Bisnett
Design
Associates**



16046 Bear Court
Grass Valley, CA 95949
530.277.9733
brian@bisnettdesign.com

brian@bisnetdesign.com


DESERT HAVEN APARTMENTS
VICTORYVILLE, CALIFORNIA

SITE PLAN WITH OFF-SITE IMPROVEMENTS

6-11-18

DRAWING: :

$$\begin{array}{c} | \\ \hline \end{array} = 3$$

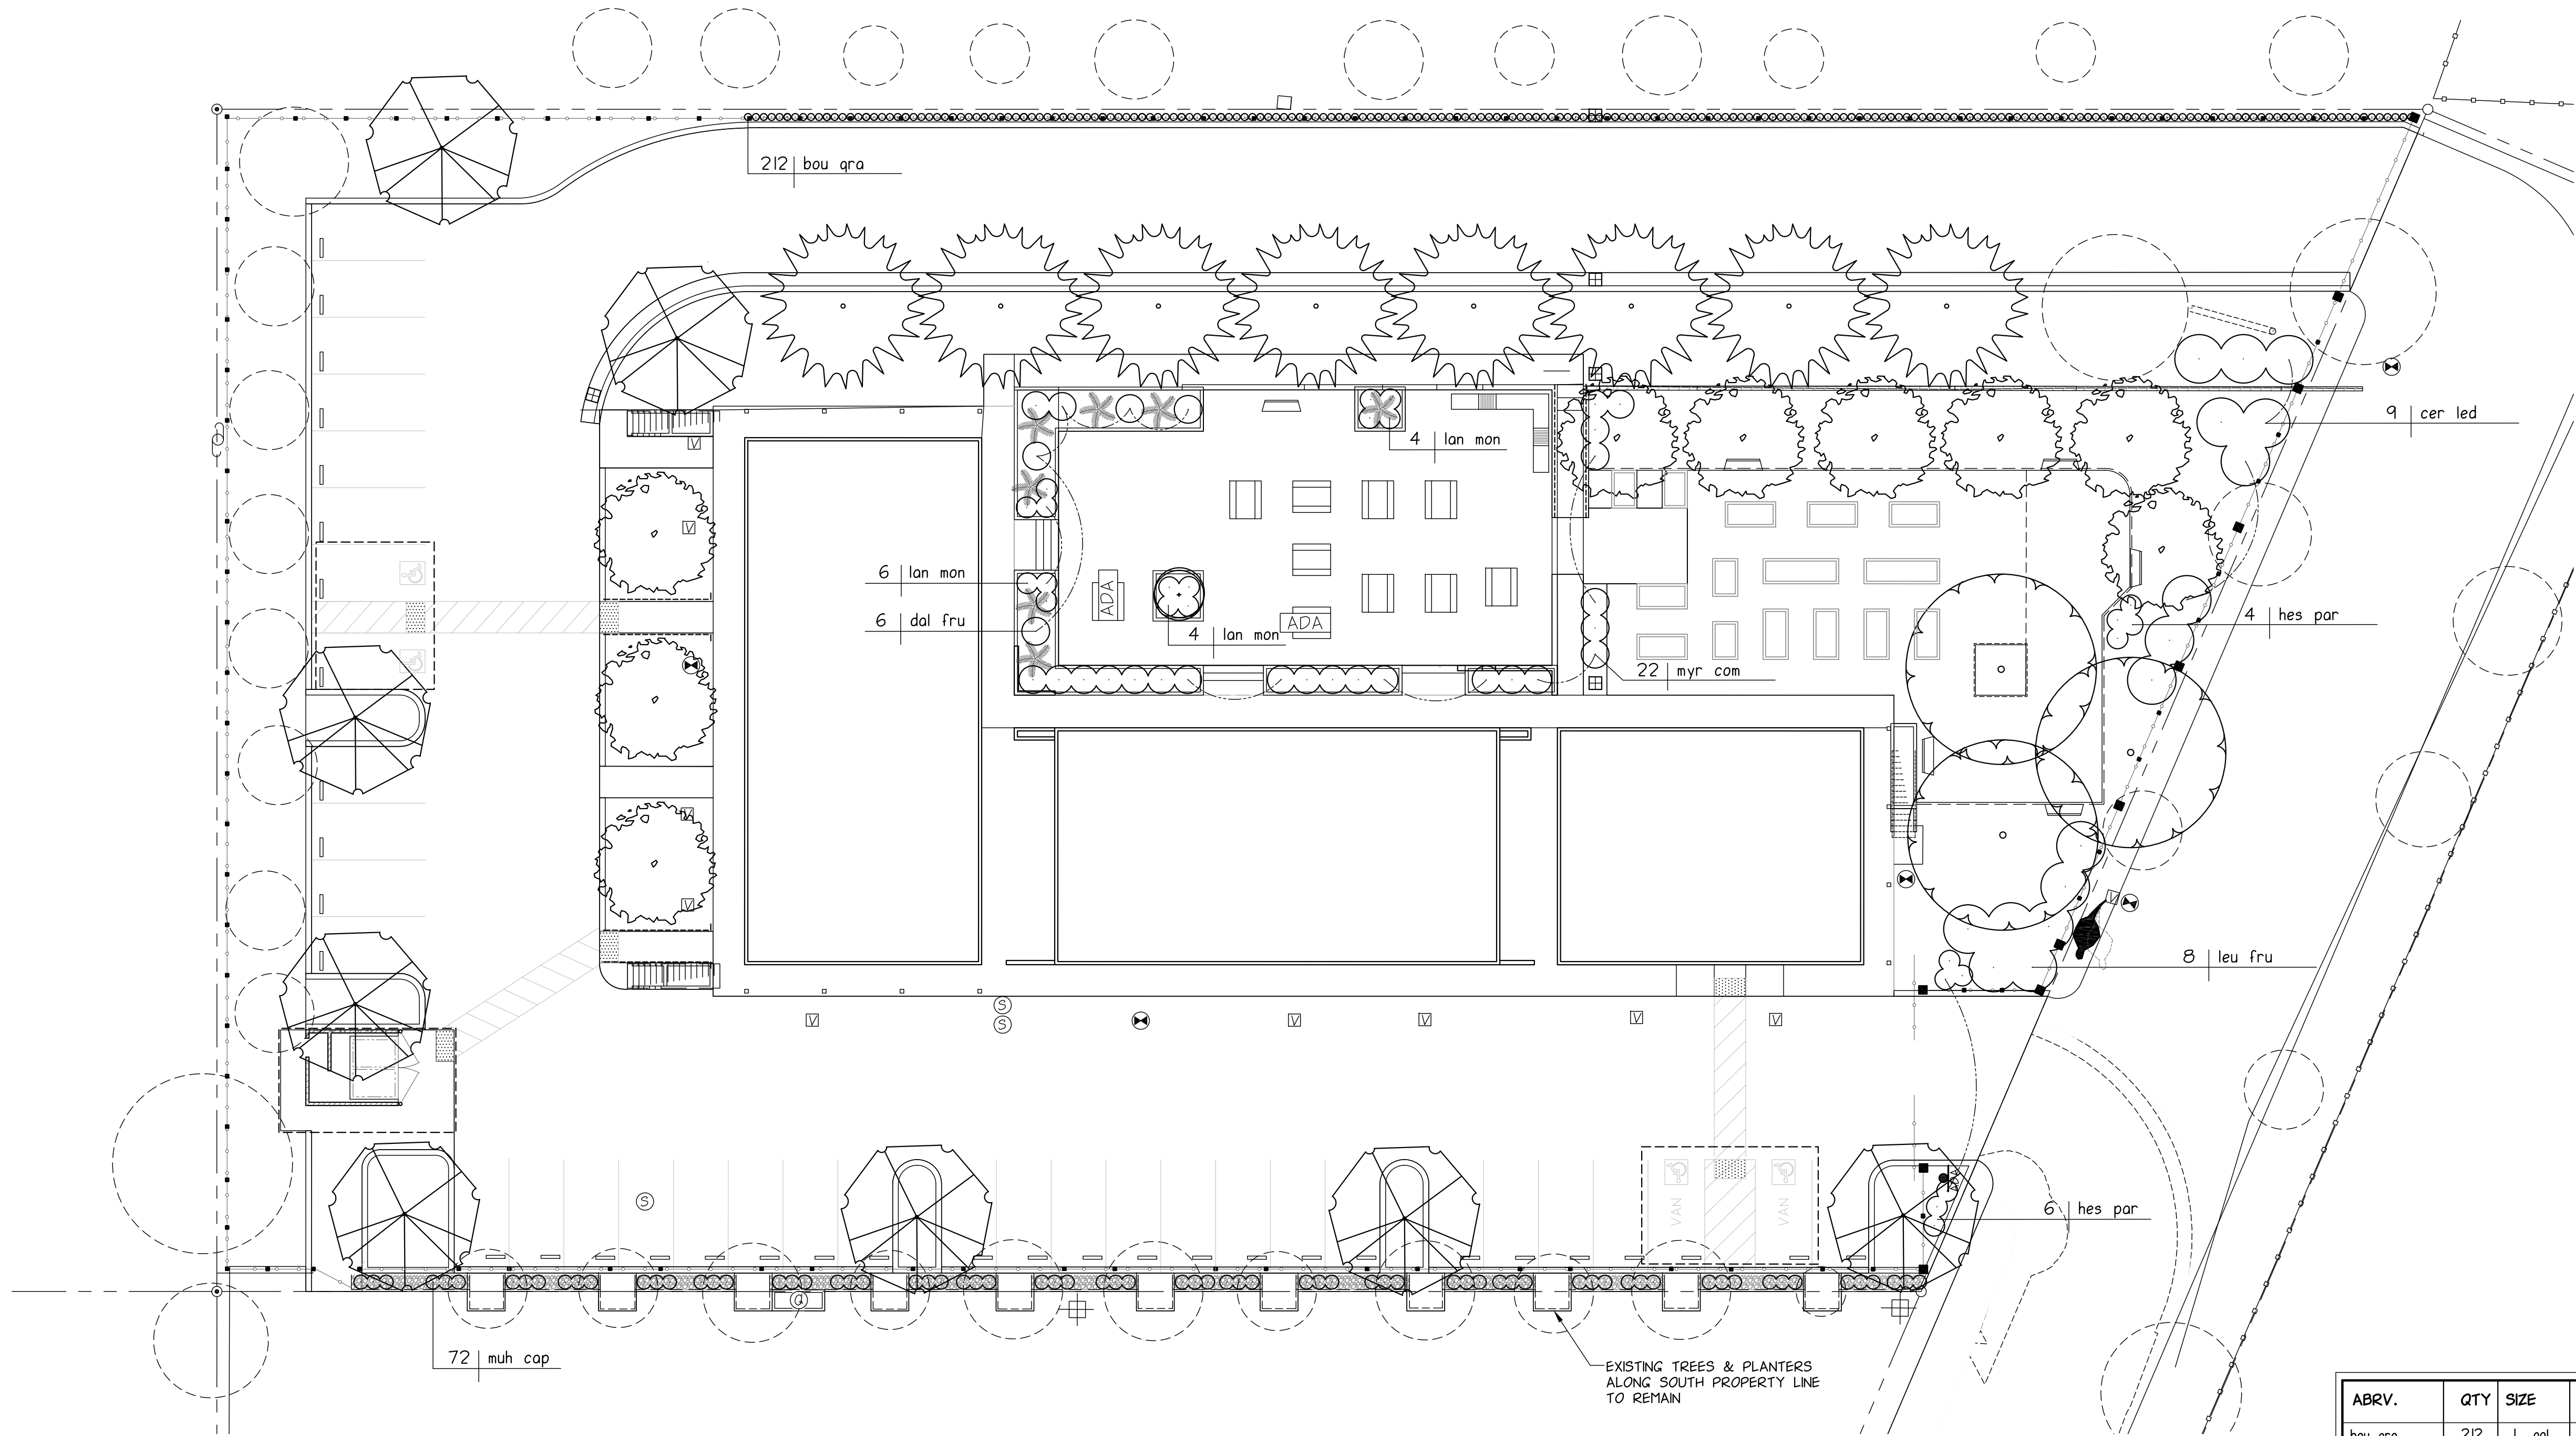

EXISTING TREES & PLANTERS
ALONG SOUTH PROPERTY LINE
TO REMAIN


PLANT LEGEND

ABRV.	QTY	SIZE	PLANT NAME	COMMON NAME	OC'	WATER USE
bou gra	212	1 gal.	Bouteloua gracilis	Blue Grama Grass	15"	L
cer led	9	5 gal.	Cercocarpus ledifolius	Curl-Leaf Mountain Mahogany	9'	L
dal fru	6	1 gal.	Dalea frutescens	Black Dalea	4'	L/M
hes par	10	1 gal.	Hesperaloe parviflora	Red Yucca	3'	L/M
lan mon	14	1 gal.	Lantana montevidensis	Lantana	3'	M
leu fru	8	5 gal.	Leucophyllum frutescens	Texas Ranger	7'	L/M
muh cap	72	1 gal.	Muhlenbergia capillaus	White Avn Muhly	2'	L
myr com	22	5 gal.	Myrtus communis	Myrtle	4'	L/M

ANY DISCREPANCY BETWEEN THE MAXIMUM SPACING CRITERIA AND THE NUMBER OF PLANTS SHOWN ON THE LANDSCAPE PLAN SHALL RESULT IN THE SPACING CRITERIA SUPERSEDING ANY OTHER INFORMATION SHOWN ON THE LANDSCAPE PLAN.

TREE LEGEND

SYMBOL	QTY	SIZE	PLANT NAME	COMMON NAME	WATER USE
	9	15 gal.	Cercidium 'Desert Museum'	Thornless Palo Verde	L/M
	7	24" box	Chamaerops humilis	Mediterranean Fan Palm	M
	8	15 gal.	Chitalpa laskhentensis 'Morning Cloud'	Chitalpa	L/M
	3	15 gal.	Quercus suber	Cork Oak	L/M
	8	15 gal.	Pinus eldarico	Afghan Pine	L/M
	1	24" box	Punica granatum 'Tanyasho'	Flowering Pomegranate	M

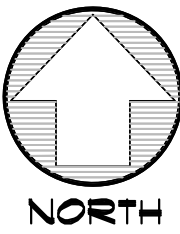

16 8 0 16
SCALE: 1"=16'
CAUTION: GRAPHIC SCALE MUST BE USED EXCEPT WHERE DIMENSIONED

DESIGNED: JPS	SCALE: 1"=16'	NOTE 0 1/2 1 BAS SHOULD MEASURE 1" OR DRAWING IS NOT TO SCALE	LAST EDIT DATE: 1 4-17-18	NO. DATE	ISSUED FOR	BY
CHECKED: JPS						
APPROVED:						
CAD REF. FILE:						

**Bisnett
Design
Associates**

bda
16445 Blue Oaks
Grass Valley, CA 95949
530.277.0733
bisnett@bisnettdesign.com


Landscape Architecture & Environmental Planning

DESERT HAVEN APARTMENTS
VICTORVILLE, CALIFORNIA

PLANTING PLAN

6-11-18

DRAWING: :
1 = 4

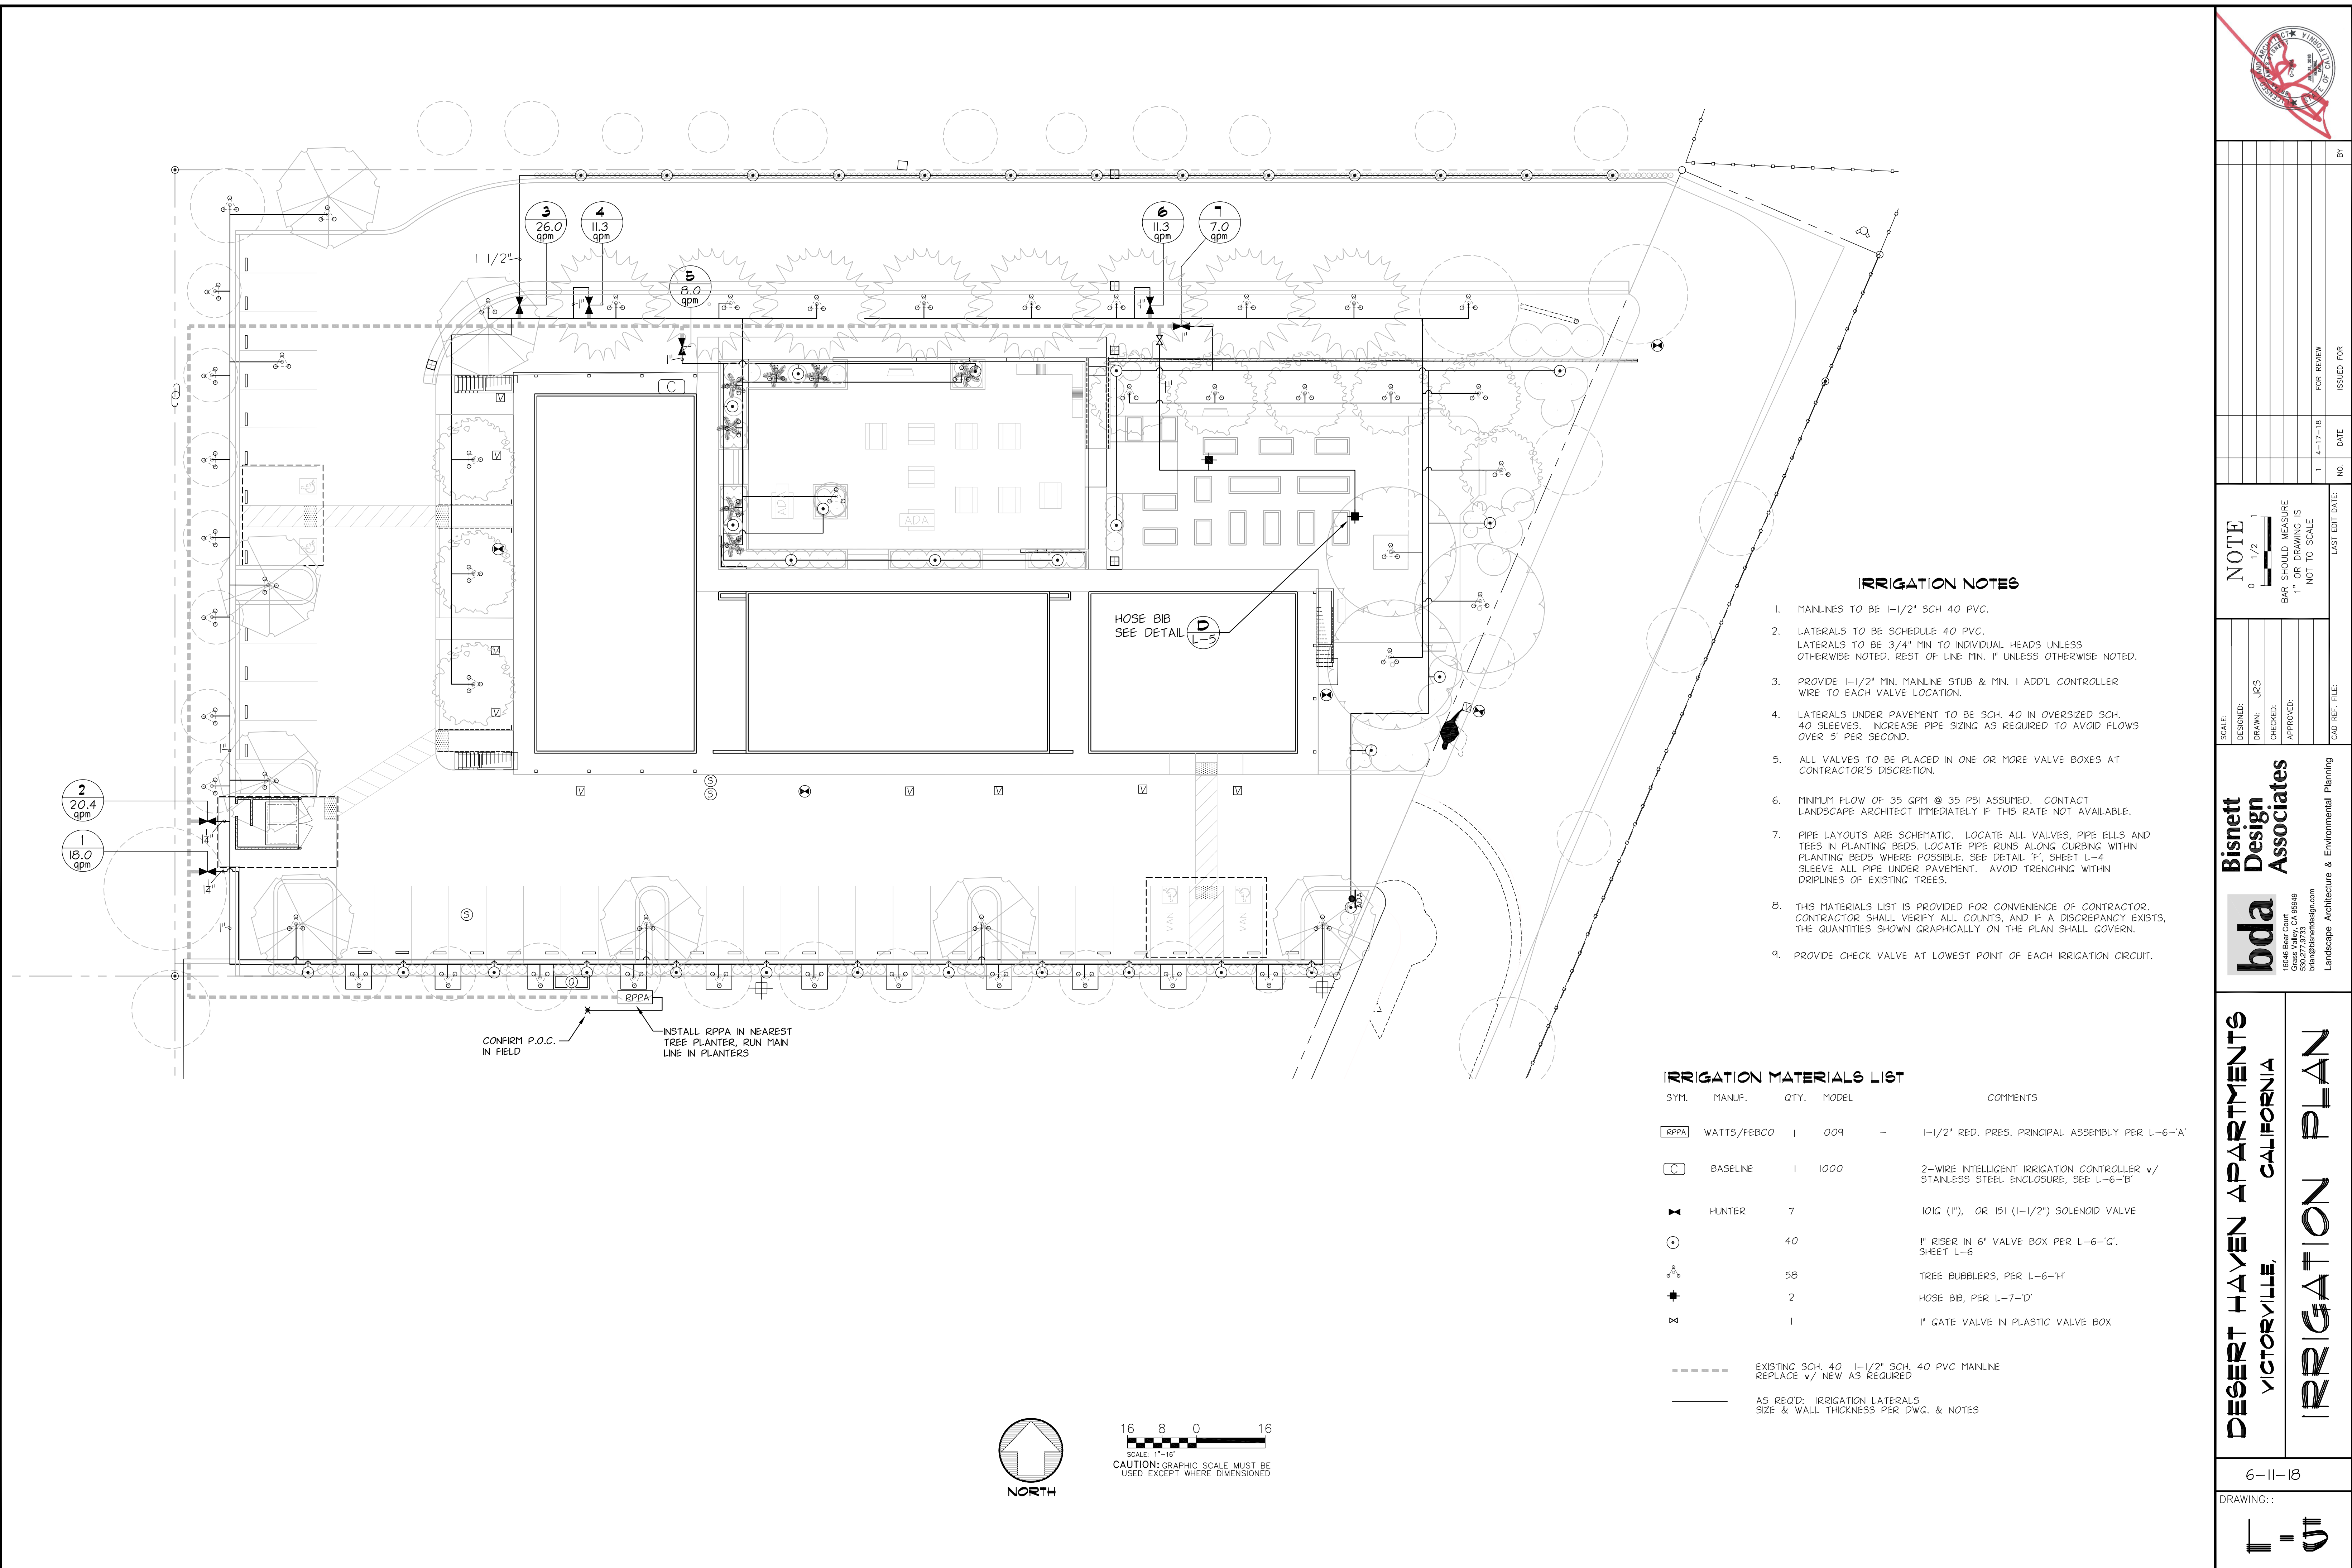

IRRIGATION NOTES

- 1. MAINLINES TO BE 1-1/2" SCH 40 PVC.
- 2. LATERALS TO BE SCHEDULE 40 PVC. LATERALS TO BE 3/4" MIN TO INDIVIDUAL HEADS UNLESS OTHERWISE NOTED. REST OF LINE MIN. 1" UNLESS OTHERWISE NOTED.
- 3. PROVIDE 1-1/2" MIN. MAINLINE STUB & MIN. 1 ADD'L CONTROLLER WIRE TO EACH VALVE LOCATION.
- 4. LATERALS UNDER PAVEMENT TO BE SCH. 40 IN OVERSIZED SCH. 40 SLEEVES. INCREASE PIPE SIZING AS REQUIRED TO AVOID FLOWS OVER 5' PER SECOND.
- 5. ALL VALVES TO BE PLACED IN ONE OR MORE VALVE BOXES AT CONTRACTOR'S DISCRETION.
- 6. MINIMUM FLOW OF 35 GPM @ 35 PSI ASSUMED. CONTACT LANDSCAPE ARCHITECT IMMEDIATELY IF THIS RATE NOT AVAILABLE.
- 7. PIPE LAYOUTS ARE SCHEMATIC. LOCATE ALL VALVES, PIPE ELLS AND TEES IN PLANTING BEDS. LOCATE PIPE RUNS ALONG CURBING WITHIN PLANTING BEDS WHERE POSSIBLE. SEE DETAIL 'F', SHEET L-4 SLEEVE ALL PIPE UNDER PAVEMENT. AVOID TRENCHING WITHIN DRIPLINES OF EXISTING TREES.
- 8. THIS MATERIALS LIST IS PROVIDED FOR CONVENIENCE OF CONTRACTOR. CONTRACTOR SHALL VERIFY ALL COUNTS, AND IF A DISCREPANCY EXISTS, THE QUANTITIES SHOWN GRAPHICALLY ON THE PLAN SHALL GOVERN.
- 9. PROVIDE CHECK VALVE AT LOWEST POINT OF EACH IRRIGATION CIRCUIT.

IRRIGATION MATERIALS LIST

SYM.	MANUF.	QTY.	MODEL	COMMENTS
[RPPA]	WATTS/FEBCO	1	009	1-1/2" RED. PRES. PRINCIPAL ASSEMBLY PER L-6-'A'
[C]	BASLINE	1	1000	2-WIRE INTELLIGENT IRRIGATION CONTROLLER w/ STAINLESS STEEL ENCLOSURE, SEE L-6-'B'
[X]	HUNTER	7		10IG (1"), OR 15I (1-1/2") SOLENOID VALVE
[O]		40		1" RISER IN 6" VALVE BOX PER L-6-'G'. SHEET L-6
[B]		58		TREE BUBBLERS, PER L-6-'H'
[H]		2		HOSE BIB, PER L-7-'D'
[V]		1		1" GATE VALVE IN PLASTIC VALVE BOX
---	EXISTING SCH. 40 1-1/2" SCH. 40 PVC MAINLINE REPLACE w/ NEW AS REQUIRED			
---	AS REQ'D: IRRIGATION LATERALS SIZE & WALL THICKNESS PER DWG. & NOTES			

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JRS	JRS		
CAD REF. FILE:			

NOTE: 0 1/2 1
BAS SHOULD MEASURE 1" OR DRAWING IS NOT TO SCALE

1 4-17-18 FOR REVIEW
NO. DATE ISSUED FOR

BY

Bisnett Design Associates

bda

16445 Bldg. 200
Grass Valley, CA 95949
530.277.2733
bisnett@bisnettdesign.com

Landscape Architecture & Environmental Planning

DESERT HAVEN APARTMENTS
VICTORVILLE, CALIFORNIA



IRRIGATION PLAN

6-11-18


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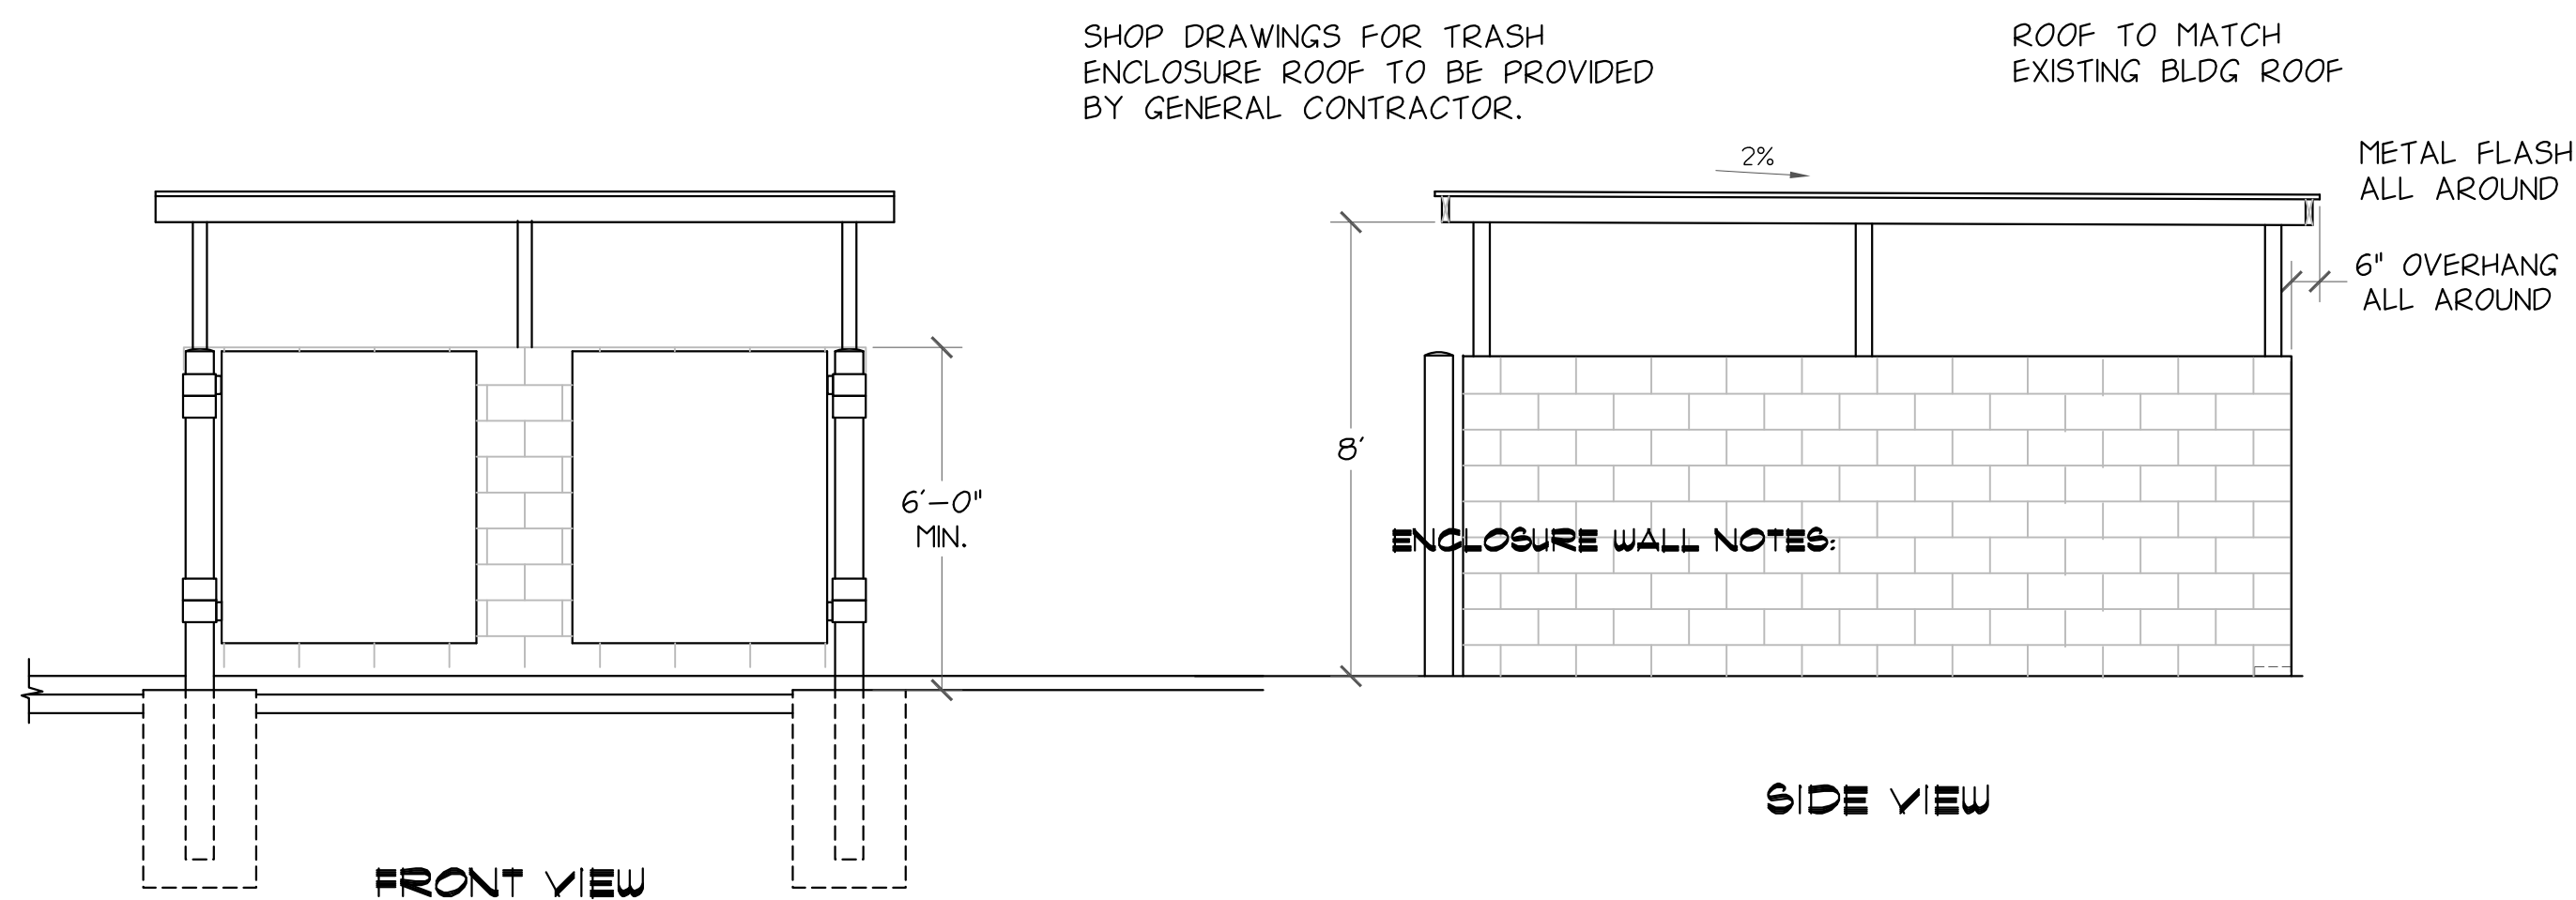






-
- The image contains three technical drawings of wheelchair ramps. The top left drawing is a side elevation of a ramp with a level landing. It shows a ramp with a maximum slope of 1/4" per foot, a level landing with a width of 27" maximum, and a typical unit of construction (UON) of 12". The top right drawing is an end view of a ramp, showing a width of 34" to 38", a height of 1 1/2" to 2", and a minimum clearance of 4" to 4 1/2" from the curb. The bottom left drawing is a side elevation of a ramp with a level landing, showing a typical UON of 12" and a maximum slope of 1/4" per foot. The bottom right drawing is an end view of a ramp, showing a width of 34" to 38", a height of 1 1/2" to 2", and a minimum clearance of 4" to 4 1/2" from the curb.
- LEVEL RAMP LEVEL
- 12" TYP. UON 12" TYP. UON 27" MAX
- OPTIONAL (VERSION #1) 2" CONC. CURB- BOTH SIDES
- OPTIONAL (VERSION #2) WHEEL GUIDE- BOTH SIDES
- Ø 1 1/2" - 2" 34" - 38" 4" MIN 4 1/2" MIN 8" MIN RAMP
- VERSION #1 W/ CURB
1. LEVEL LANDING 1/4" PER FOOT MAX. SLOPE
- 1.1. THERE SHALL BE A LEVEL & CLEAR FLOOR OR LANDING ON EA. SIDE OF EXIT DOOR.
2. THE LENGTH OF LEVEL AREA IN THE DIRECTION OF DOOR SWING 60" & 44" IN THE OPPOSITE DIRECTION.
3. THE WIDTH OF THE LEVEL AREA ON THE SIDE TO WHICH THE DOOR SWINGS SHALL EXTEND 24" PAST THE STRIKE EDGE OF THE DOOR FOR EXTERIOR & 18" PAST THE STRIKE FOR INTERIOR DOORS.
4. USE VERSION #1 OR #2, CURBS OR WHEEL GUIDES REQUIRED, BOTH
- Ø 1 1/2" - 2" 34" - 38" 4" MIN 4 1/2" MIN RAMP
- VERSION #2 W/ WHEEL GUIDES

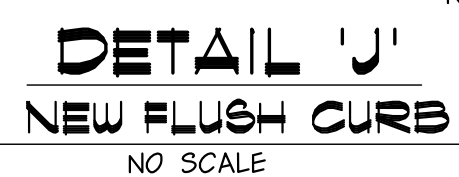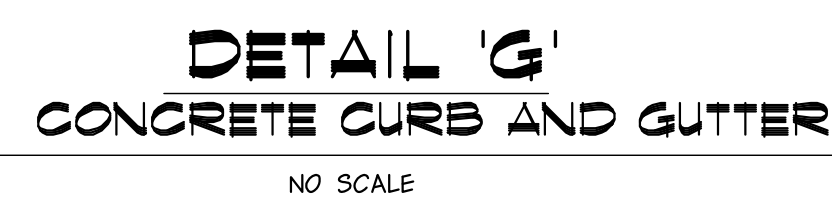

1. CURBS & CURBS AND GUTTERS SHALL BE CONSTRUCTED FROM PORTLAND CEMENT CONCRETE CONTAINING NOT LESS THAN 550 POUNDS OF TYPE II PORTLAND CEMENT PER CUBIC YARD WITH 4% AIR ENTRAINMENT AND 1" MAXIMUM AGGREGATE GRADING.
2. CONCRETE SHALL BE CURED WITH WHITE PIGMENTED CURING COMPOUND.
3. CURB AND GUTTER SHALL BE CONSTRUCTED ON MINIMUM 4" CLASS 2 AGGREGATE BASE COMPACTED TO 95% RELATIVE COMPACTION.
4. WHEN USED ADJACENT TO VEHICULAR TRAFFIC, CURB SHALL BE CONSTRUCTED ON MINIMUM 4" CLASS 2 AGGREGATE BASE COMPACTED TO 95% RELATIVE COMPACTION.
5. WEAKENED PLANE JOINTS SHALL BE CONSTRUCTED AT 10' INTERVALS.
6. WEAKENED PLANE JOINTS SHALL BE AT LEAST 2" DEEP.
7. EXPANSION JOINTS SHALL BE CONSTRUCTED AT ALL CURB RETURNS, DRIVEWAY APPROACHES AND AT 60' INTERVALS.
8. EXPANSION JOINTS SHALL BE 1/2" WIDE AND FILLED WITH PLASTIC TYPE FILLERS.
9. IF EXISTING CURB IS TO BE REMOVED, IT SHALL BE SCORED AT LEAST 1" DEEP WITH A CONCRETE SAW PRIOR TO REMOVAL. IF THE SAWCUT LINE IS CLOSER THAN 2" TO A WEAKENED PLANE JOINT OR EXPANSION JOINT, THE CURB SHALL BE REMOVED TO THE WEAKENED PLANE JOINT OR EXPANSION JOINT.
10. GUTTER SHALL HAVE ROUGH BROOM FINISH WITH 2" SHINER AT FLOW LINE.



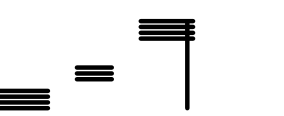

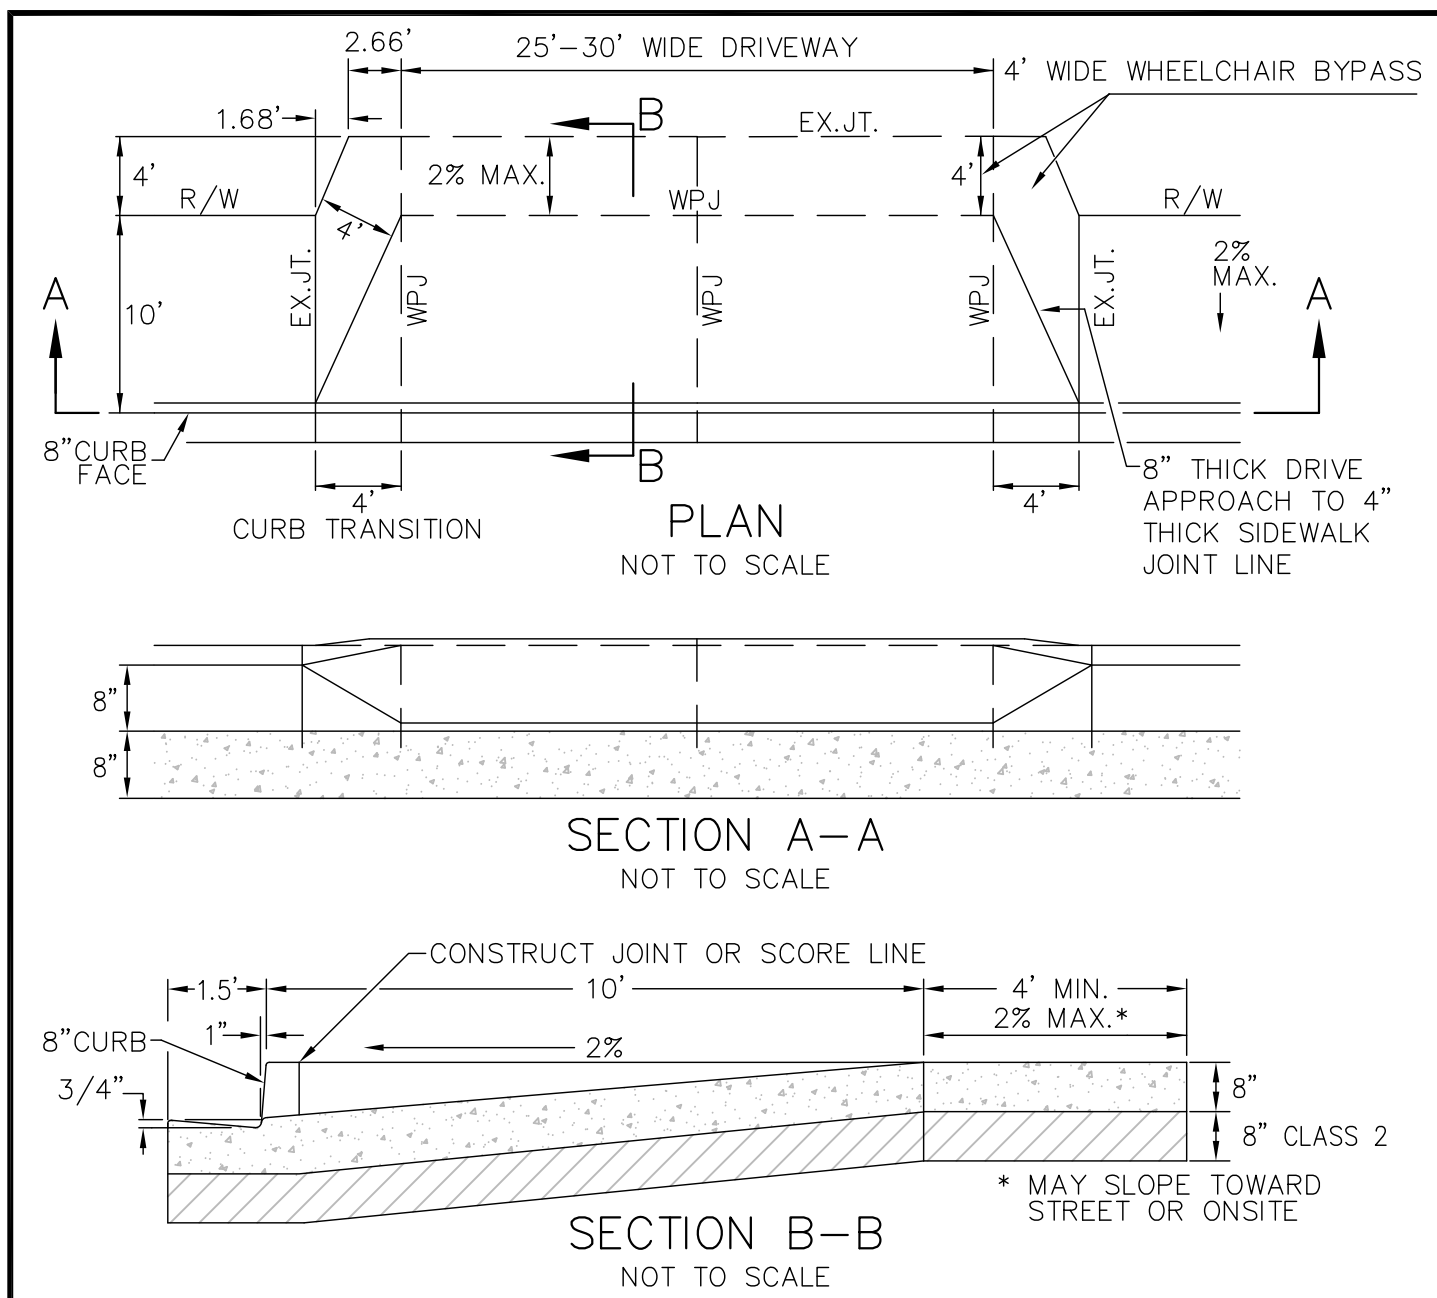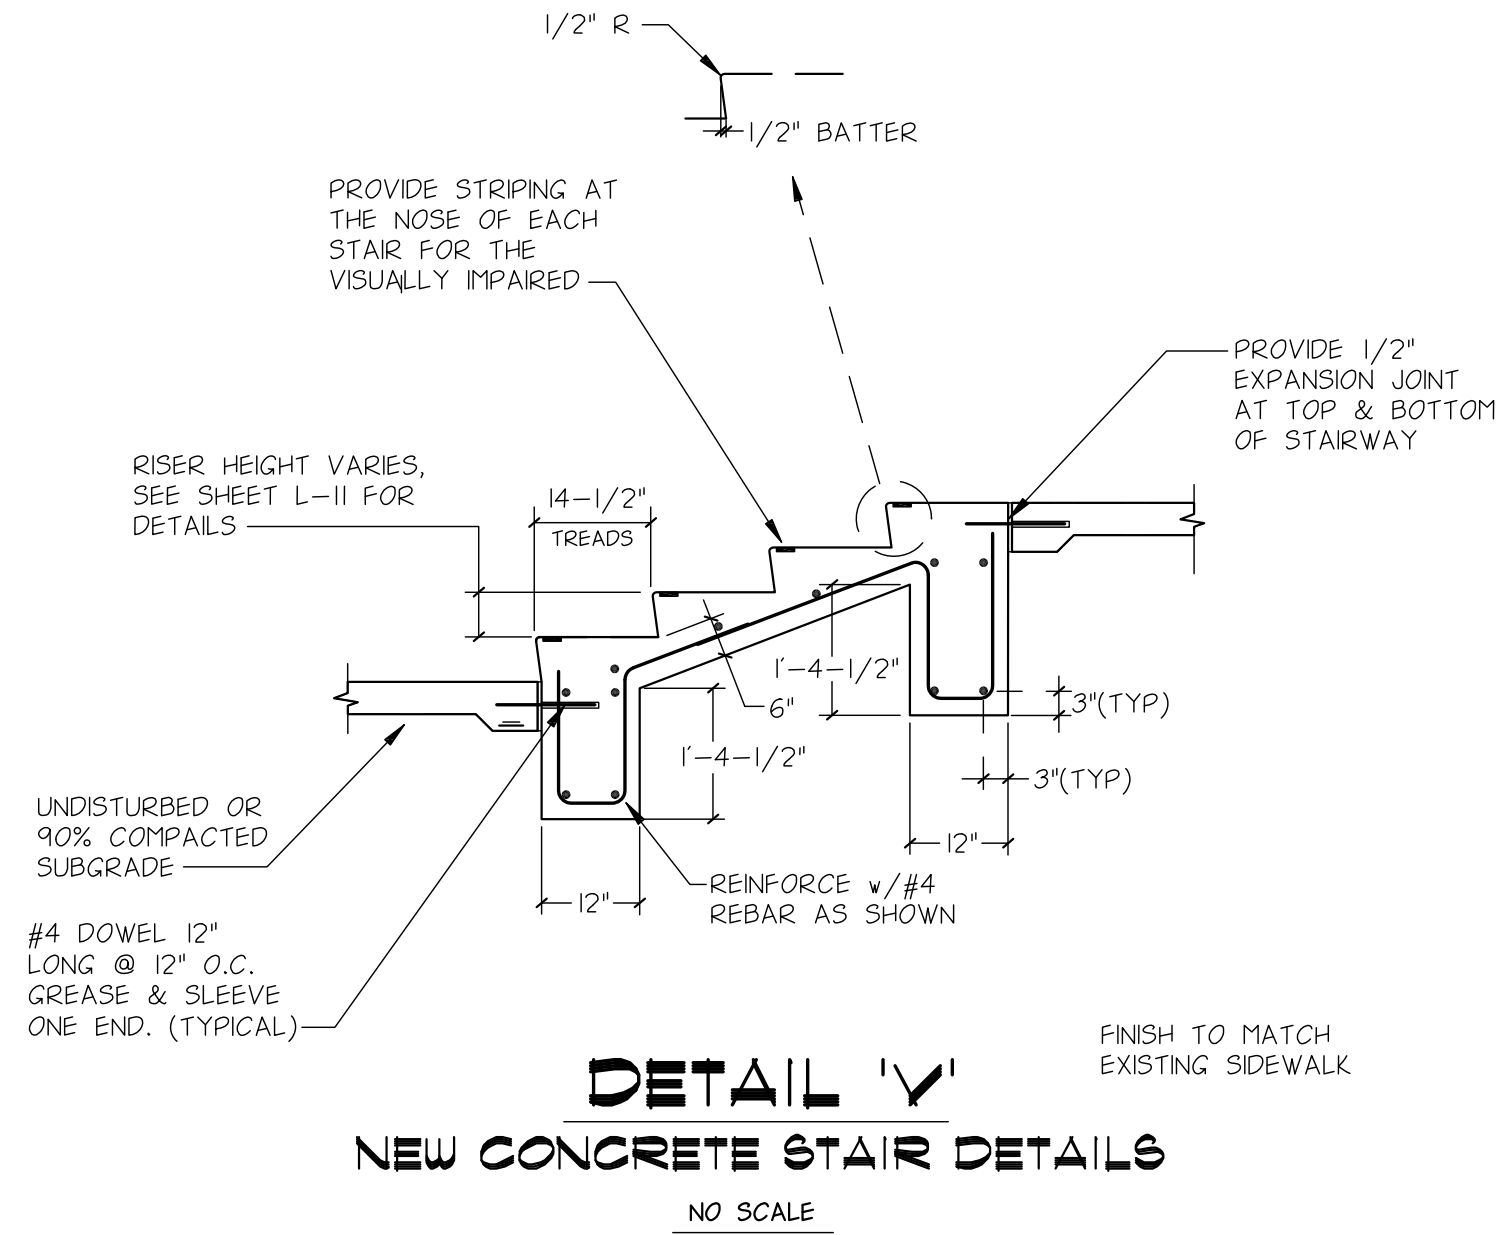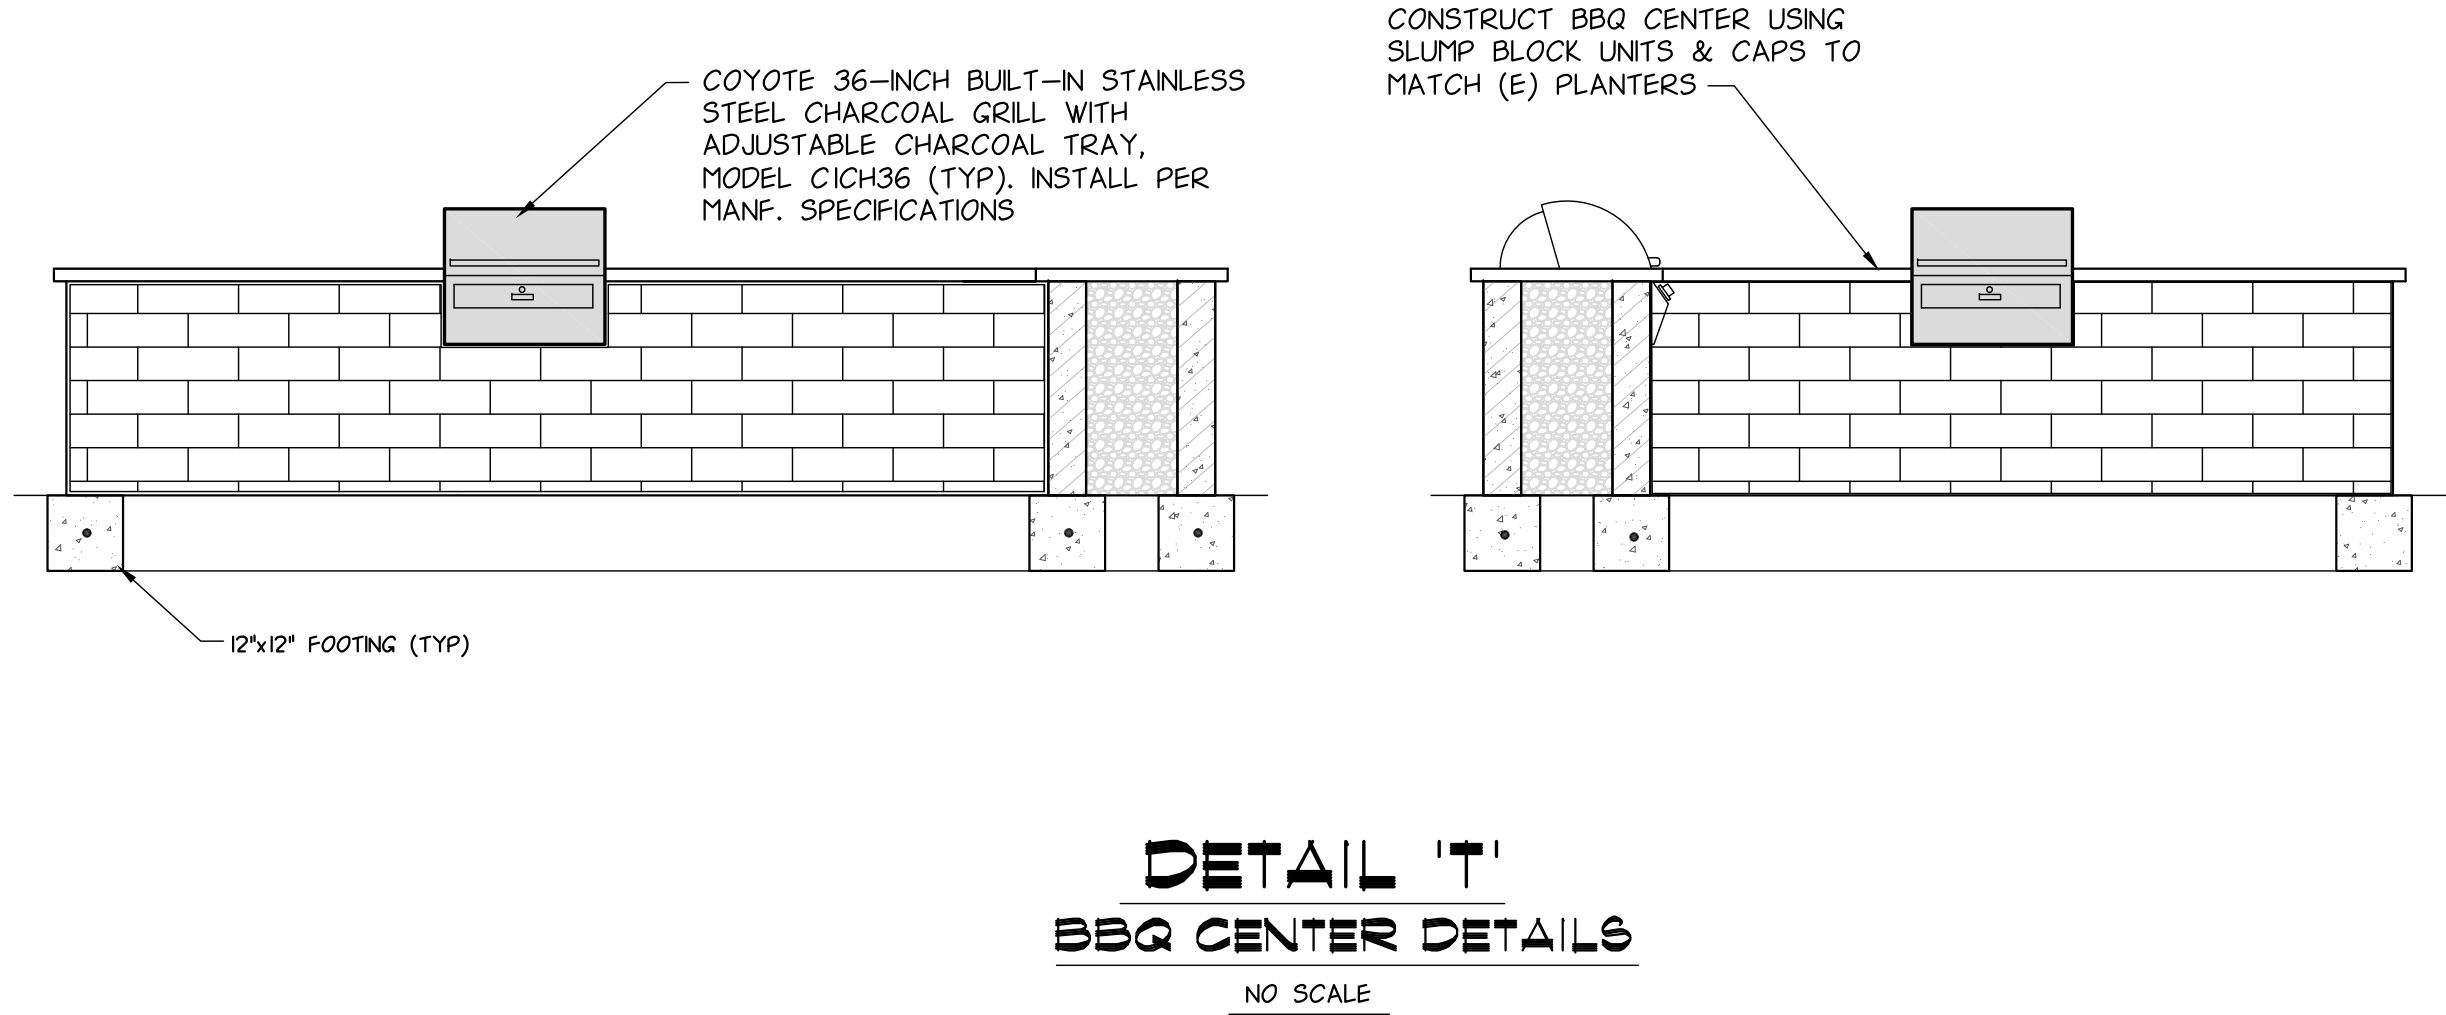
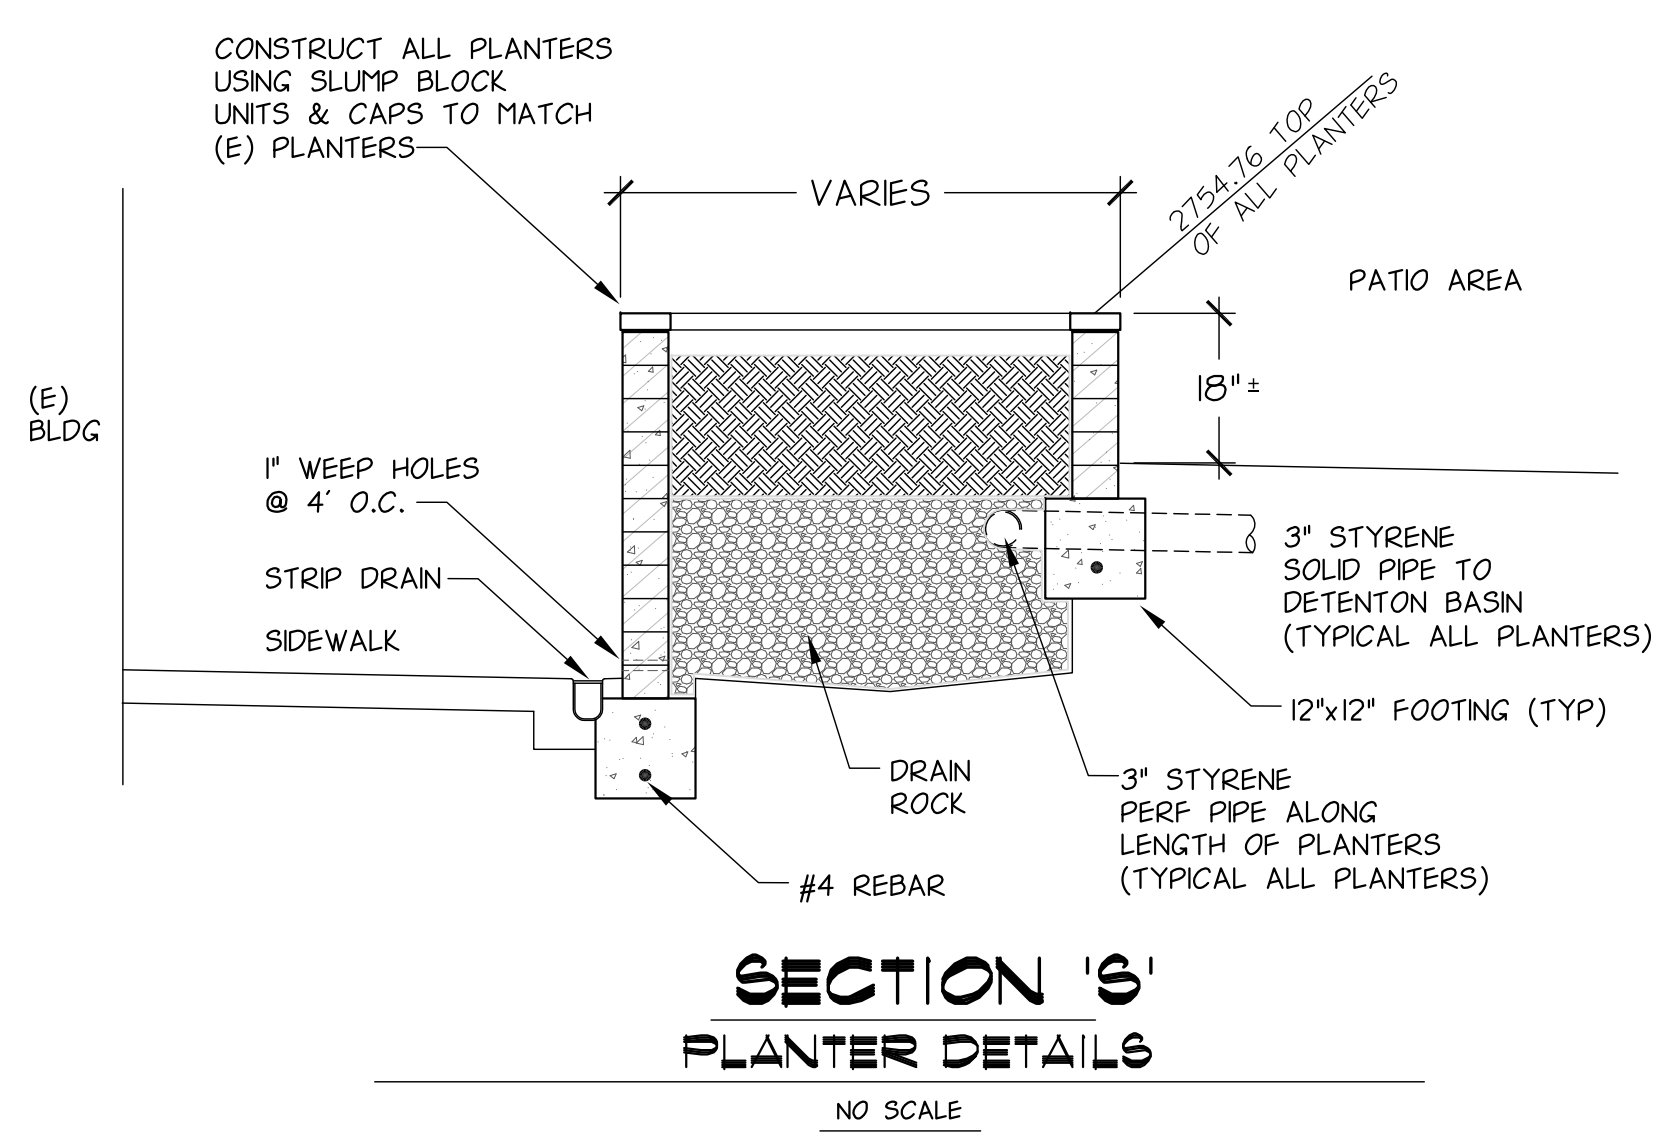


NOTES:

1. COMMERCIAL DRIVE APPROACH SHALL BE CONSTRUCTED FROM PORTLAND CEMENT CONCRETE CONTAINING NOT LESS THAN 550 POUNDS OF TYPE II PORTLAND CEMENT PER CUBIC YARD WITH 4% AIR ENTRAINMENT AND 1" MAXIMUM AGGREGATE GRADING.
2. CONCRETE SHALL BE CURED WITH WHITE PIGMENTED CURING COMPOUND.
3. COMMERCIAL DRIVE APPROACH SHALL BE CONSTRUCTED ON MINIMUM 8" CLASS 2 AGGREGATE BASE COMPACTED TO 95% RELATIVE COMPACTION.
4. WEAKENED PLANE JOINTS SHALL BE AT LEAST 2" DEEP.
5. EXPANSION JOINTS SHALL BE CONSTRUCTED AT BOTH ENDS OF DRIVEWAY APPROACHES.
6. EXPANSION JOINTS SHALL BE 1/2" WIDE AND FILLED WITH PLASTIC TYPE FILLERS.
7. COMMERCIAL DRIVE APPROACH SHALL BE MEDIUM BROOM FINISH.

CITY OF VICTORVILLE - ENGINEERING DEPARTMENT			
REV.	DATE	BY	
1	6/1/07	STAFF	STANDARD COMMERCIAL DRIVE APPROACH (TYPE 1)
2	11/20/08	STAFF	JOHN A. McGLADE, CITY ENGINEER
			S-03
			SHEET 1 OF 3

DETAIL 'W'
DRIVE APPROACH ON STODDARD WELLS
NO SCALE

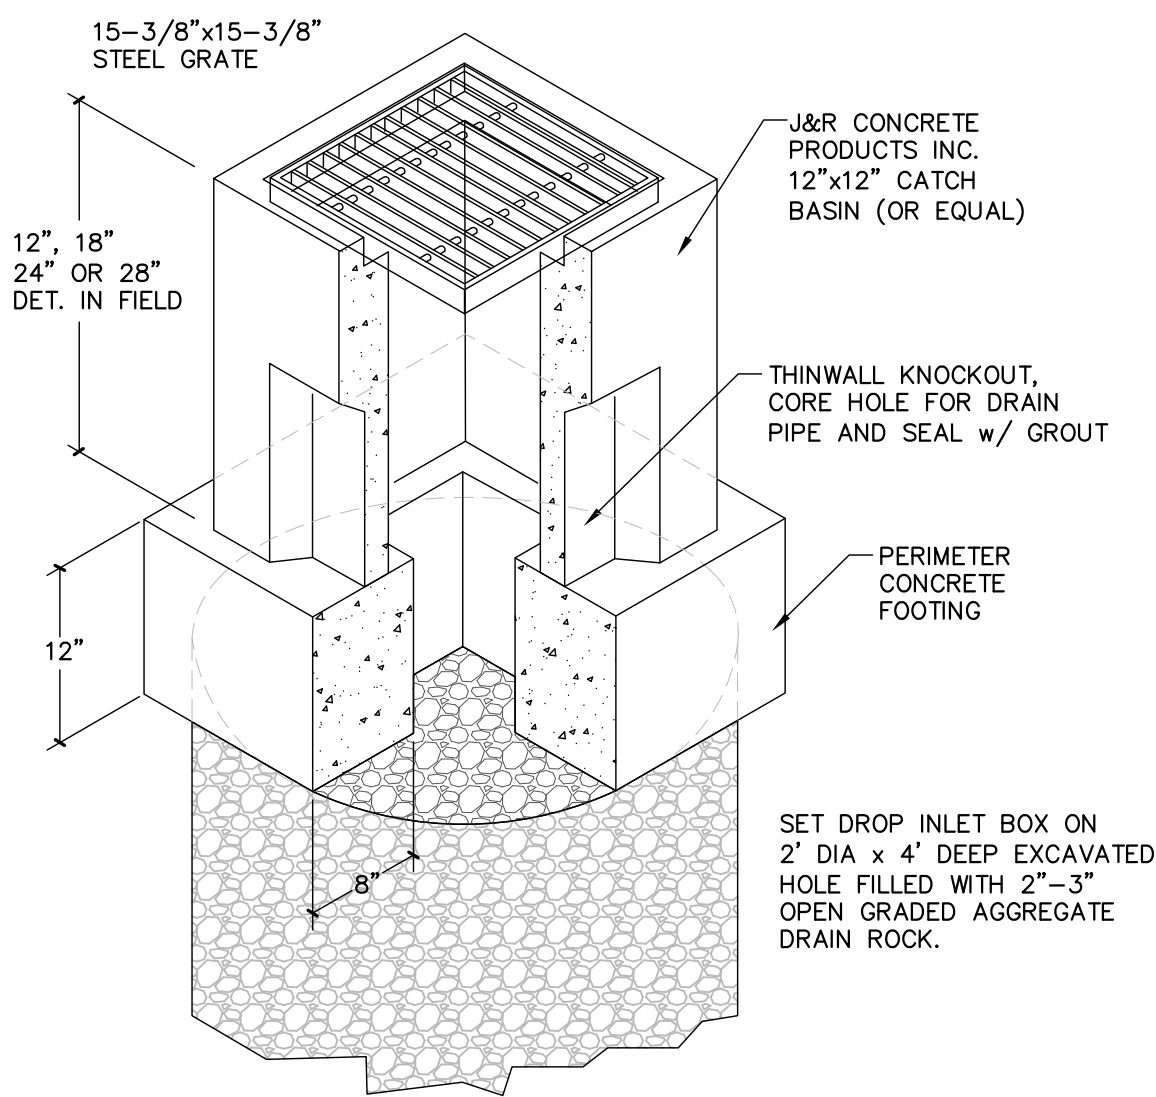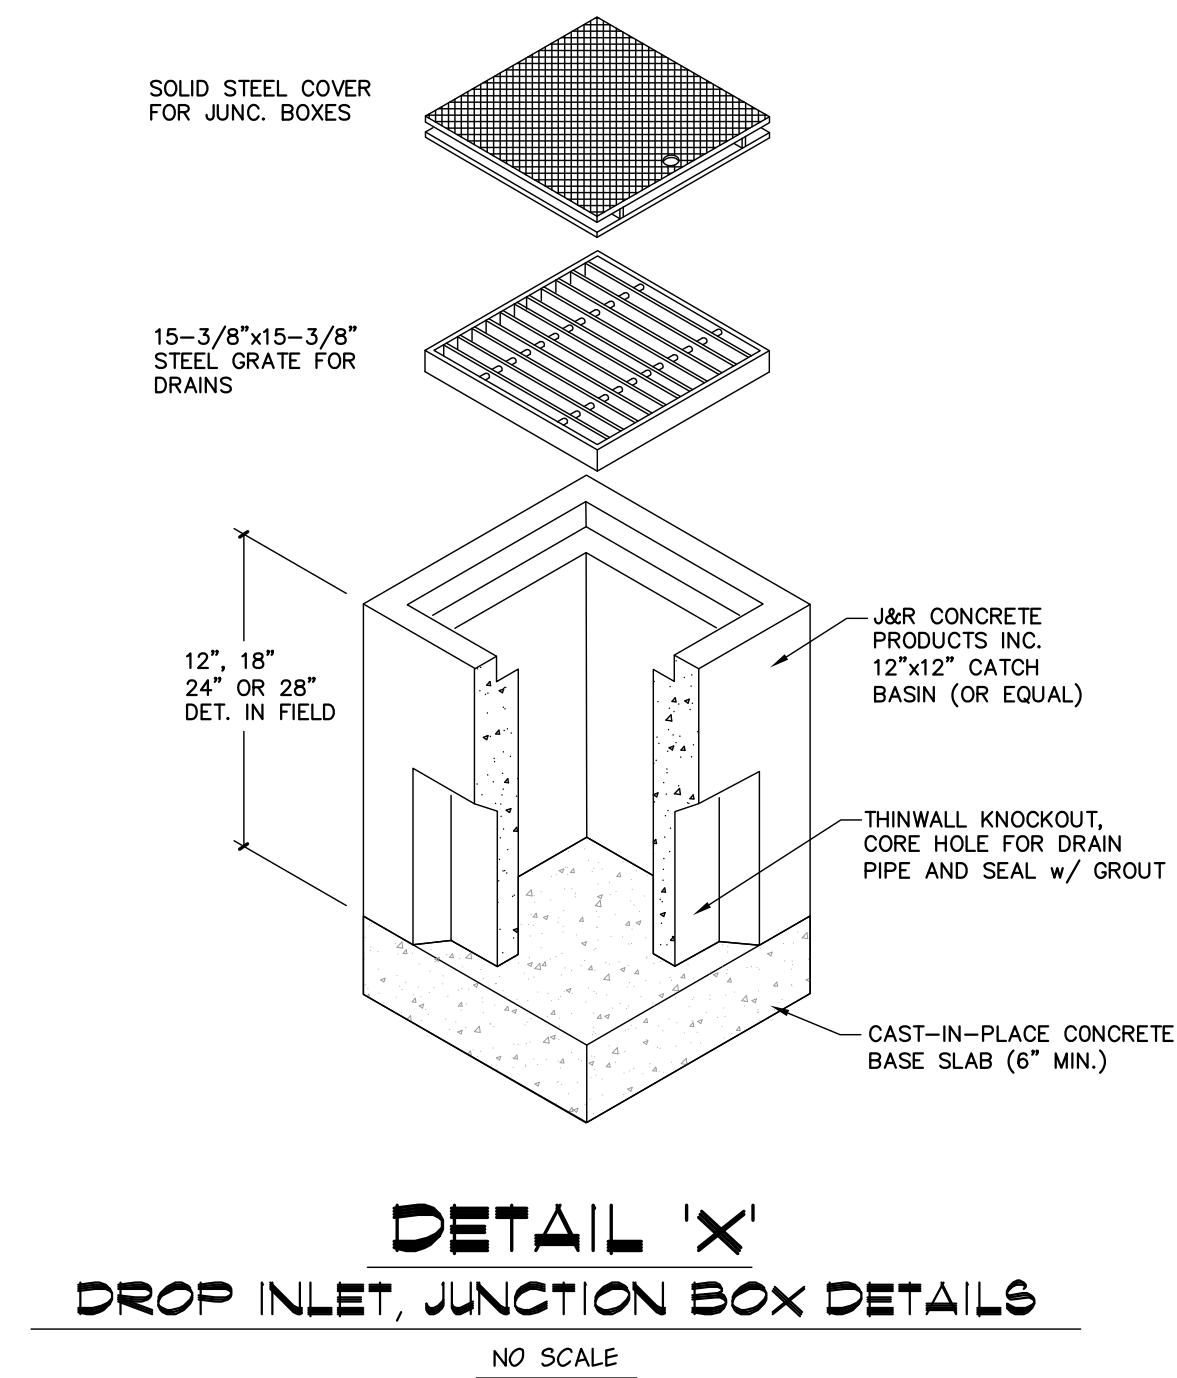


UNAUTHORIZED VEHICLE WARNING SIGN (CA ONLY)

1. SIGN IS TO BE POSTED AT EACH ENTRANCE TO THE OFF-STREET PARKING FACILITIES, OR POSTED AT EACH ACCESSIBLE PARKING STALL.
2. THE PHONE NUMBER AND ADDRESS WHERE TOWED VEHICLES CAN BE RECLAIMED IS POSTED AND A PERMANENT PART OF THE SIGN.
3. LETTERS MUST BE 1" MIN IN HEIGHT.
4. SIGN IS NOT LESS THAN 17" BY 22".


PARKING SPACE SIGNAGE

1. POST SIGNAGE AT EACH ACCESSIBLE SPACE.
2. AREA OF SIGN IS NOT SMALLER THAN 70 SQUARE INCHES.
3. WHEN POSTED IN A PATH OF TRAVEL, BOTTOM OF SIGN IS 80" MIN FROM FINISHED GRADE.
4. POST ADDITIONAL SIGN AT VAN ACCESSIBLE SPACES STATING "VAN ACCESSIBLE" BELOW SYMBOL OF ACCESSIBILITY .
5. REFLECTORIZED SIGN CONSTRUCTED OF PORCELAIN STEEL WITH BEADED TEXT OR EQUAL.
6. SIGN TO BE CENTERED AT THE INTERIOR END OF THE PARKING SPACE.
7. TEXT AND ACCESSIBILITY SYMBOL TO BE WHITE ON DARK BLUE BACKGROUND.
8. POST ADDITIONAL SIGN STATING "MINIMUM FINE \$250" BELOW THE SYMBOL OF ACCESSIBILITY FOR ALL CALIFORNIA PROJECTS.

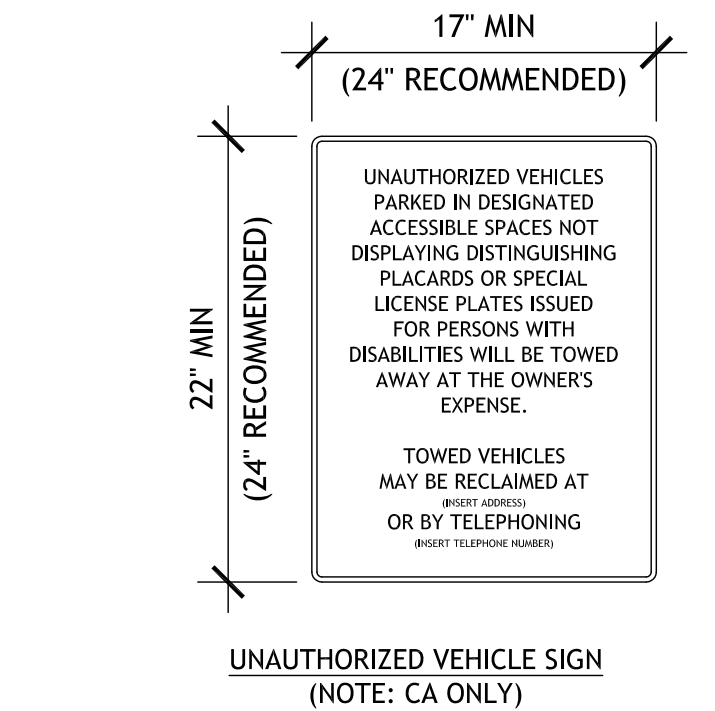

MOUNT BOTTOM 60" ABOVE GRADE MINIMUM EXCEPTION: WITHIN ACCESSIBLE ROUTE AT 80" ABOVE GRADE

DETAIL 'Z'
ADA SIGNS AT PARKING AREAS
NO SCALE

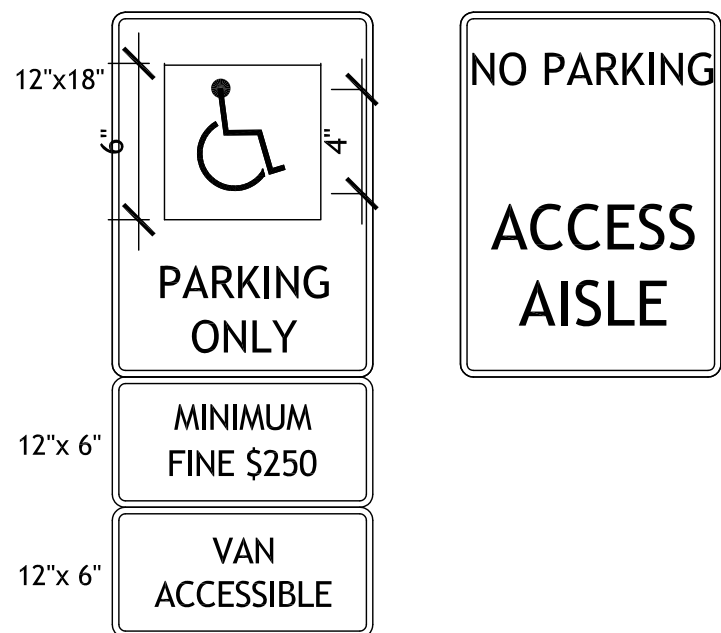

NO.	DATE	ISSUED FOR	BY
1	4-17-18	FOR REVIEW	

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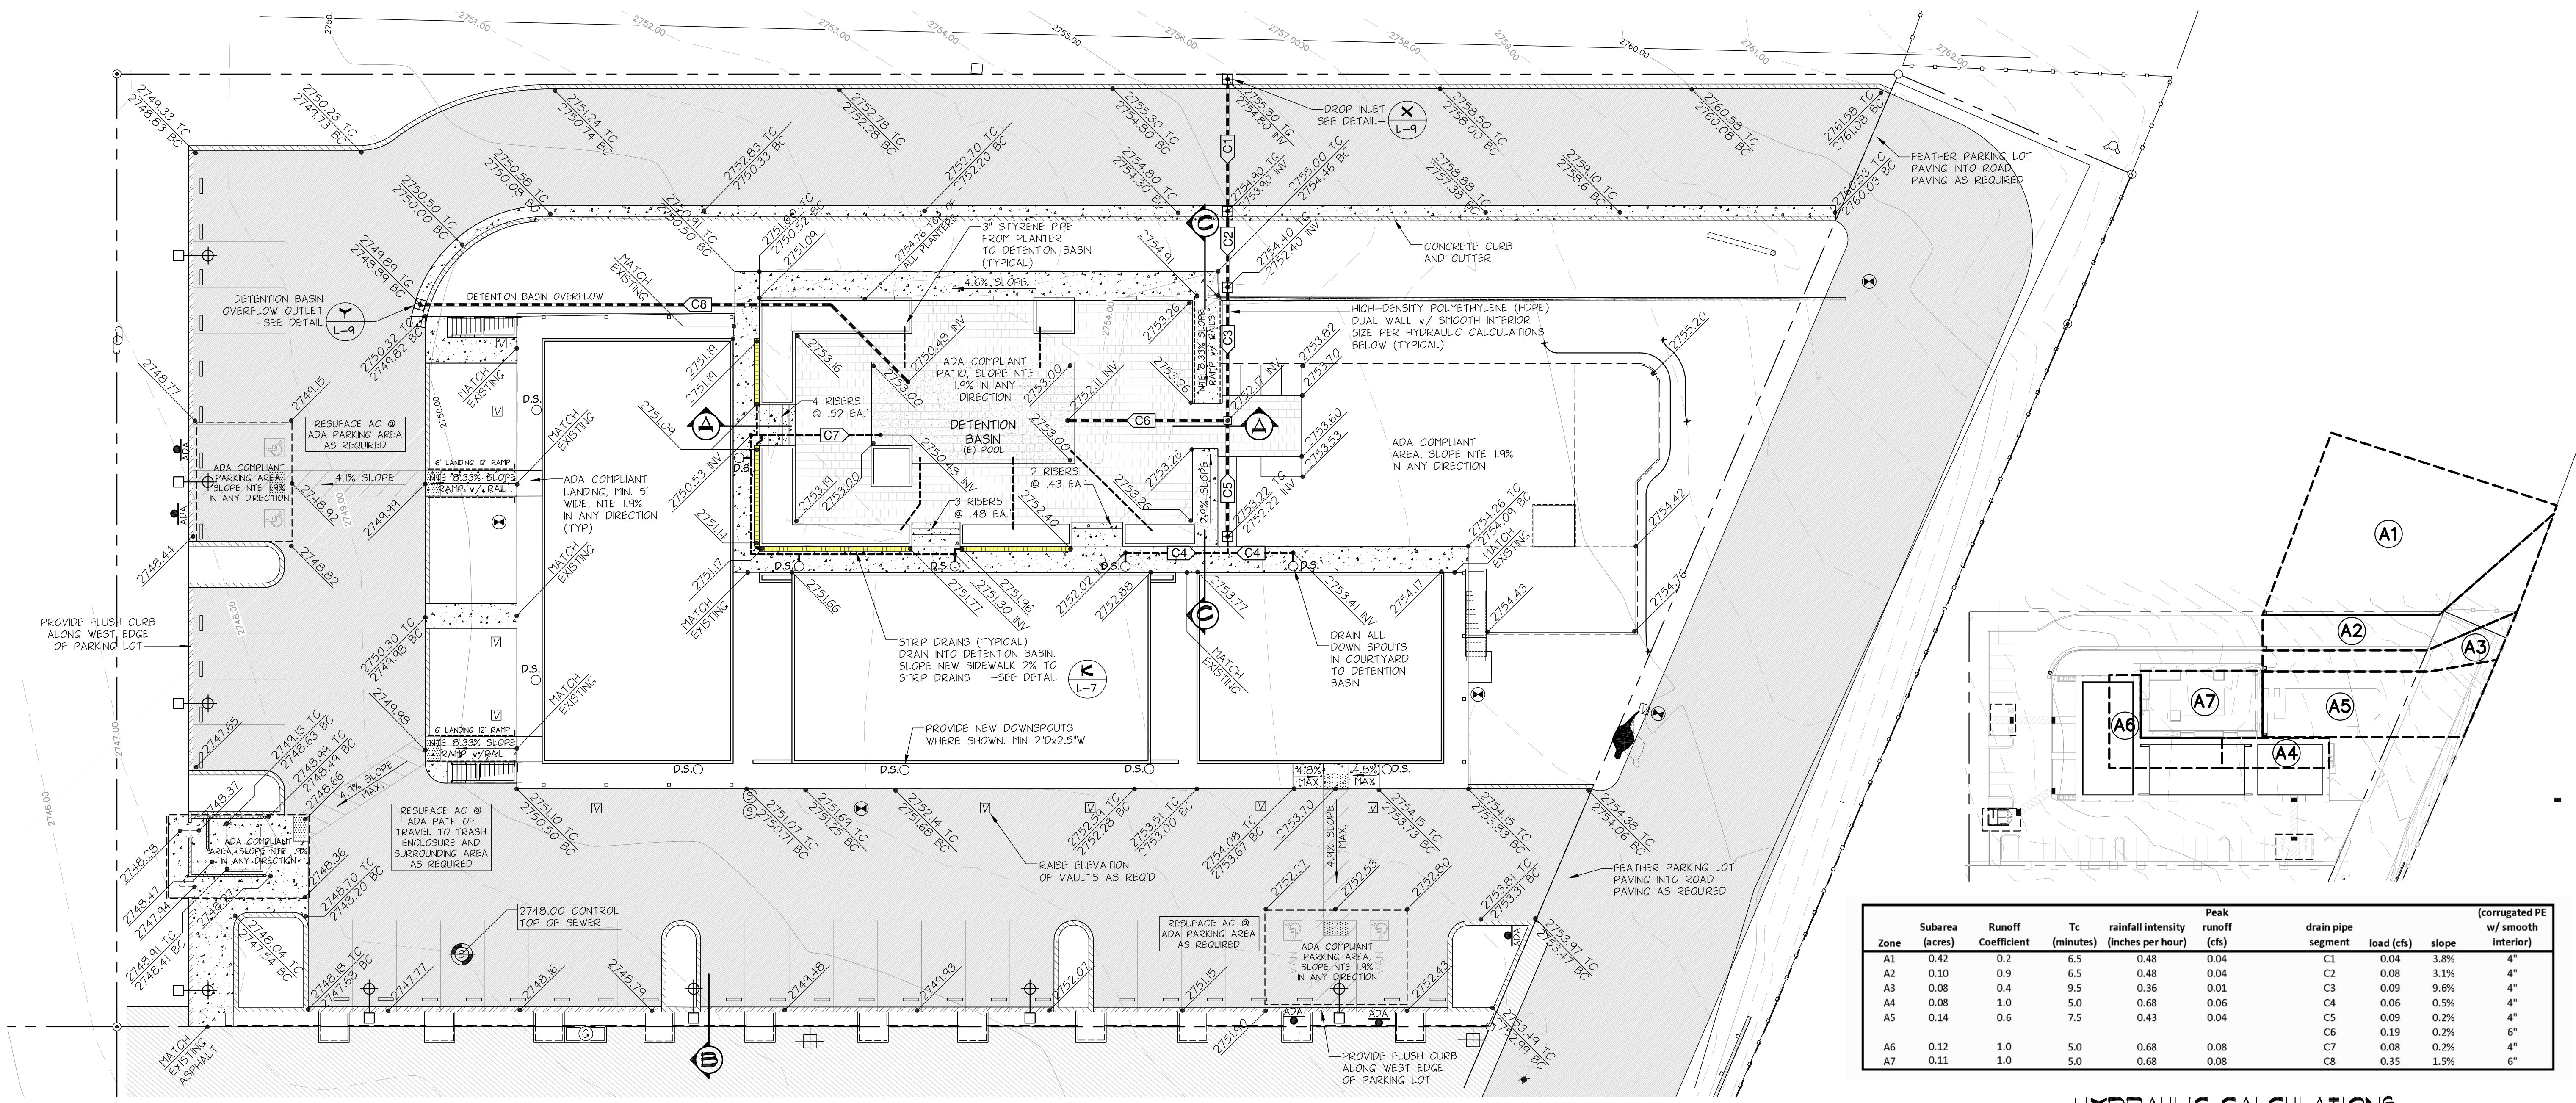
bda

19048 Blue Court
Grass Valley, CA 95949
530.277.0735
bda@bisnettdesign.com

Landscaping Architecture & Environmental Planning

DESERT HAVEN APARTMENTS
VICTORVILLE, CALIFORNIA

CONSTRUCTION DETAILS







Zone	Subarea (acres)	Runoff Coefficient	Tc (minutes)	rainfall intensity (inches per hour)	Peak runoff (cfs)	drain pipe segment	load (cfs)	slope	(corrugated PE w/ smooth interior)
A1	0.42	0.2	6.5	0.48	0.04	C1	0.04	3.8%	4"
A2	0.10	0.9	6.5	0.48	0.04	C2	0.08	3.1%	4"
A3	0.08	0.4	9.5	0.36	0.01	C3	0.09	9.6%	4"
A4	0.08	1.0	5.0	0.68	0.06	C4	0.06	0.5%	4"
A5	0.14	0.6	7.5	0.43	0.04	C5	0.09	0.2%	4"
A6	0.12	1.0	5.0	0.68	0.08	C6	0.19	0.2%	6"
A7	0.11	1.0	5.0	0.68	0.08	C7	0.08	0.2%	4"
						C8	0.35	1.5%	6"

HYDRAULIC CALCULATIONS

- CITY OF VICTORVILLE GRADING IMPROVEMENTS GENERAL NOTES
- Grading shall conform to Article 2 of Chapter 5 of Title 16 of the City of Victorville Municipal Code.
 - A Grading Permit shall be obtained from the City of Victorville Building Department prior to the start of grading work.
 - Contractor shall give the City of Victorville Building Department at least 2 working days notice to schedule a pre-construction meeting with the inspector prior to the start of work.
 - The contractor shall notify Underground Service Alert at 1 (800) 422-4133 at least 2 working days in advance of starting work.
 - It shall be the contractor's responsibility to familiarize himself/herself with site conditions and of any underground utilities shown or not shown on these plans.
 - The contractor shall give the City of Victorville Building Department at least 1 working day notice prior to all inspections at (760) 955-5103. A re-inspection fee will be rendered on each occasion when the contractor is not ready for the inspection at the scheduled time. No further inspections will be performed until said re-inspection fee is paid.
 - It shall be the contractor's responsibility to protect survey monuments in place and the contractor shall be financially responsible for resetting damaged or destroyed monuments.
 - No grading shall commence prior to 7:00 a.m. each working day.
 - Dust control shall include:
 - Provisions for continuous watering during grading operations including a 24-hour on call operator or as directed by City Staff.
 - Upon completion of the project, the entire site is to be stabilized by treating with magnesium chloride or other approved method and as approved by City Staff.
 - Clear all cut and fill areas of vegetation and organic materials to a depth of six (6) inches or more.
 - Fill shall be placed in lifts of eight (8) inches or less and sufficient moisture added and material compacted to achieve the required percent of compaction.
 - No rocks greater than six (6) inches in diameter may be placed in fill.
 - Compaction shall be a minimum of ninety percent (90%).
 - Minimum slope for all graded areas shall be one percent (1.00%) unless on smooth PCC, then the minimum slope shall be one-half percent (0.50%).
 - Maximum slopes shall be 2:1. Slope stabilization shall be provided on all slopes in accordance with Article 2 of Chapter 5 of Title 16 of the City of Victorville Municipal Code.
 - All off-site improvements shall be constructed to City of Victorville Standards
 - All fences and walls are under separate permit.
 - Retaining walls shall be constructed to City of Victorville Standards or wall calculations submitted to the Building Department for City approval.
 - Building pad and grading plan certification shall be completed by a licensed engineer in accordance with Article 2 of Chapter 5 of Title 16 of the City of Victorville Municipal Code.
 - The maximum allowable foundation bearing pressure shall be 1500 psi unless approved by the City of Victorville Building Department.
 - The contractor shall comply with the Grading Ordinance Section 16-5.02.060 and Section 16-5.02.070 of the City of Victorville Municipal Code as it relates to borrow pits, export sites and haul routes prior to issuance of a grading permit.
 - A Paleontological Monitor must be present during all phases of grading when required by City Staff.
 - Approximate Quantities:

Cut 30.5 cu. yds.
Fill _____ cu. yds.
Shrinkage _____ %

24. Construction activities of one (1) acre or more shall require a General Construction Storm Water Permit. For more information, you may call the State Water Resources Control Board -Division of Water Quality at (916) 657-1146.

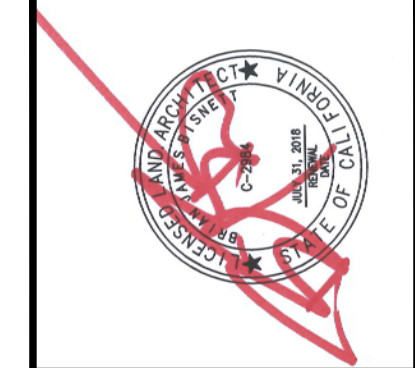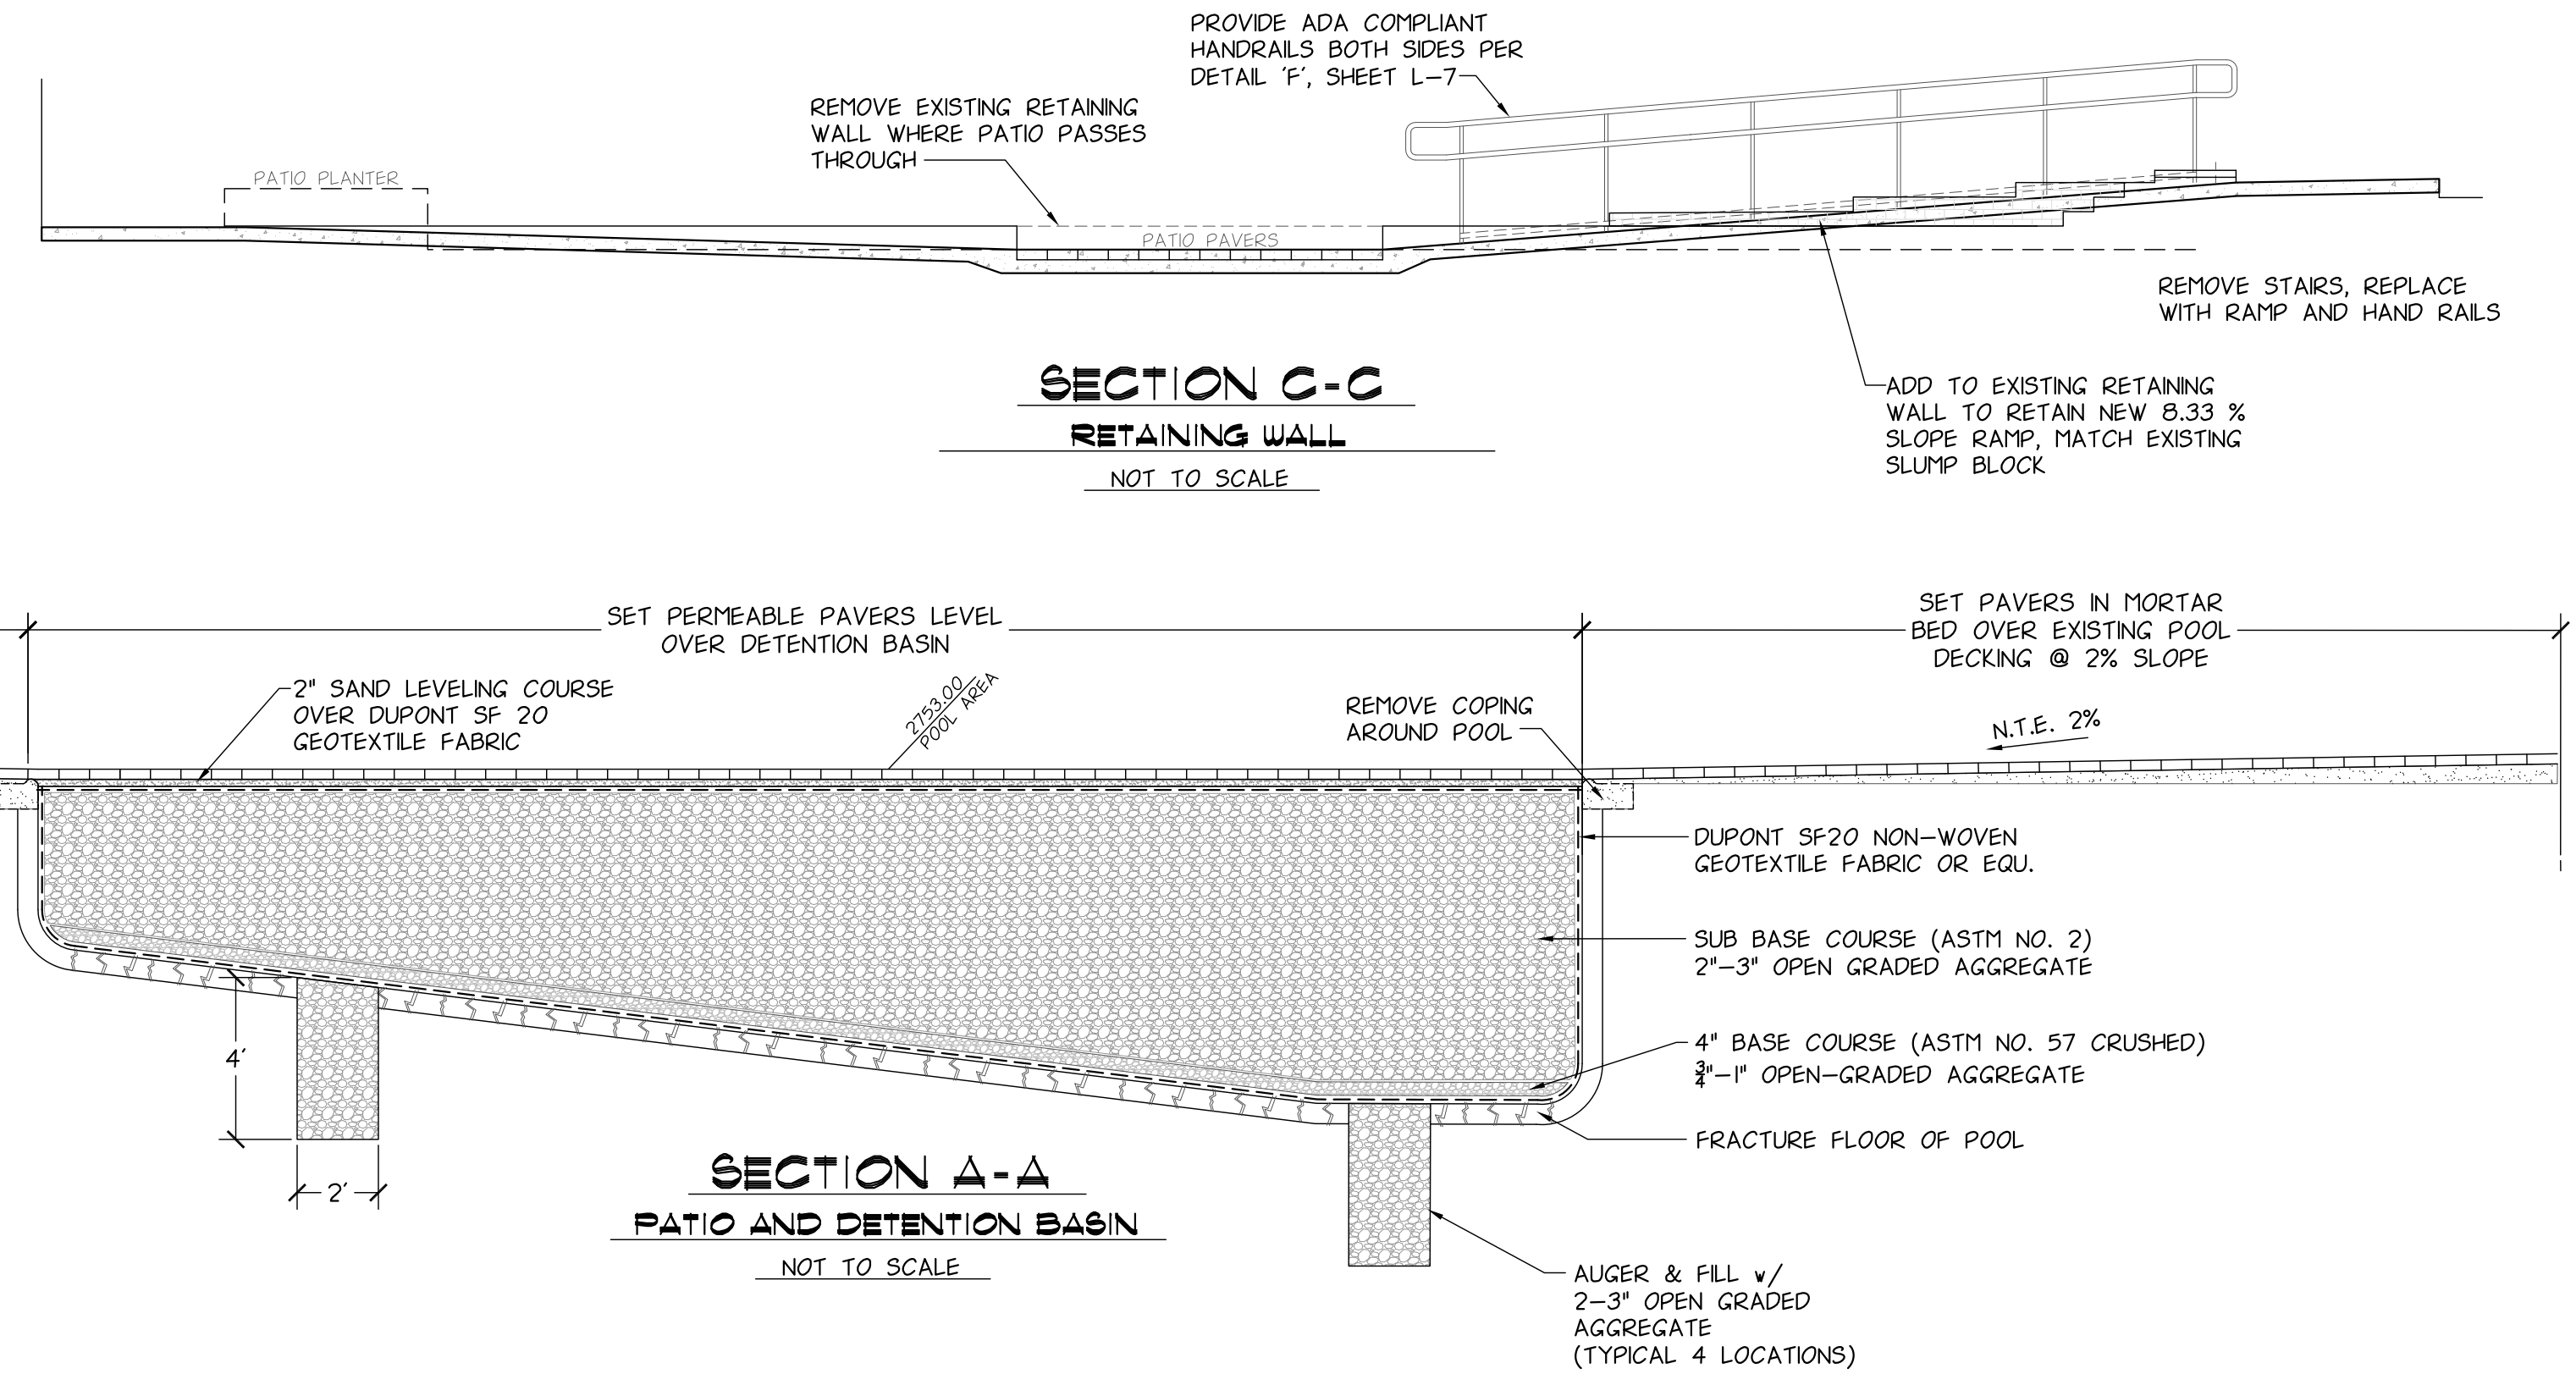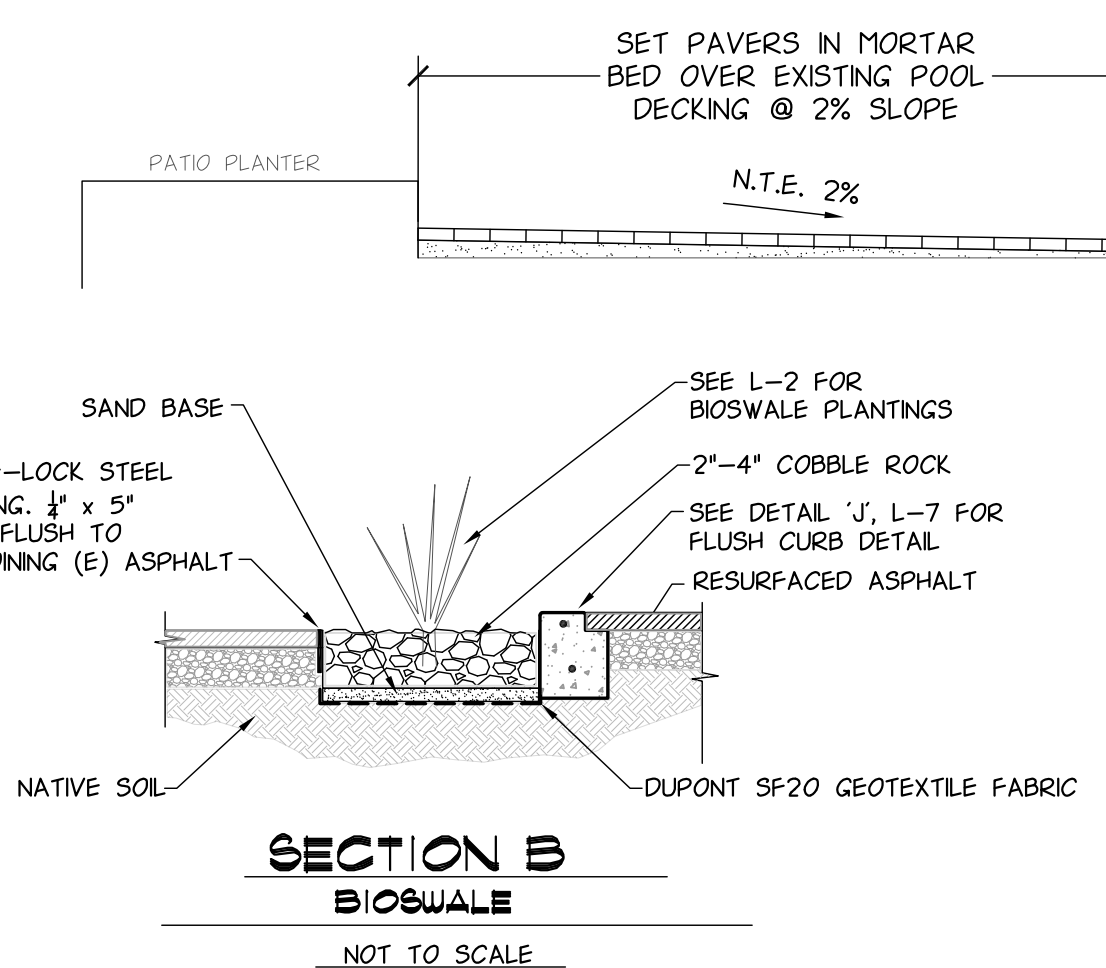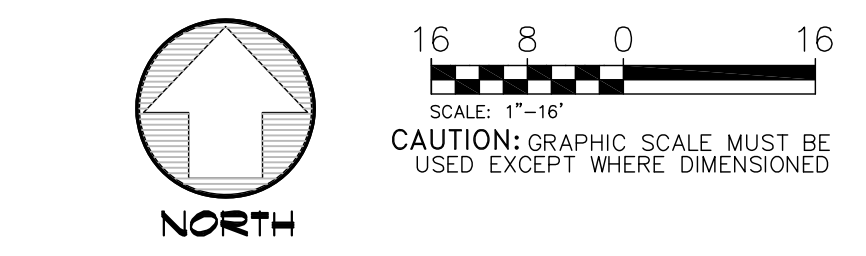

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NOTE
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BARS SHOULD MEASURE 1" OR DRAWING IS NOT TO SCALE

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APPROVED:
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Bisnett Design Associates
bda
16445 Bldg. 200
Great Valley, CA 95649
530.277.0733
blan@bisnettdesign.com
Landscape Architecture & Environmental Planning

DESERT HAVEN APARTMENTS
VICTORVILLE, CALIFORNIA
GRADING & DRAINAGE PLAN



EROSION CONTROL NOTES:

1. A STAND-BY CREW FOR EMERGENCY WORK SHALL BE AVAILABLE AT ALL TIMES DURING THE RAINY SEASON (NOVEMBER 1 THRU APRIL 15). NECESSARY MATERIALS SHALL BE AVAILABLE ON-SITE AND STOCKPILED AT CONVENIENT LOCATIONS TO FACILITATE RAPID CONSTRUCTION OF EMERGENCY DEVICES WHEN RAIN IS IMMINENT.
2. EROSION CONTROL DEVICES SHOWN ON THIS PLAN MAY BE REMOVED WHEN APPROVED BY THE BUILDING OFFICIAL IF THE GRADING OPERATION HAS PROGRESSED TO THE POINT WHERE THEY ARE NO LONGER REQUIRED.
3. GRADED AREAS ADJACENT TO FILL SLOPES LOCATED AT THE SITE PERIMETER MUST DRAIN AWAY FROM THE TOP OF SLOPE AT THE CONCLUSION OF EACH WORKING DAY. ALL LOOSE SOILS AND DEBRIS THAT MAY CREATE A POTENTIAL IMPACT TO OFF-SITE PROPERTY SHALL BE STABILIZED OR REMOVED FROM THE SITE ON A DAILY BASIS. DO NOT HOSE DOWN OR SWEEP SOIL OR SEDIMENT ACCUMULATED ON PAVEMENT OR OTHER IMPERVIOUS SURFACES INTO ANY STORMWATER CONVEYANCE (UNLESS CONNECTED TO A SEDIMENT BASIN, SEDIMENT TRAP, OR SIMILARLY EFFECTIVE CONTROL), STORM DRAIN INLET, OR SURFACE WATER. AND BE DISPOSED OF PROPERLY.
4. ALL SILT AND DEBRIS SHALL BE REMOVED FROM ALL DEVICES WITHIN 24 HOURS AFTER EACH RAINSTORM AND BE DISPOSED OF PROPERLY.
5. A GUARD SHALL BE POSTED ON THE SITE WHENEVER THE DEPTH OF WATER IN ANY DEVICE EXCEEDS TWO FEET. THE DEVICES SHALL BE DRAINED OR PUMPED DRY WITHIN 24 HOURS AFTER EACH RAINSTORM. PUMPING AND DRAINING OF ALL BASINS AND DRAINAGE DEVICES MUST COMPLY WITH THE APPROPRIATE BMP OF RALL DEWATERING OPERATIONS.
6. THE PLACEMENT OF ADDITIONAL DEVICES TO REDUCE EROSION DAMAGE AND CONTAIN POLLUTANTS WITHIN THE SITE IS LEFT TO DISCRETION OF THE FIELD ENGINEER. ADDITIONAL DEVICES AS NEEDED SHALL BE INSTALLED TO RETAIN SEDIMENTS AND OTHER POLLUTANTS ON SITE.
7. DESILTING BASINS MAY NOT BE REMOVED OR MADE INOPERABLE BETWEEN NOVEMBER 1 AND APRIL 15 OF THE FOLLOWING YEAR WITHOUT THE APPROVAL OF THE BUILDING OFFICIAL.
8. STORM WATER POLLUTION AND EROSION CONTROL DEVICES ARE TO BE MODIFIED, AS NEEDED, AS THE PROJECT PROGRESSES, THE DESIGN AND PLACEMENT OF THESE DEVICES IS THE RESPONSIBILITY OF THE FIELD ENGINEER. PLANS REPRESENTING CHANGES MUST BE SUBMITTED FOR APPROVAL IF REQUESTED BY THE BUILDING OFFICIAL.
9. EVERY EFFORT SHOULD BE MADE TO ELIMINATE THE DISCHARGE OF THE NON-STORM WATER FROM THE PROJECT SITE AT ALL TIMES.
10. ERODED SEDIMENTS AND OTHER POLLUTANTS MUST BE RETAINED ON-SITE AND MAY NOT BE TRANSPORTED FROM THE SITE VIA SHEET FLOW, SWALES, AREA DRAINS, NATURAL DRAINAGE COURSES, OR WIND.
11. STOCKPILE OR EARTH AND OTHER CONSTRUCTION-RELATED MATERIALS MUST BE PROTECTED FROM BEING TRANSPORTED FROM THE SITE BY FORCES OF WIND OR WATER.
12. FUELS, OILS, SOLVENTS, AND OTHER TOXIC MATERIALS MUST BE STORED IN ACCORDANCE WITH THEIR LISTED AND ARE NOT TO CONTAMINATE THE SOILS AND SURFACE WATERS. ALL APPROVED STORAGE CONTAINERS ARE TO BE PROTECTED FROM THE WEATHER. SPILLS MUST BE CLEANED UP IMMEDIATELY AND DISPOSED OF IN A PROPER MANNER. SPILLS MAY NOT BE WASHED INTO THE DRAINAGE SYSTEM.
13. EXCESS OR WASTE CONCRETE MAY NOT BE WASHED INTO THE PUBLIC WAY OR ANY OTHER DRAINAGE SYSTEM. PROVISIONS SHALL BE MADE TO RETAIN CONCRETE WASTE ON-SITE UNTIL THEY CAN BE DISPOSED OF A SOLID WASTE.
14. DEVELOPER/CONTRACTORS ARE RESPONSIBLE TO INSPECT ALL EROSION CONTROL DEVICES AND BMPs ARE INSTALLED AND FUNCTIONING PROPERLY IF THERE IS A 40% ACTUAL PRECIPITATION. A CONSTRUCTION SITE INSPECTION CHECKLIST AND ACTUAL PRECIPITATION, AND AFTER ACTUAL PRECIPITATION. A CONSTRUCTION SITE INSPECTION CHECKLIST AND INSPECTION LOG SHALL BE MAINTAINED AT THE PROJECT SITE AT ALL TIMES AND AVAILABLE FOR REVIEW BY THE BUILDING OFFICIAL (COPIES OF THE SELF-INSPECTION CHECK LIST AND INSPECTION LOGS ARE AVAILABLE UPON REQUEST).
15. SEDIMENTS AND OTHER MATERIALS MAY NOT BE TRACKED FROM THE SITE BY VEHICLE TRAFFIC. THE CONSTRUCTION ENTRANCE ROADWAYS MUST BE STABILIZED SO AS TO INHIBIT SEDIMENT FROM BEING DEPOSITED INTO THE PUBLIC WAY. ACCIDENTAL DEPOSITION MUST BE SWEEP UP IMMEDIATELY AND MAY NOT BE WASHED DOWN BY RAIN OR OTHER MEANS.
16. ANY SLOPES WITH DISTURBED SOILS OR DENUED OF VEGETATION MUST BE STABILIZED SO AS TO INHIBIT EROSION BY WIND AND WATER.

17. EROSION CONTROL FACILITIES AND MEASURES ARE TO BE INSTALLED AND OPERABLE AT ALL TIMES DURING CONSTRUCTION.
18. CHANGES TO THE EROSION CONTROL MEASURES INDICATED ON THESE PLANS AND DESCRIBED HEREIN TO ACCOMMODATE FIELD CONDITIONS MAY BE MADE ONLY WITH THE PRIOR APPROVAL OF, OR AT THE DIRECTION OF THE STATE REPRESENTATIVE.
19. EARTHEN BERMS AND STRAW BALE DIKES OR GEOTEXTILE FABRIC BARRIER SHALL BE CONSTRUCTED TO PREVENT OFF-FLOW OR SILTATION FROM THE PROJECT SITE. THE BERMS AND DIKES SHALL BE MAINTAINED IN PLACE UNTIL THE CONCLUSION OF THE SITE PAVING.
20. ALL PAVED AREAS SHALL BE KEPT CLEAR OF EARTH MATERIAL AND DEBRIS THE SITE SHALL BE MAINTAINED SO AS TO PREVENT SEDIMENT- LADEN RUNOFF FROM ENTERING THE STORM DRAINAGE SYSTEM OR ADJACENT PROPERTIES.
21. ALL EROSION CONTROL FACILITIES SHALL BE INSPECTED BY THE CONTRACTOR AND REPAIRED AS REQUIRED AT THE CONCLUSION OF EACH WORKING DAY DURING THE RAINY SEASON THE CONTRACTOR SHALL INSPECT THE EROSION CONTROL FACILITIES AND MAKE NECESSARY REPAIRS THERETO PRIOR TO ANTIOPATED STORMS AND SHALL PERIODICALLY INSPECT THE SITE AT REASONABLE INTERVALS DURING STORMS OF EXTENDED DURATION. REPAIRS TO DAMAGED FACILITIES SHALL BE REPAIRED IMMEDIATELY.
22. THE CONTRACTOR SHALL BE SOLELY RESPONSIBLE FOR INSTALLATION AND MAINTENANCE OF THE EROSION CONTROL FACILITIES AND SHALL CONDUCT PERIODIC INSPECTION OF THE PROJECT SITE DURING STORMS OF PROLONGED DURATION AND/OR HEAVY INTENSITY TO ASSURE THAT THEY FUNCTION IN THE MANNER DESCRIBED HEREIN.
23. ALL LOOSE SOIL AND DEBRIS SHALL BE REMOVED FROM THE STREET AREAS UPON STARTING OPERATIONS AND AT THE END OF EACH WORKDAY OR AS NECESSARY.
24. THE CONTRACTOR SHALL INSTALL THE STABILIZED CONSTRUCTION ENTRANCE PRIOR TO COMMENCEMENT OF GRADING. LOCATION OF THE ENTRANCE MAY BE ADJUSTED BY THE CONTRACTOR TO FACILITATE GRADING OPERATIONS. ALL CONSTRUCTION TRAFFIC ENTERING THE PAVED ROAD MUST CROSS THE STABILIZED CONSTRUCTION ENTRANCE. THE STABILIZED CONSTRUCTION ENTRANCE SHALL REMAIN IN PLACE UNTIL THE ROAD BASE ROCK COURSE IS COMPLETED.
25. AS STORM DRAIN IMPROVEMENTS ARE CONSTRUCTED, ALL STRUCTURES AND INLET PIPES SHALL BE PROTECTED FROM INFLOW OR SILT WITH FILTER BAGS OR GRAVEL BAG SALT BARRIERS.
26. ADJACENT PROPERTIES SHALL BE PROTECTED FROM STORM WATERS, MUD, SILT, ETC. ON A DAILY BASIS.
27. DUST CONTROL SHALL BE MAINTAINED AT ALL TIMES DURING CONSTRUCTION AND UNTIL FINAL COMPLETION. THE CONTRACTOR WHEN HE OR HIS SUBCONTRACTOR ARE OPERATING EQUIPMENT ON- SITE, SHALL PREVENT THE FORMATION OF ANY AIRBORNE NUISANCE BY WATERING AND/OR TREATING THE SITE OF THE WORK IN SUCH A MANNER THAT WILL CONTINE DUST PARTICLES TO THE IMMEDIATE SURFACE OF THE WORK. ADDITIONAL WATERING SHALL BE PROVIDED ON DRY OR WINDY DAYS. THE CONTRACTOR WILL BE RESPONSIBLE FOR ANY DAMAGE CAUSED BY DUST FROM HIS OWN ACTIVITIES OR HIS SUBCONTRACTORS ACTIVITIES IN PERFORMING THE WORK UNDER THIS CONTRACT AND SHALL BE RESPONSIBLE FOR ANY CITATIONS, FINES, OR CHARGES RESULTING FROM DUST NUISANCE. DUST CONTROL WILL BE DONE ON A DAILY BASIS.

28. MAINTENANCE IS TO BE PERFORMED AS FOLLOWS:

- A. THE EROSION AND SEDIMENT CONTROL MEASURES SHALL BE INSPECTED EVERYDAY AND AFTER EACH STORM.
 - B. SILT FENCES, BERMS AND SWALES ARE TO BE INSPECTED AFTER EACH STORM AND REPAIRS MADE AS NEEDED. GRAVEL BAGS PLACED AROUND CURB INLETS SHALL BE INSPECTED AND REPLACED IF DAMAGED.
 - C. SEDIMENT SHALL BE REMOVED AND SEDIMENT TRAPS RESTORED TO ORIGINAL DIMENSIONS WHEN SEDIMENT HAS ACCUMULATED TO WITHIN A FOOT OF OUTLET ELEVATION OR TO 1/2 THE HEIGHT OF ANY PERIMETER CONTROL.
 - D. SEDIMENT REMOVED FROM TRAPS SHALL BE DEPOSITED IN A SUITABLE AREA AND IN SUCH A MANNER THAT IT WILL NOT ERODE. E. SEEDED AREAS WILL BE REPAIRED, RESEEDED AND MULCHED AS SOON AS POSSIBLE AFTER DAMAGED.
29. CONTRACTOR SHALL IMPLEMENT HOUSEKEEPING PRACTICES AS FOLLOWS:
- A. SOLID WASTE MANAGEMENT: PROVIDE DESIGNATED WASTE COLLECTION AREAS AND CONTAINERS, ARRANGE FOR REGULAR REMOVAL AND DISPOSAL. CLEAR SITE OF TRASH INCLUDING ORGANIC DEBRIS, PACKAGING MATERIALS, SCRAP OR SURPLUS BUILDING MATERIALS AND DOMESTIC WASTE DAILY.
 - B. MATERIAL DELIVERY AND STORAGE: PROVIDE A DESIGNATED MATERIAL STORAGE AREA WITH SECONDARY CONTAINMENT SUCH AS BERMING. STORE MATERIAL ON PALLETS AND PROVIDE COVERING FOR SOLUBLE MATERIALS. RELOCATE STORAGE AREA INTO BUILDING SHELL WHEN POSSIBLE. INSPECT AREA WEEKLY.
 - C. CONCRETE WASTE: PROVIDE A DESIGNATED CONCRETE TRUCK WASHOUT BIN. DISPOSE OF HARDENED CONCRETE OFFSITE. AT NO TIME SHALL A CONCRETE TRUCK DUMP ITS WASTE AND CLEAN ITS TRUCK INTO THE CITY STORM DRAINS VIA CURB AND GUTTER. INSPECT DAILY TO CONTROL RUNOFF, AND WEEKLY FOR REMOVAL OF HARDENED CONCRETE.
 - D. PAINT AND PAINTING SUPPLIES: PROVIDE INSTRUCTION TO EMPLOYEES AND SUBCONTRACTORS REGARDING REDUCTION OF POLLUTANTS INCLUDING MATERIAL STORAGE, USE, AND CLEAN UP. INSPECT SITE WEEKLY FOR EVIDENCE OF IMPROPER DISPOSAL.
 - E. VEHICLE FUELING, MAINTENANCE AND CLEANING: PROVIDE A DESIGNATED FUELING AREA WITH SECONDARY CONTAINMENT SUCH AS BERMING. DO NOT ALLOW MOBILE FUELING OF EQUIPMENT. PROVIDE EQUIPMENT WITH DRIP PANS. RESTRICT ONSITE MAINTENANCE AND CLEANING OF EQUIPMENT TO A MINIMUM. INSPECT AREA WEEKLY.
 - F. PORTABLE TOILETS SHALL BE LOCATED AWAY FROM ALL STORM DRAIN INLETS.
- G. GRADING OPERATIONS AND CONSTRUCTION SHALL BECONDUCTED IN A MANNER AND/OR MEASURES TAKEN TO PREVENT SAND, DUST, AND DEBRIS FROM BEING BLOWN ONTO OTHER PROPERTIES. AN ADEQUATE DUST PALLIATIVE SHALL BE USED AT ALL TIMES. AFTER COMPLETION OF GRADING THE DEVELOPER SHALL MAINTAIN THE SITE SUCH THAT SAND, DUST AND DEBRIS DO NOT BLOW ONTO OTHER PROPERTIES.
- H. TEMPORARY FENCING SHALL BE ERECTED AS REQUIRED BY CITY STAFF DURING CONSTRUCTION TO PREVENT WINDBLOWN DEBRIS FROM LEAVING THE PROJECT SITE AND TO ENSURE PUBLIC SAFETY.

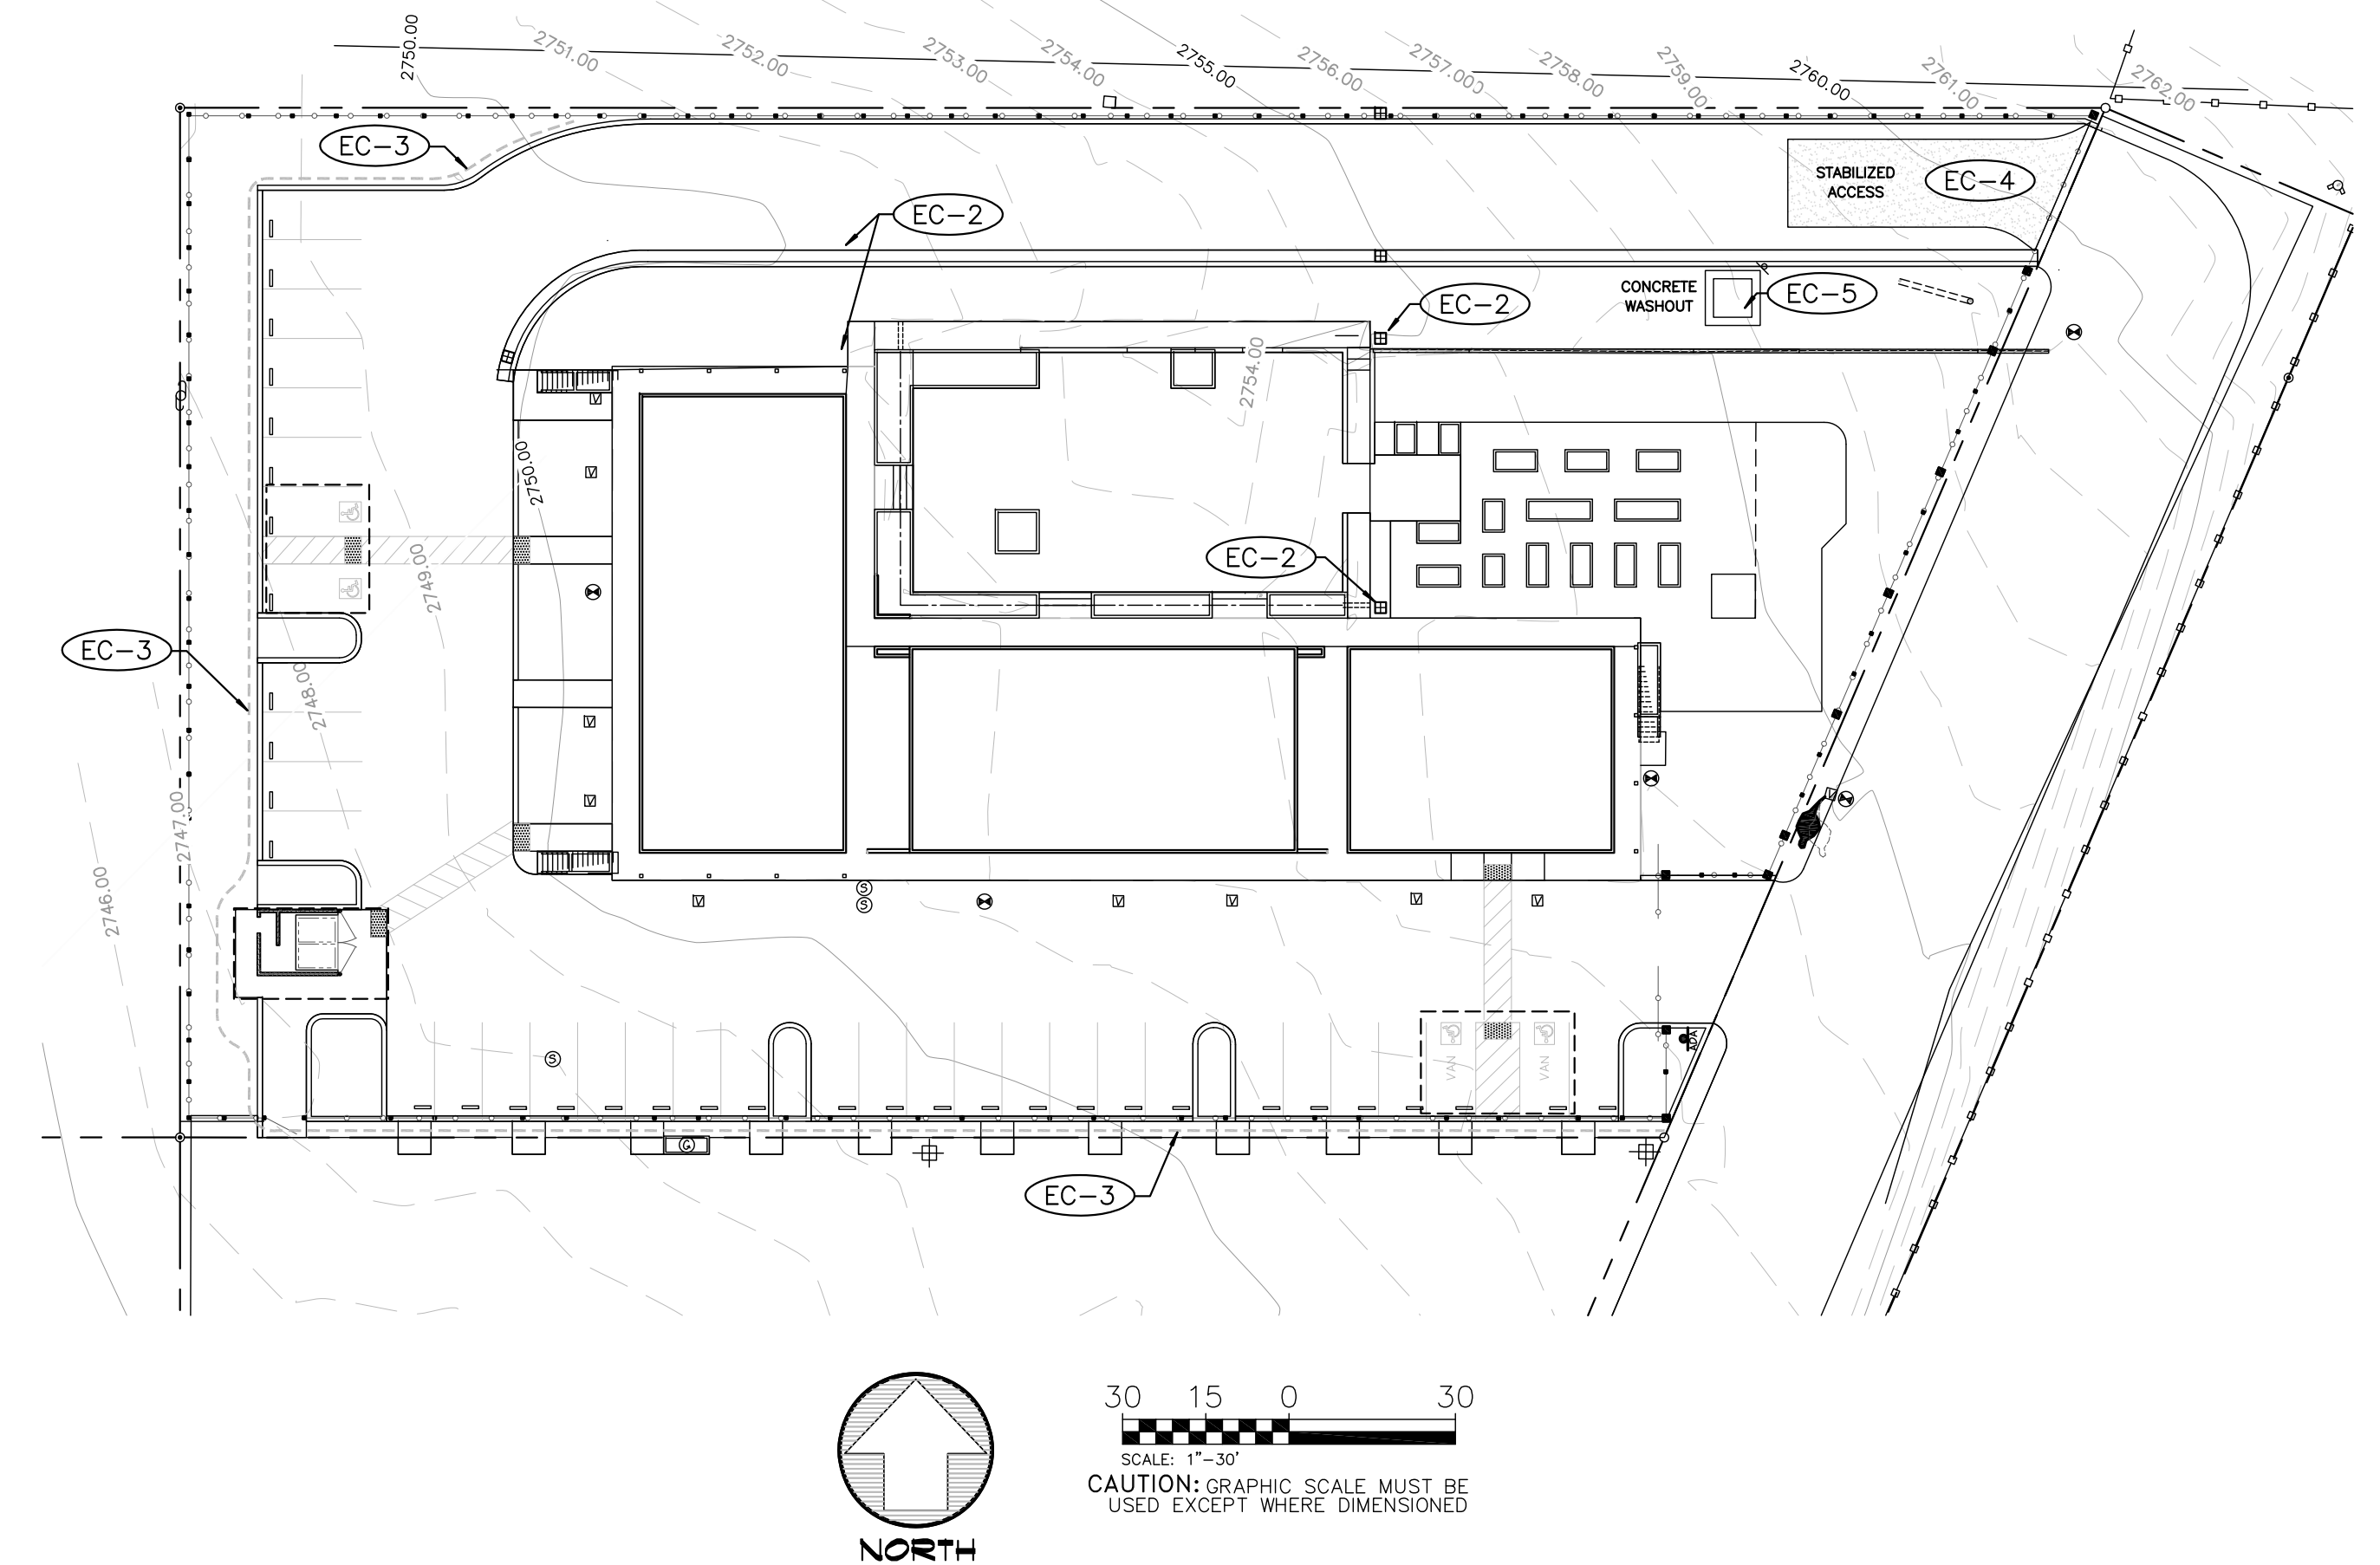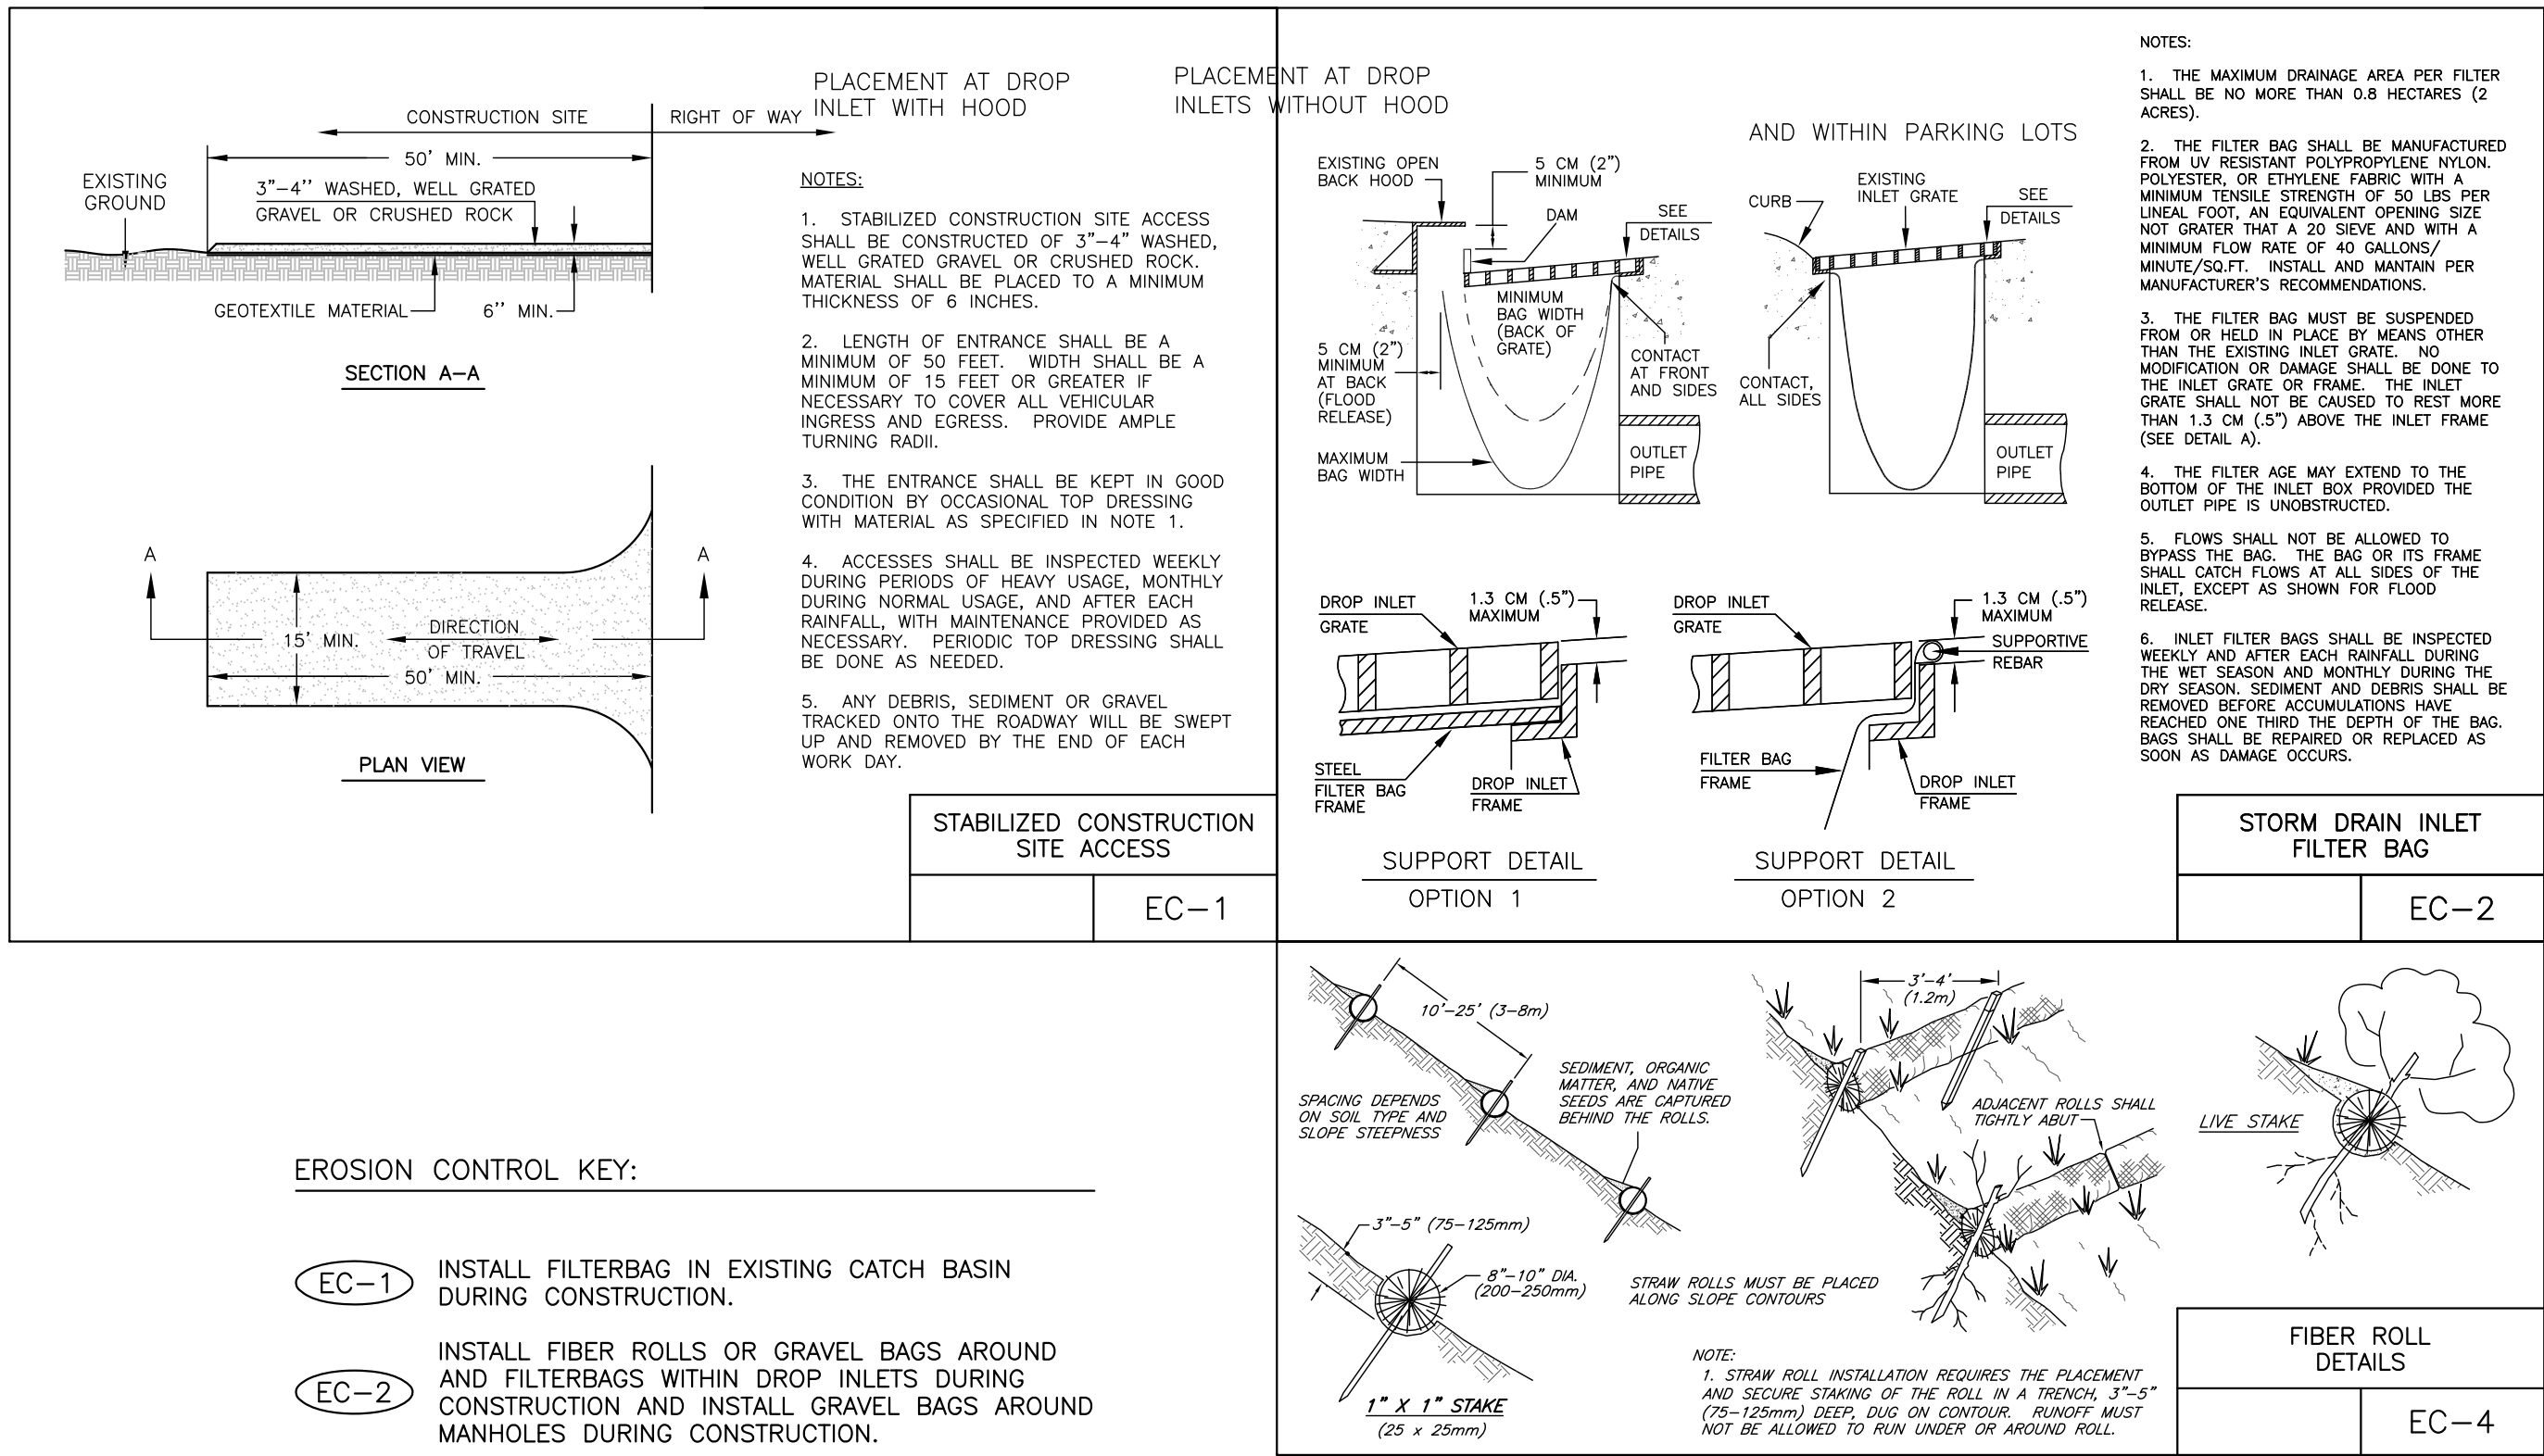

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
NOTE
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BAR SHOULD MEASURE 1" OR DRAWING IS NOT TO SCALE
LAST EDIT DATE: 4-17-18

Bisnett Design Associates
16048 Bear Court
Grass Valley, CA 95949
brian@bisnettdesign.com
Landscape Architecture & Environmental Planning

bda
DESERT HAVEN APARTMENTS
VICTORVILLE, CALIFORNIA
EROSION CONTROL PLAN

GROUND FLOOR CONVERSION NOTES

A, B, C - ORIGINAL MOTEL ROOM EFFICIENCY UNIT REFURBISH FINISHES & FIXTURES ONLY, SEE 5/A4.0.
M - MANAGERS UNIT - REFURBISH FINISHES & FIXTURES ONLY
UNITS 1 AND 4 - COMBINE TWO ROOMS IN-LINE. SEE 1, 2/A4.0.
UNITS 2, 3, 5, 6, 7, 8, 9, 10 - COMBINE TWO ROOMS SIDE BY SIDE. SEE 3,4/A4.0.
COMMON ROOM - COMBINE FOUR ROOMS SIDE BY SIDE.
OFFICE, LAUNDRY - REFURBISH FINISHES ANY FIXTURES ONLY.


 = ACCESSIBLE UNIT PER CBC 11B. ALL INLINE AND SIDE BY SIDE UNITS AT GROUND LEVEL TO BE ADAPTABLE PER CBC 11A EXCEPT 5% SHOWN AS ACCESSIBLE.

EXTERIOR KEY NOTES

- 1 INSTALL NEW UNIT ID WITH BRAILLE, TYPICAL AT ALL LEVEL UNITS.
- 2 NOT USED.
- 3 STAIRWAYS & RAILINGS: RETROFIT WITH NEW CLOSED RISERS, CBC RAILINGS AND EXTENSIONS.
- 4 WINDOWS AND DOORS: REPLACE ALL WINDOWS AND SLIDING GLASS DOORS, SOUND REDUCING, DUAL GLAZED INSULATED TYPE.
- 5 EXTERIOR DOORS: REPLACE ALL.
- 6 WATERPROOF ELEVATED WALKS.
- 7 SEAL ALL THRESHOLDS, REPLACE THRESHOLD WITH NEW CONFORMING THRESHOLD N.T.E $\frac{1}{4}"$ AFF (CBC 1122A2.1).
- 8 REMOVE (E) STAIRS. INFILL RAILING ABOVE.

SUMMARY OF REMODELED UNITS

UNIT OR SPACES	UNIT NUMBERS	AREA (EACH) SF	QUANTITY	AREA SUB TOTAL SF
GROUND FLOOR				
MANAGER'S UNIT	M	692	1	692
OFFICE AREA		473	1	473
EFFICIENCY UNITS A, B AND C	A, B, C	221	3	663
IN-LINE UNITS 1 AND 4	1, 4	442	2	884
SIDE-BY-SIDE UNITS	2, 3, 5, 6, 7, 8, 9, 10	431	8	3, 448
COMMUNITY ROOM		868	1	868
BOILER ROOM		268	1	268
LAUNDRY ROOM		268	1	1, 021
COVERED WALKWAY		1021	1	1, 021
GROUND FLOOR GROSS AREA				8, 585
SECOND FLOOR				
EFFICIENCY UNITS	D, E, F, G	216	4	864
IN-LINE UNITS	11, 12, 13, 16	431	4	1 724
SIDE-BY-SIDE UNITS	14, 15, 17, 18, 19 20, 21, 22, 23, 24	430	10	4, 300
STORAGE AND MECHANICAL		538	1	538
COVERED WALKWAY		991	1	991
SECOND FLOOR GROSS				8, 417
TOTAL GROSS AREA	M	692	1	17, 002
UNIT TOTALS				
EFFICIENCY UNITS			7	
IN-LINE UNITS			6	
SIDE-BY-SIDE UNITS			18	
DWELLING UNIT TOTALS			31	

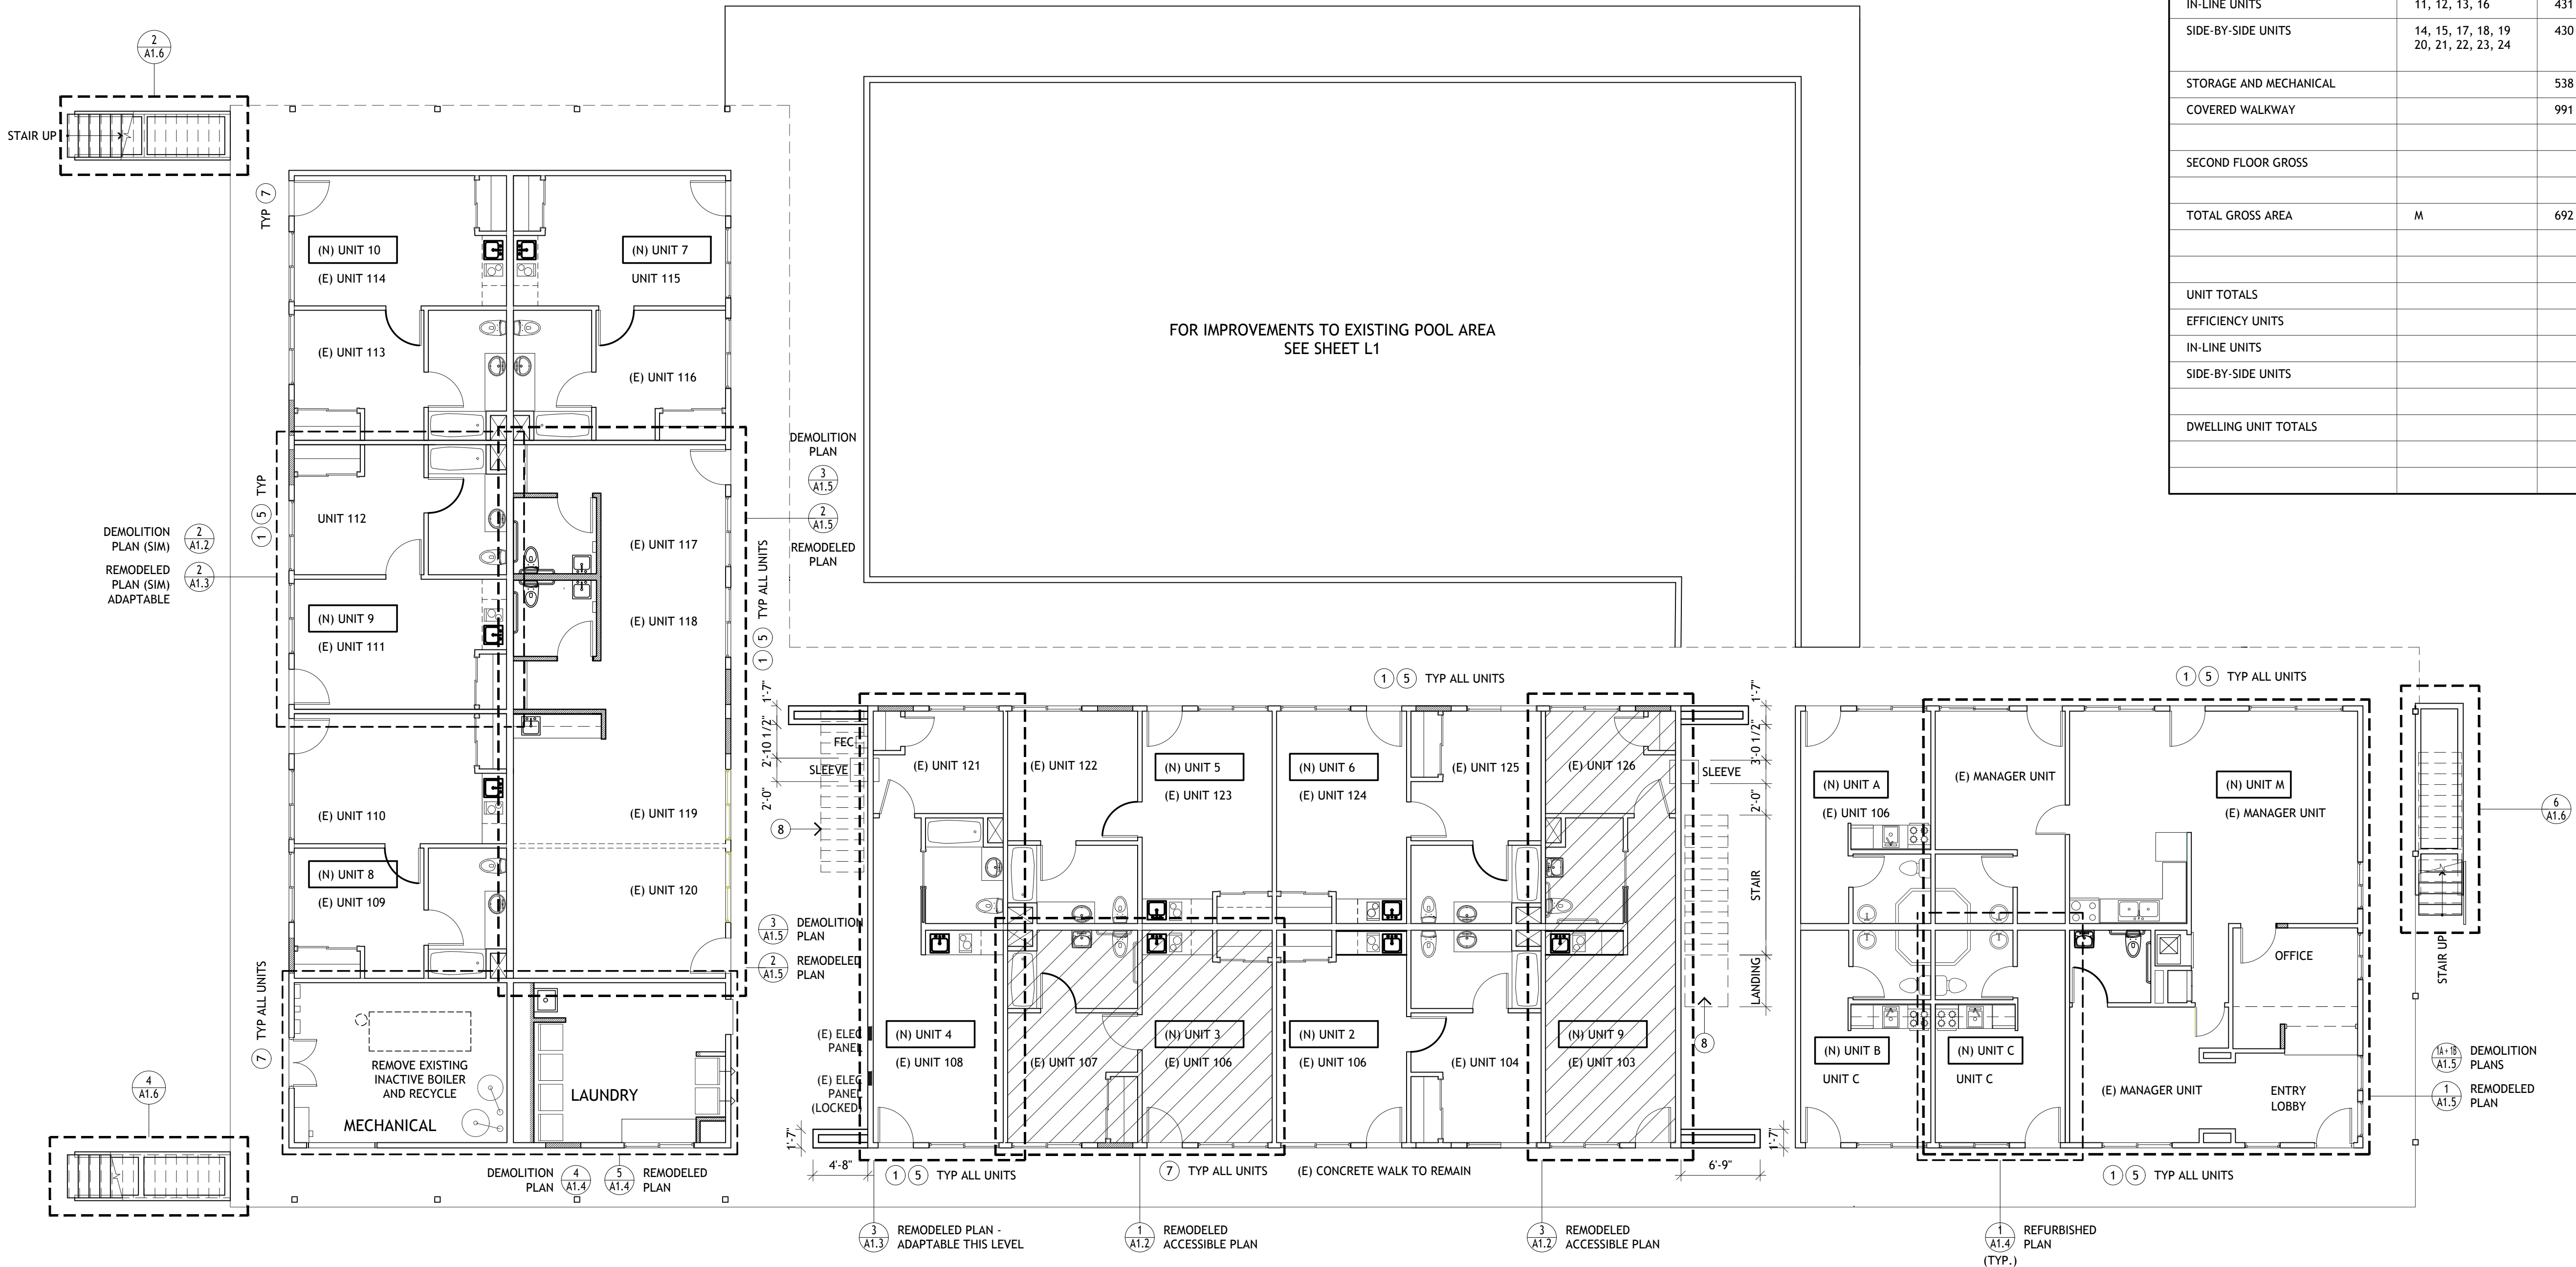

FIRST FLOOR PLAN

SCALE: 1/8" = 1'-0"

LEGEND

- (N) UNIT 10 REMODELED UNIT NUMBER WHEN CREATED FROM TWO EXISTING UNITS OR EXISTING UNIT RENUMBERED
- (E) UNIT 114 EXISTING UNIT NUMBER FOR SPACE PROVIDED FOR ITS ASSOCIATION WITH LABELED UNIT NUMBERS ON ELECTRICAL PANELS OR TELEPHONE TERMINAL BLOCKS

RECYCLING NOTES

- 1 THE CONTRACTOR IS REQUIRED TO HAVE AND SUBMIT A WASTE MANAGEMENT PLAN TO THE CITY OF VICTORVILLE FOR REVIEW AND APPROVAL PRIOR TO START OF DEMOLITION AND CONSTRUCTION OPERATIONS.
- 2 THE PLAN AND THE DEMOLITION AND CONSTRUCTION RECYCLING SHALL COMPLY WITH REQUIREMENTS OF CALGREEN DIVISIONS 4.408, CONSTRUCTION WASTE REDUCTION, DISPOSAL AND RECYCLING, AND DIVISION 5.408.3.
AT A MINIMUM, 50% OF ALL DEMOLITION AND CONSTRUCTION WASTE TO BE RECYCLED.
- 3 WASTE TO BE RECYCLED OR SALVAGED TO INCLUDE, BUT NOT BE LIMITED TO THE FOLLOWING:
CARPET
WOOD
AGGREGATE
PAINT
SHINGLES
WALLBOARD
CARDBOARD (PACKAGING)
ALUMINUM
GLASS
FERROUS METAL (RAILINGS)

- 4 THE CONTRACTOR IS REQUIRED TO HAVE AND SUBMIT A WASTE MANAGEMENT PLAN TO THE CITY OF VICTORVILLE FOR REVIEW AND APPROVAL PRIOR TO START OF DEMOLITION AND CONSTRUCTION OPERATIONS.
- 5 THE PLAN AND THE DEMOLITION AND CONSTRUCTION RECYCLING SHALL COMPLY WITH REQUIREMENTS OF CALGREEN DIVISIONS 4.408, CONSTRUCTION WASTE REDUCTION, DISPOSAL AND RECYCLING, AND DIVISION 5.408.3.
- 6 TO VERIFY THE REQUIREMENTS OF CALIFORNIA AND CITY OF VICTORVILLE SEE:
VICTOR VALLEY RECYCLING GUIDE FOR CONSTRUCTION AND DEMOLITION MATERIALS
OR CONTACT THE CITY OF VICTORVILLE AT:
WWW.VICTORVILLECA.GOV
WWW.VICTORVILLEYCYCLES.COM
720-955-8615

- 7 SALVAGED MATERIALS
RIGHT OF FIRST REFUSAL FOR SALVAGED MATERIALS TO BE OFFERED TO:
HABITAT FOR HUMANITY VICTORVILLE
16845 NORTH D STREET, VICTORVILLE, CA
760-241-3733
SALVAGEABLE MATERIALS TO INCLUDE, BUT NOT BE LIMITED TO:
UNIT ENTRY DOORS
DOOR HARDWARE
PLUMBING FIXTURES
LIGHTING FIXTURES

LEGEND

 CROSS HATCHING INDICATES ACCESSIBLE UNIT

BASIS Architecture & Consulting

2130 FOURTH ST
SAN RAFAEL, CA 94901
PHONE (415) 457-6035
FAX (415) 457-6036

P.O.BOX 150539
SAN RAFAEL, CA 94915

CHARLES PICK, ARCHITECT



DRAWING REVISION LOG

FOR BIO	5-15-2018

PROJECT NAME:

DESERT HAVEN
(QUEEN'S MOTEL)
RE-DEVELOPMENT

PROJECT LOCATION:

16959 STODDARD WELLS RI
VICTORVILLE, CA 92395

SHEET TITLE:

REMODELED GROUND
FLOOR PLAN

SCALE: AS NOTED

A1.0

D, E, F, G - ORIGINAL MOTEL ROOMS EFFICIENCY UNITS REFURBISH FIXTURES & FINISHES ONLY. SEE 5/A4.0.

UNITS 11, 12, 13, 16 - COMBINE TWO ROOMS IN-LINE. SEE 1, 2/A4.0.

UNITS 14, 15, 17, 18, 19, 20, 21, 22, 23, 24 - COMBINE TWO ROOMS SIDE BY SIDE. SEE 3,4/A4.0.

ALL UNITS THIS LEVEL ARE "STANDARD".


- ① INSTALL NEW UNIT ID WITH BRAILLE, TYPICAL AT ALL UNITS.
- ② PROVIDE CANE RAIL DETECTION IN ACCORDANCE WITH CBC CHAPTER 11B- CALIFORNIA ACCESSIBILITY CODE, SEE SITE PLAN FOR LOCATIONS.
- ③ STAIRWAYS & RAILINGS: REPLACE ALL WITH NEW CLOSED RISERS, CBC RAILINGS AND EXTENSIONS.
- ④ WINDOWS AND DOORS: REPLACE ALL WINDOWS AND SLIDING GLASS DOORS, SOUND REDUCING, DUAL GLAZED INSULATED TYPE.
- ⑤ EXTERIOR DOORS: REPLACE ALL.
- ⑥ WATERPROOF ELEVATED WALKS. NOTE, SOME WALKS ARE SLOPED, PROVIDE NON SKID SURFACE.
- ⑦ SEAL ALL THRESHOLDS, REPLACE THRESHOLD WITH NEW CONFORMING THRESHOLD N.T.E. 3" AFF (CBC 1122A2.1), GROUND FLOOR.
- ⑧ REMOVE (E) STAIRS.
- ⑨ (N) GUARDRAIL - CONTINUOUS

UNIT OR SPACES	UNIT NUMBERS	AREA (EACH) SF	QUANTITY	AREA SUB TOTAL SF
GROUND FLOOR				
MANAGER'S UNIT	M	692	1	692
OFFICE AREA		473	1	473
EFFICIENCY UNITS A, B AND C	A, B, C	221	3	663
IN-LINE UNITS 1 AND 4	1, 4	442	2	884
SIDE-BY-SIDE UNITS	2, 3, 5, 6, 7, 8, 9, 10	431	8	3, 448
COMMUNITY ROOM		868	1	868
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COVERED WALKWAY		1021	1	1, 021
GROUND FLOOR GROSS AREA				8, 585
SECOND FLOOR				
EFFICIENCY UNITS	D, E, F, G	216	4	864
IN-LINE UNITS	11, 12, 13, 16	431	4	1 724
SIDE-BY-SIDE UNITS	14, 15, 17, 18, 19 20, 21, 22, 23, 24	430	10	4, 300
STORAGE AND MECHANICAL		538	1	538
COVERED WALKWAY		991	1	991
SECOND FLOOR GROSS				8, 417
TOTAL GROSS AREA	M	692	1	17, 002
UNIT TOTALS				
EFFICIENCY UNITS			7	
IN-LINE UNITS			6	
SIDE-BY-SIDE UNITS			18	
DWELLING UNIT TOTALS			31	

LICENSED ARCHITECT
 CHARLES PICK
 C-21406
 6-2019
 RENEWAL
 DATE
 STATE OF CALIFORNIA

[illegible]

A1.1

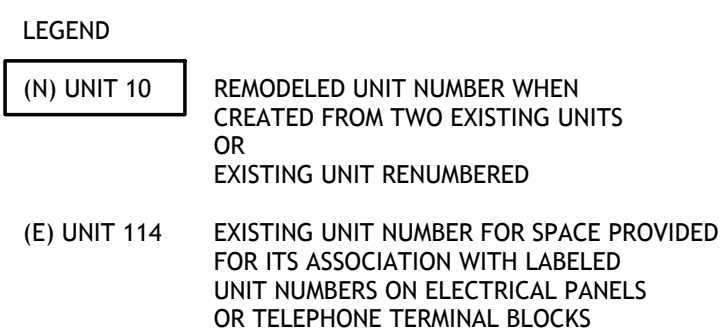

UNIT KEYED NOTES

KITCHENETTE
COUNTERTOPS: INSTALL NEW SOLID SURFACE COUNTERTOP AT 33 3/4" AFF W/4" BACKSPLASH.

1
2

INSTALL NEW ACME 72" ADA CERTIFIED MODULAR KITCHENETTE WITH DOUBLE BURNER HOT PLATE, REFRIGERATOR AND INTEGRATED SINK. (NO UPPER CABINETS). ALLOWS FOR ACCESSIBILITY AND UTILITY.

BATHROOM
(N) DROPPED CLG @ 7'-0", MOISTURE RESISTANT DRYWALL, 2x6 @ 16" W/LDGERS @ BEARING ENDS. TAPE, SEAL, TEXTURE TO MATCH (E) (AT IN-LINE UNITS)

3
4
5

INSTALL NEW WATER SENSE TOILETS, SHOWER HEADS & SHOWER VALVES WITH ANTI-SCALD.

INSTALL CONFORMING LOW FLOW TOILET W/FLUSH LEVER AT WIDE SIDE W/REQ'D CLEARANCES. PROVIDE CONFORMING FRONT & SIDE GRAB BARS WITH REQD. BLOCKING.

6

INSTALL CONFORMING WALL HANG LAVATORY W/LEVER LOW FLOW FAUCET & PIPE WRAP, SINK RIM HEIGHT NTE 34" AFF.

INTERIOR

7

PROVIDE CONFORMING DOOR LEVER HARDWARE WITH RETURNS AT ALL SWING DOORS. ALL DOOR HARDWARE WITH KEY LOCKING SHALL BE SINGLE HAND OPERABLE, PER DISABLED ACCESSIBLE STANDARDS.

8

THRESHOLD: REPLACE THRESHOLD WITH NEW CONFORMING THRESHOLD N.T.E. 1/2 INCH A.F.F. [CBC 1132A.1, 1126A.2.1]

9


RETROFIT WINDOWS. FRAME AND WATERPROOF PER STANDARD WINDOW INSTALLATION. DUAL GLAZED, LOW-E GLASS, ENERGY STAR-RATED. OPERATING HARDWARE SHALL BE COMPLIANT FOR FRONT & SIDE REACH.

ROOM FINISH SCHEDULE
TYPICAL SIDE-BY-SIDE ACCESSIBLE GROUND FLOOR UNIT

ROOM #	ROOM DESCRIPTION	FLOOR	BASE	WALLS	CEILING	NOTES
100	ACCESSIBLE REMODELED LIVING ROOM	NEW VINYL ON EXISTING CONCRETE SLAB ON GRADE	NEW 4" COVE VINYL BASE	EXISTING AND NEW GYP BRD TO BE PAINTED	EXISTING GYP BRD TO BE PAINTED	- - -
101	ACCESSIBLE REMODELED BEDROOM	NEW VINYL ON EXISTING CONCRETE SLAB ON GRADE	NEW 4" COVE VINYL BASE	EXISTING GYP BRD TO BE PAINTED	EXISTING GYP BRD TO BE PAINTED	- - -
102	ACCESSIBLE REMODELED BATHROOM	NEW VINYL ON EXISTING CONCRETE SLAB ON GRADE	NEW 4" COVE VINYL BASE	EXISTING GYP BRD TO BE PAINTED	(N) OR (E) GYP BRD TO BE PAINTED	- - -

GENERAL NOTES FOR INTERIOR FINISHES:

- 1 NEW GYP BRD REQUIRED IN ANY CONSTRUCTION TO HAVE TEXTURED FINISH TO MATCH EXISTING ADJACENT FINISH
- 2 ALL NEW PAINT COLORS TO BE SELECTED BY OWNER FROM STANDARD COLORS
- 3 CONSTRUCTION CLEANING REQUIRED TO INCLUDE, BUT NOT BE LIMITED TO, TO THOROUGHLY CLEANING ANY EXISTING FIXTURES, FAUCETS, LIGHTING FIXTURES, ETC., TO BE REUSED IN NEW WORK.

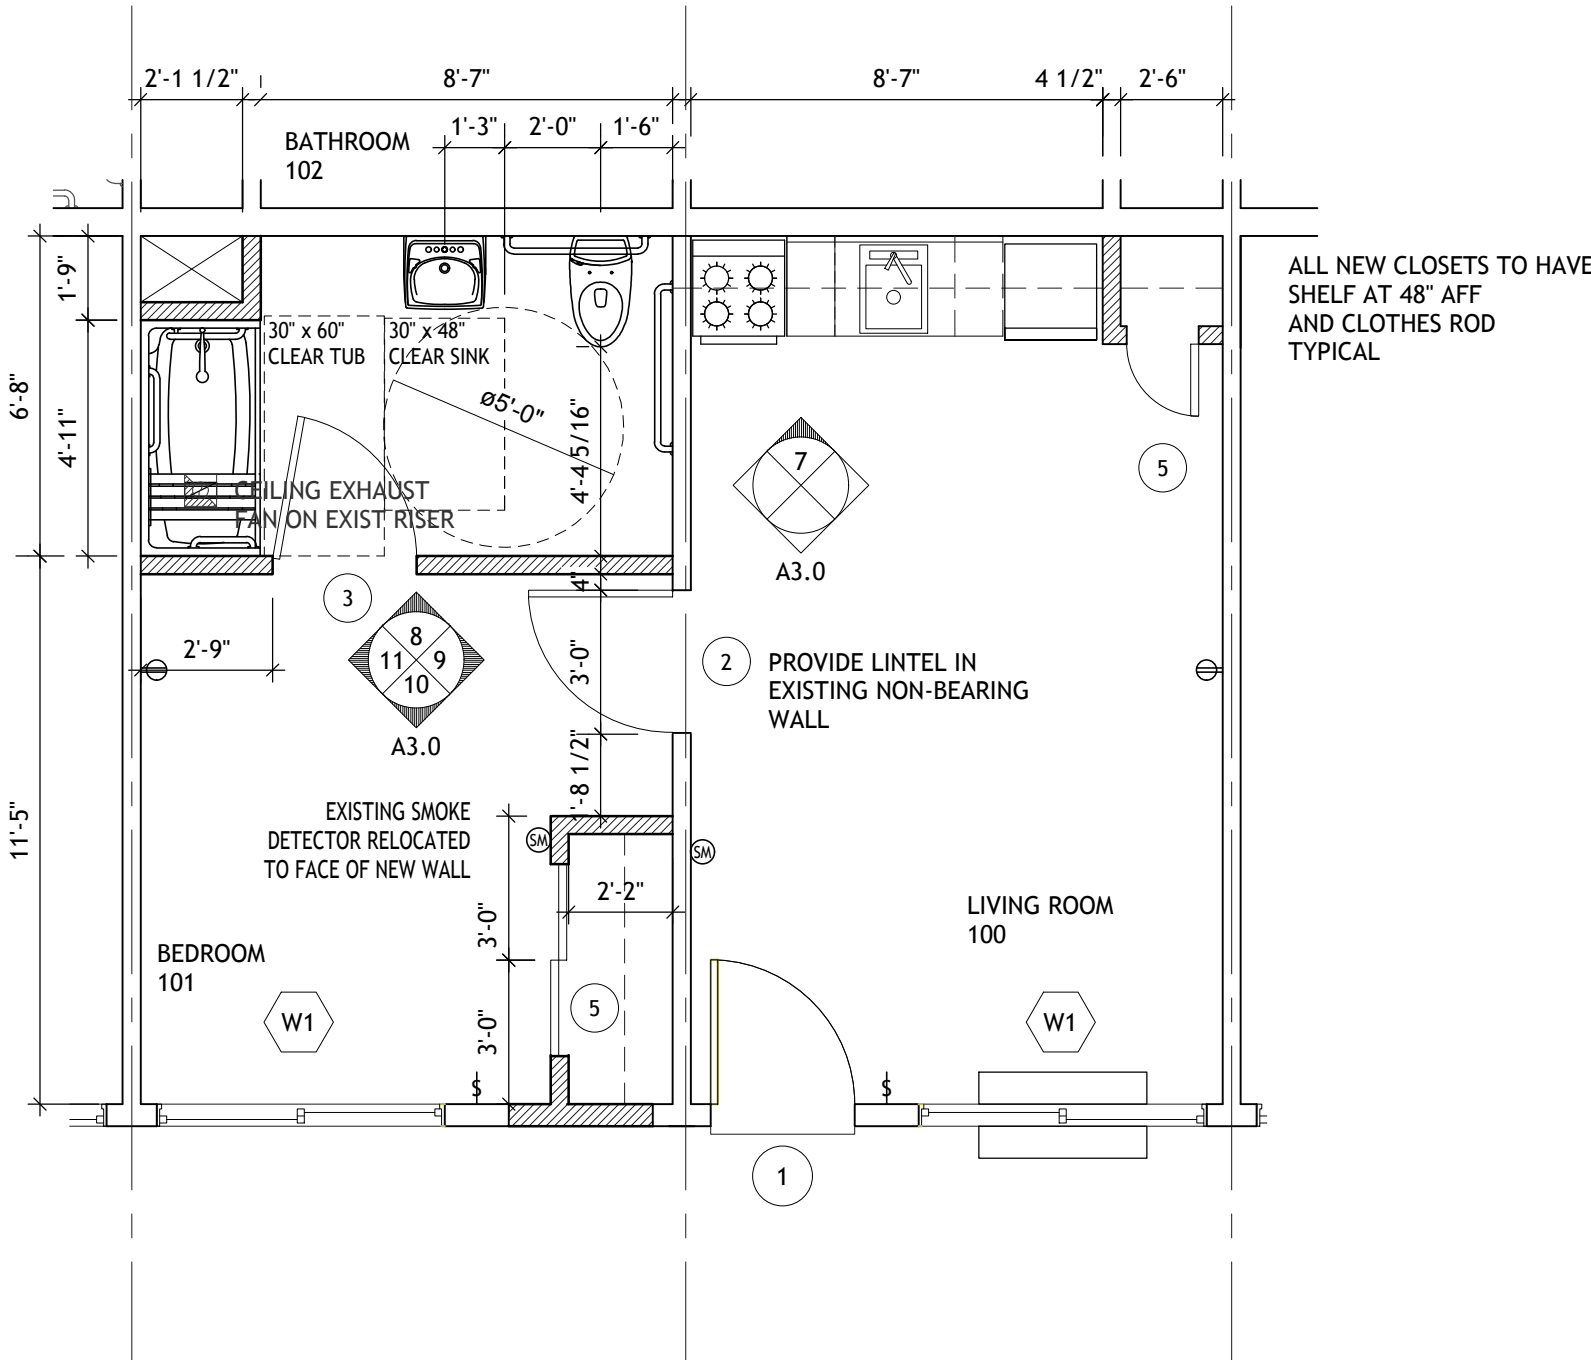

1 SIDE-BY-SIDE ACCESSIBLE UNIT (UNIT 3)
REMODELED PLAN
SCALE: 1/4" = 1'-0"


- 10 PROVIDE DISABLED ACCESS DOOR PULL HARDWARE AT CLOSETS AND POCKET DOORS.
- 11 LOWER SHELF & POLE @ 47" AFF MAX. AT CLOSETS.
- MECHANICAL/PLUMBING/ELECTRICAL
- 12 INSTALL HARDWIRED AUDIBLE/ VISUAL SMOKE DETECTORS COMBINED WITH CARBON MONOXIDE DETECTOR WITH FLASHING STROBE (MOUNT AT 80" AFF TO BOTTOM SURFACE MINIMUM). PROVIDE AT COMMON USE LAUNDRY ROOMS AND DISABLED ACCESSIBLE UNITS.
- 13 PROVIDE HARD-WIRED ELECTRIC W/ FLASHING STROBE DOORBELL OUTSIDE THE DWELLING UNIT PRIMARY ENTRANCE. MOUNT BOTTOM SURFACE AT 80" AFF. ACTIVATION OF THE BUTTON OR SWITCH IS TO INITIATE AN AUDIBLE TONE AND VISIBLE SIGNAL WITHIN THE RESIDENTIAL DWELLING UNIT. WHEN VISIBLE DOORBELL SIGNALS ARE LOCATED IN SLEEPING AREAS, THEY MUST HAVE CONTROLS TO DEACTIVATE THE SIGNAL. [CBC 11B809.5.5.1]
- 14 REPLACE LIGHT FIXTURES W/ HIGH EFFICIENCY, HIGH EFFICACY LIGHTING (SEE ELECTRICAL DRAWINGS).
- 15 OUTLETS AT KITCHEN SPACE TO PROVIDE NO MORE THAN 24" TO OUTLET AT ALL COUNTER AREAS. (SEE ELECTRICAL DRAWINGS). PROVIDE 1 USB OUTLET IN KITCHEN.
- 16 RE-PIPE ALL COPPER SUPPLY LINES IN UNITS (SEE PLUMBING DRAWINGS).
- 17 UNIT HVAC: REUSE EXISTING SYSTEM. REFURBISH AS NEEDED, TYPICAL.
- 18 PROVIDE/REPLACE ALL ANGLE STOPS.
- 19 PLUMBING FIXTURES - KITCHENETTE: PROVIDE WATER AND DRAIN FOR NEW KITCHENETTE, TYPICAL.
- 20 BATH FAN VENTILATION: REPLACE ALL BATHROOM FANS WITH HUMIDISTAT CONTROLLED, CONSTANT RUNNING TWO SPEED ESTAR UNITS. INCLUDES RADIANT DAMPER FOR ONE HOUR FLOOR/CEILING LOCATIONS, TYPICAL.
- 21 KITCHENETTE VENTILATION: ADD THROUGH WALL VENT FAN, WATERPROOF FULLY, TYPICAL.

GENERAL NOTES

- 1 DRYWALL REPAIRS AT UNITS AS NEEDED.
- 2 WINDOW WATERPROOFING: REMOVE SEALANTS ALL FOUR SIDES INCLUDING COMPLETE REMOVAL AT BOTTOM CORNERS FOR WEEPS. ADD NEW POLYURETHANE SEALANTS TOP AND SIDES. COORDINATE WITH OTHER WATERPROOFING.
- 3 NEW INTERIOR PARTITION WALLS. FINISH, PRIME & PAINT, AS NEEDED.
- 4 UNIT PAINT AND DRYWALL: MINOR REPAIRS, AND PAINT ALL SURFACES INCLUDING DOORS.
- 5 PROVIDE NEW RESILIENT FLOORING THROUGHOUT, TYP. AT GROUND LEVEL UNITS.
- 6 PROVIDE CARPET FLOORING THROUGHOUT, TYP. AT UPPER LEVEL UNITS.
- 7 PROVIDE NEW RESILIENT FLOORING AT BATHROOMS, TYP. AT UPPER LEVEL UNITS.

MISCELLANEOUS LINTEL SCHEDULE

- 1 NEW 3'-0" OPENINGS IN BEARING AND NON-BEARING WALLS TO HAVE NEW 4" X 6" LINTELS BEARING ON A MINIMUM OF TWO (2) STUDS EACH END OR TWO (2) 2" X 6" WITH 1/2" PLYWOOD FLITCH PLATE

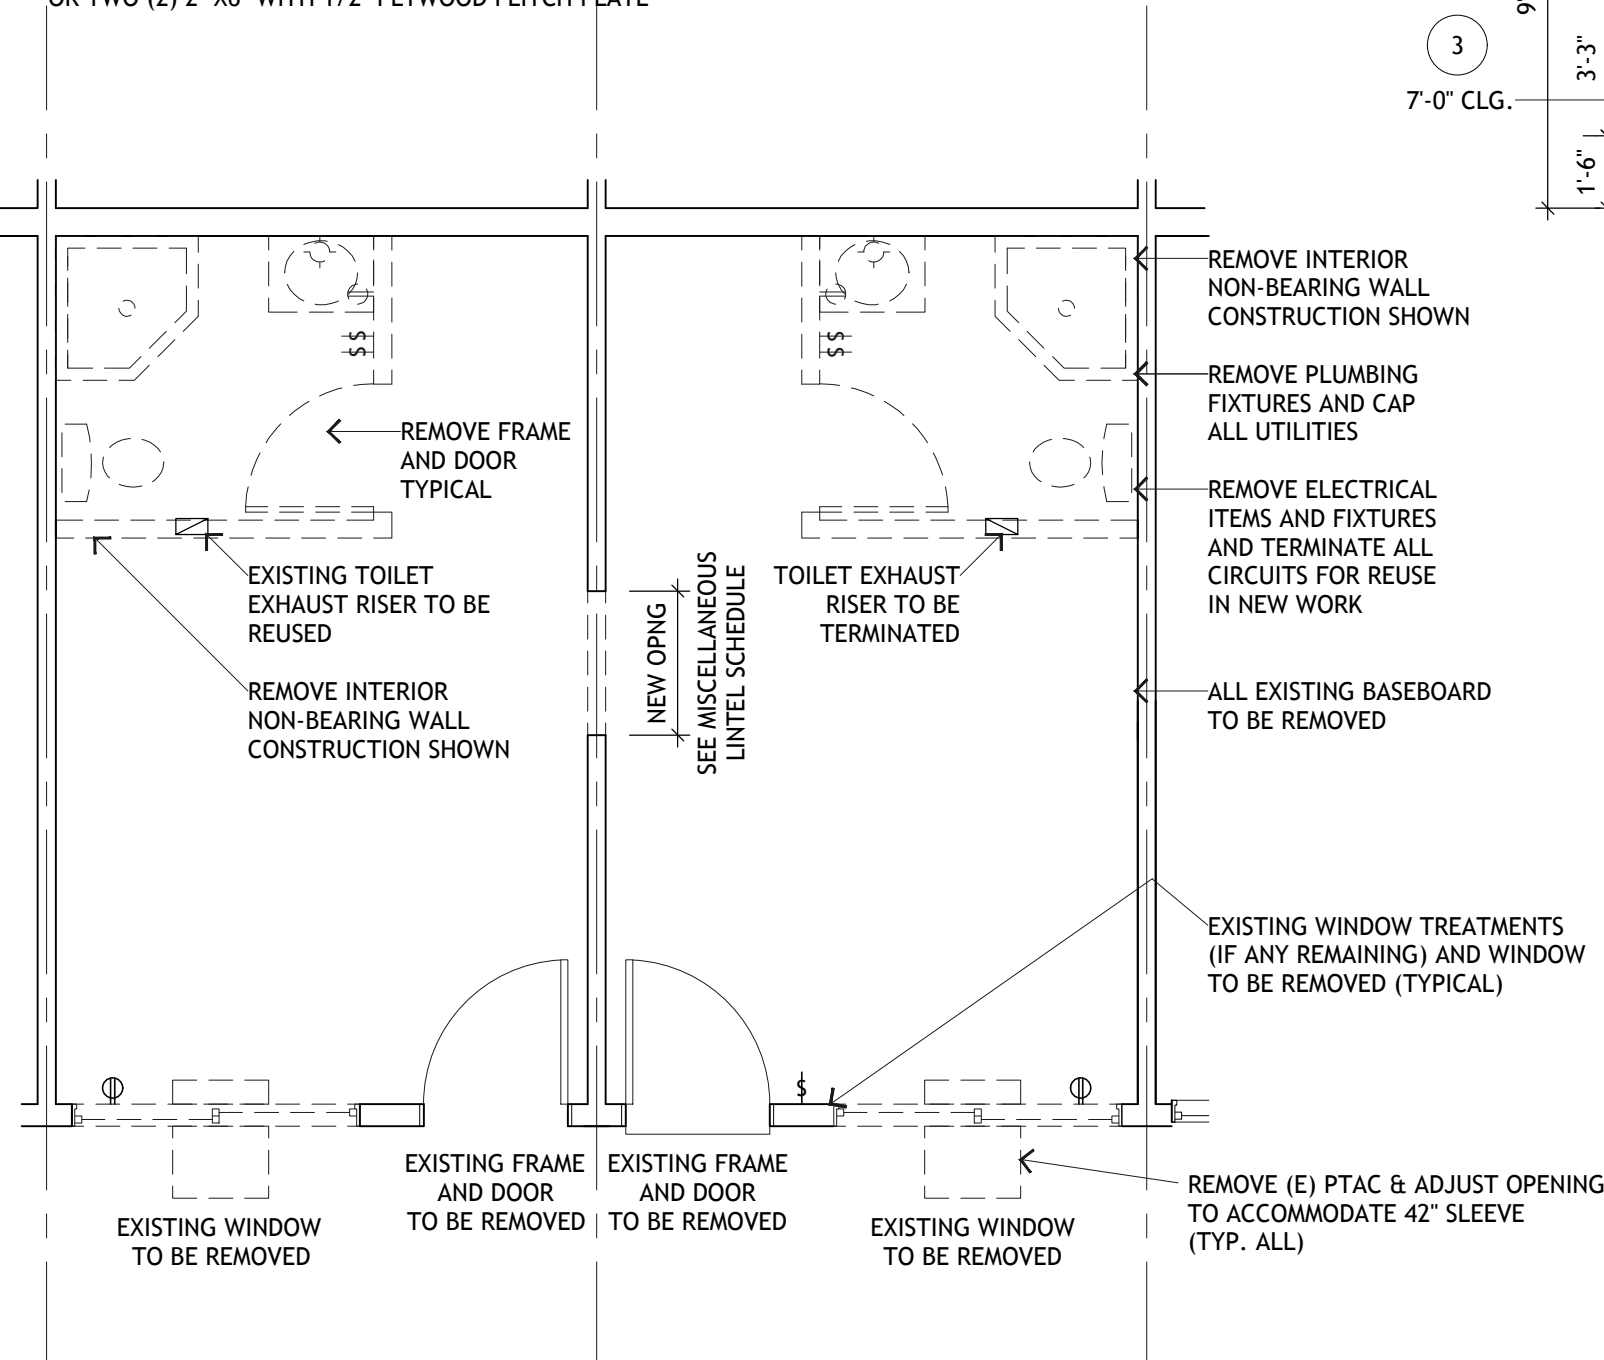


2 TYPICAL SIDE BY SIDE UNIT DEMOLITION PLAN
SCALE: 1/4" = 1'-0"

ROOM FINISH SCHEDULE
TYPICAL IN-LINE ACCESSIBLE GROUND FLOOR ACCESSIBLE UNIT


ROOM #	ROOM DESCRIPTION	FLOOR	BASE	WALLS	CEILING	NOTES
100	ACCESSIBLE REMODELED LIVING ROOM	NEW VINYL ON EXISTING CONCRETE SLAB ON GRADE	NEW 4" COVE VINYL BASE	EXISTING AND NEW GYP BRD TO BE PAINTED	EXISTING GYP BRD TO BE PAINTED	- - -
101	ACCESSIBLE REMODELED BEDROOM	NEW VINYL ON EXISTING CONCRETE SLAB ON GRADE	NEW 4" COVE VINYL BASE	EXISTING GYP BRD TO BE PAINTED	EXISTING GYP BRD TO BE PAINTED	- - -
102	ACCESSIBLE REMODELED BATHROOM	NEW VINYL ON EXISTING CONCRETE SLAB ON GRADE	NEW 4" COVE VINYL BASE	EXISTING GYP BRD TO BE PAINTED	EXISTING GYP BRD TO BE PAINTED	- - -

GENERAL NOTES FOR INTERIOR FINISHES:

- 1 NEW GYP BRD REQUIRED IN ANY CONSTRUCTION TO HAVE TEXTURED FINISH TO MATCH EXISTING ADJACENT FINISH
- 2 ALL NEW PAINT COLORS TO BE SELECTED BY OWNER FROM STANDARD COLORS
- 3 CONSTRUCTION CLEANING REQUIRED TO INCLUDE, BUT NOT BE LIMITED TO, TO THOROUGHLY CLEANING ANY EXISTING FIXTURES, FAUCETS, LIGHTING FIXTURES, ETC., TO BE REUSED IN NEW WORK.
- 4 TAPE, SEAL AND TEXTURE TO MATCH (E) AT EXPANDED PTAC SLEEVES. TRIM W/ (N) WOOD.

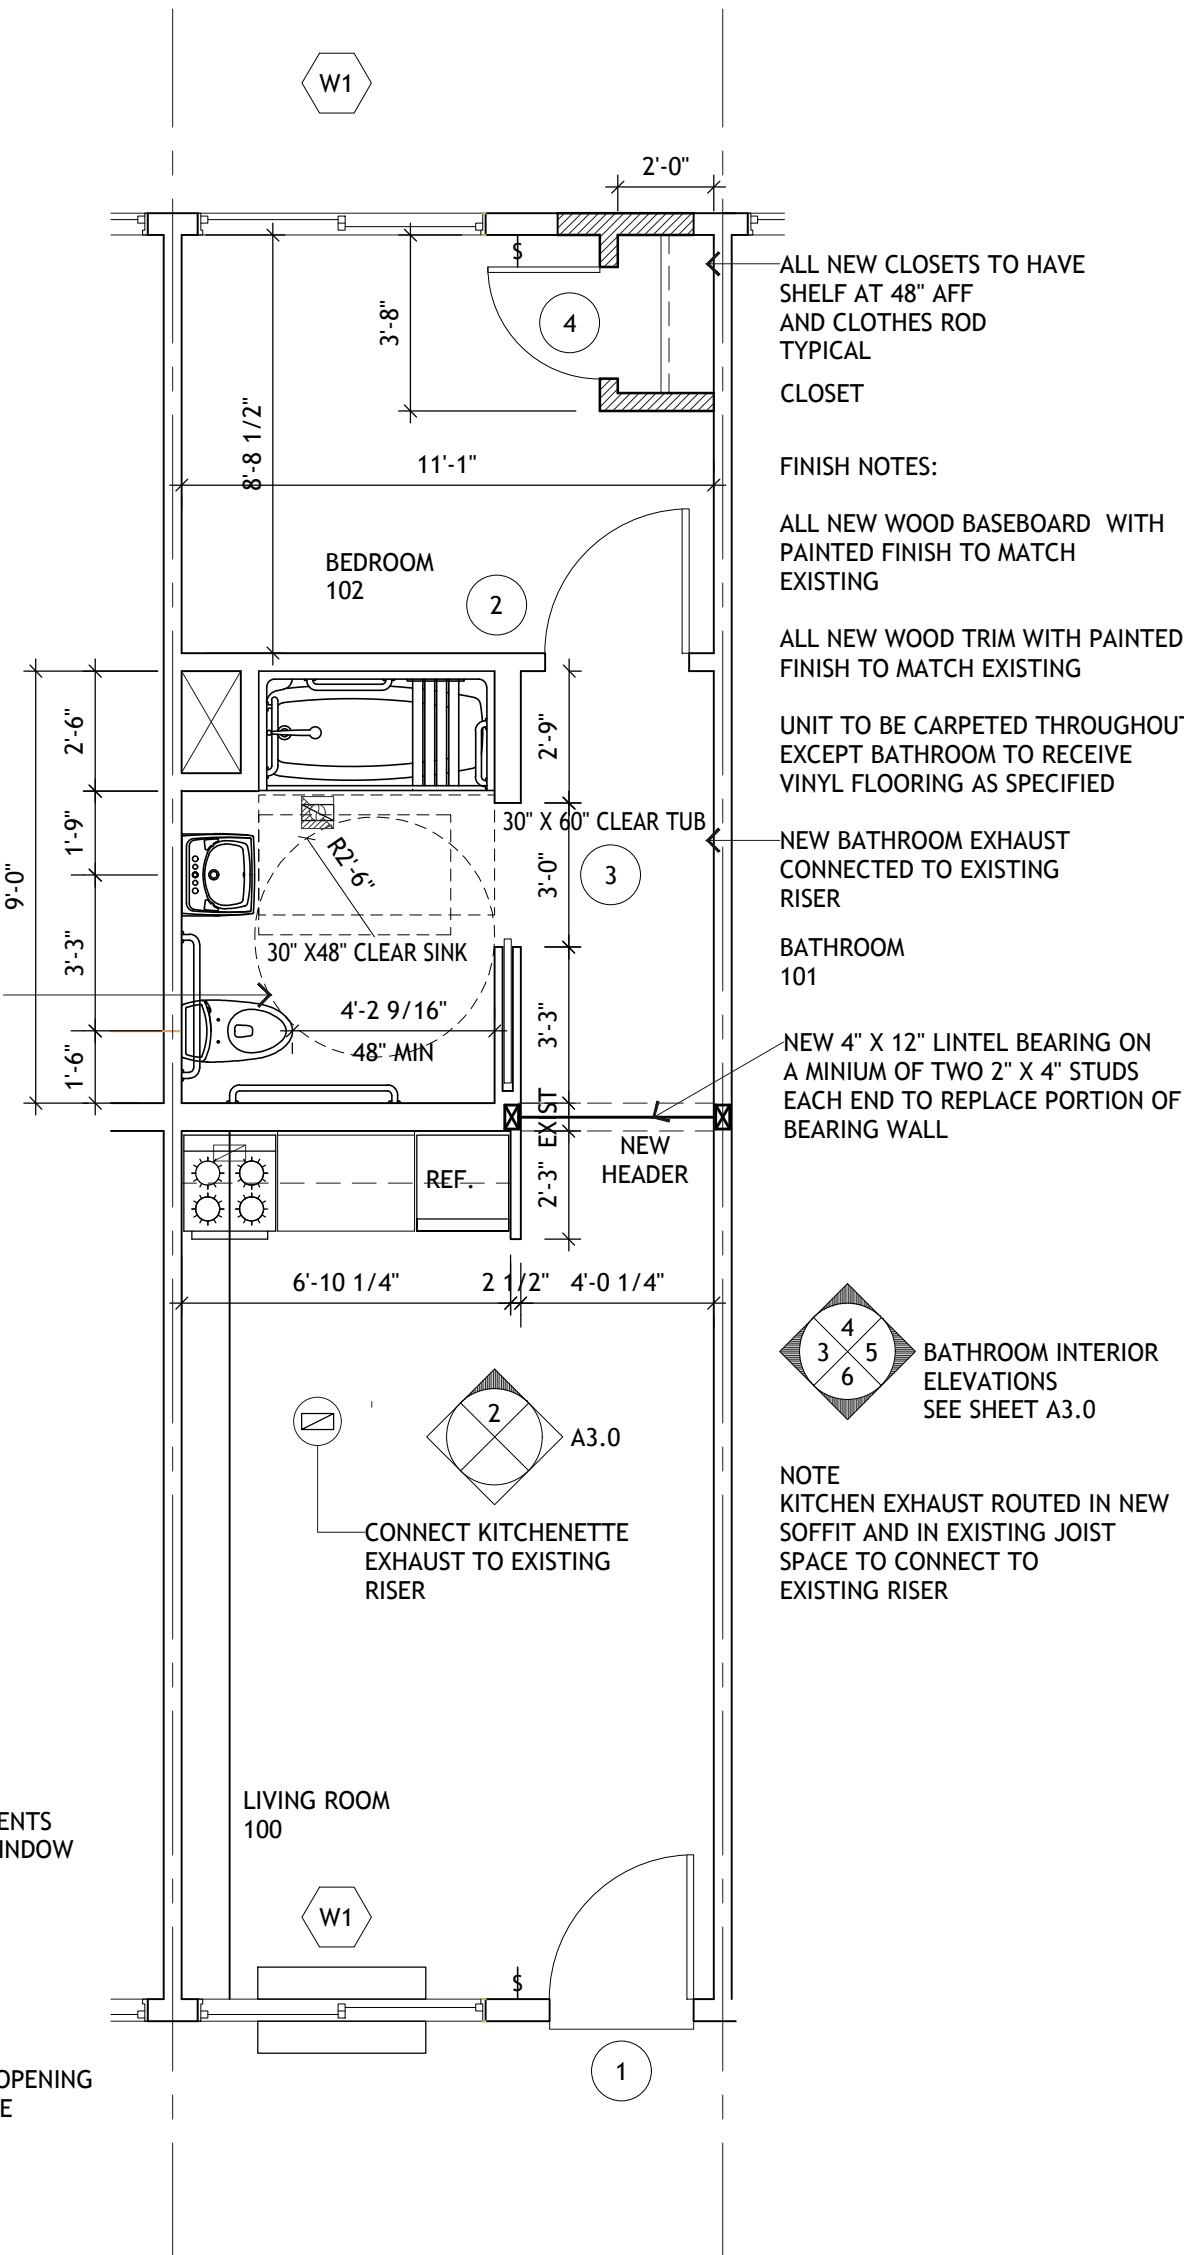

3 IN-LINE ACCESSIBLE UNIT (UNIT 9)
REMODELED PLAN
SCALE: 1/4" = 1'-0"

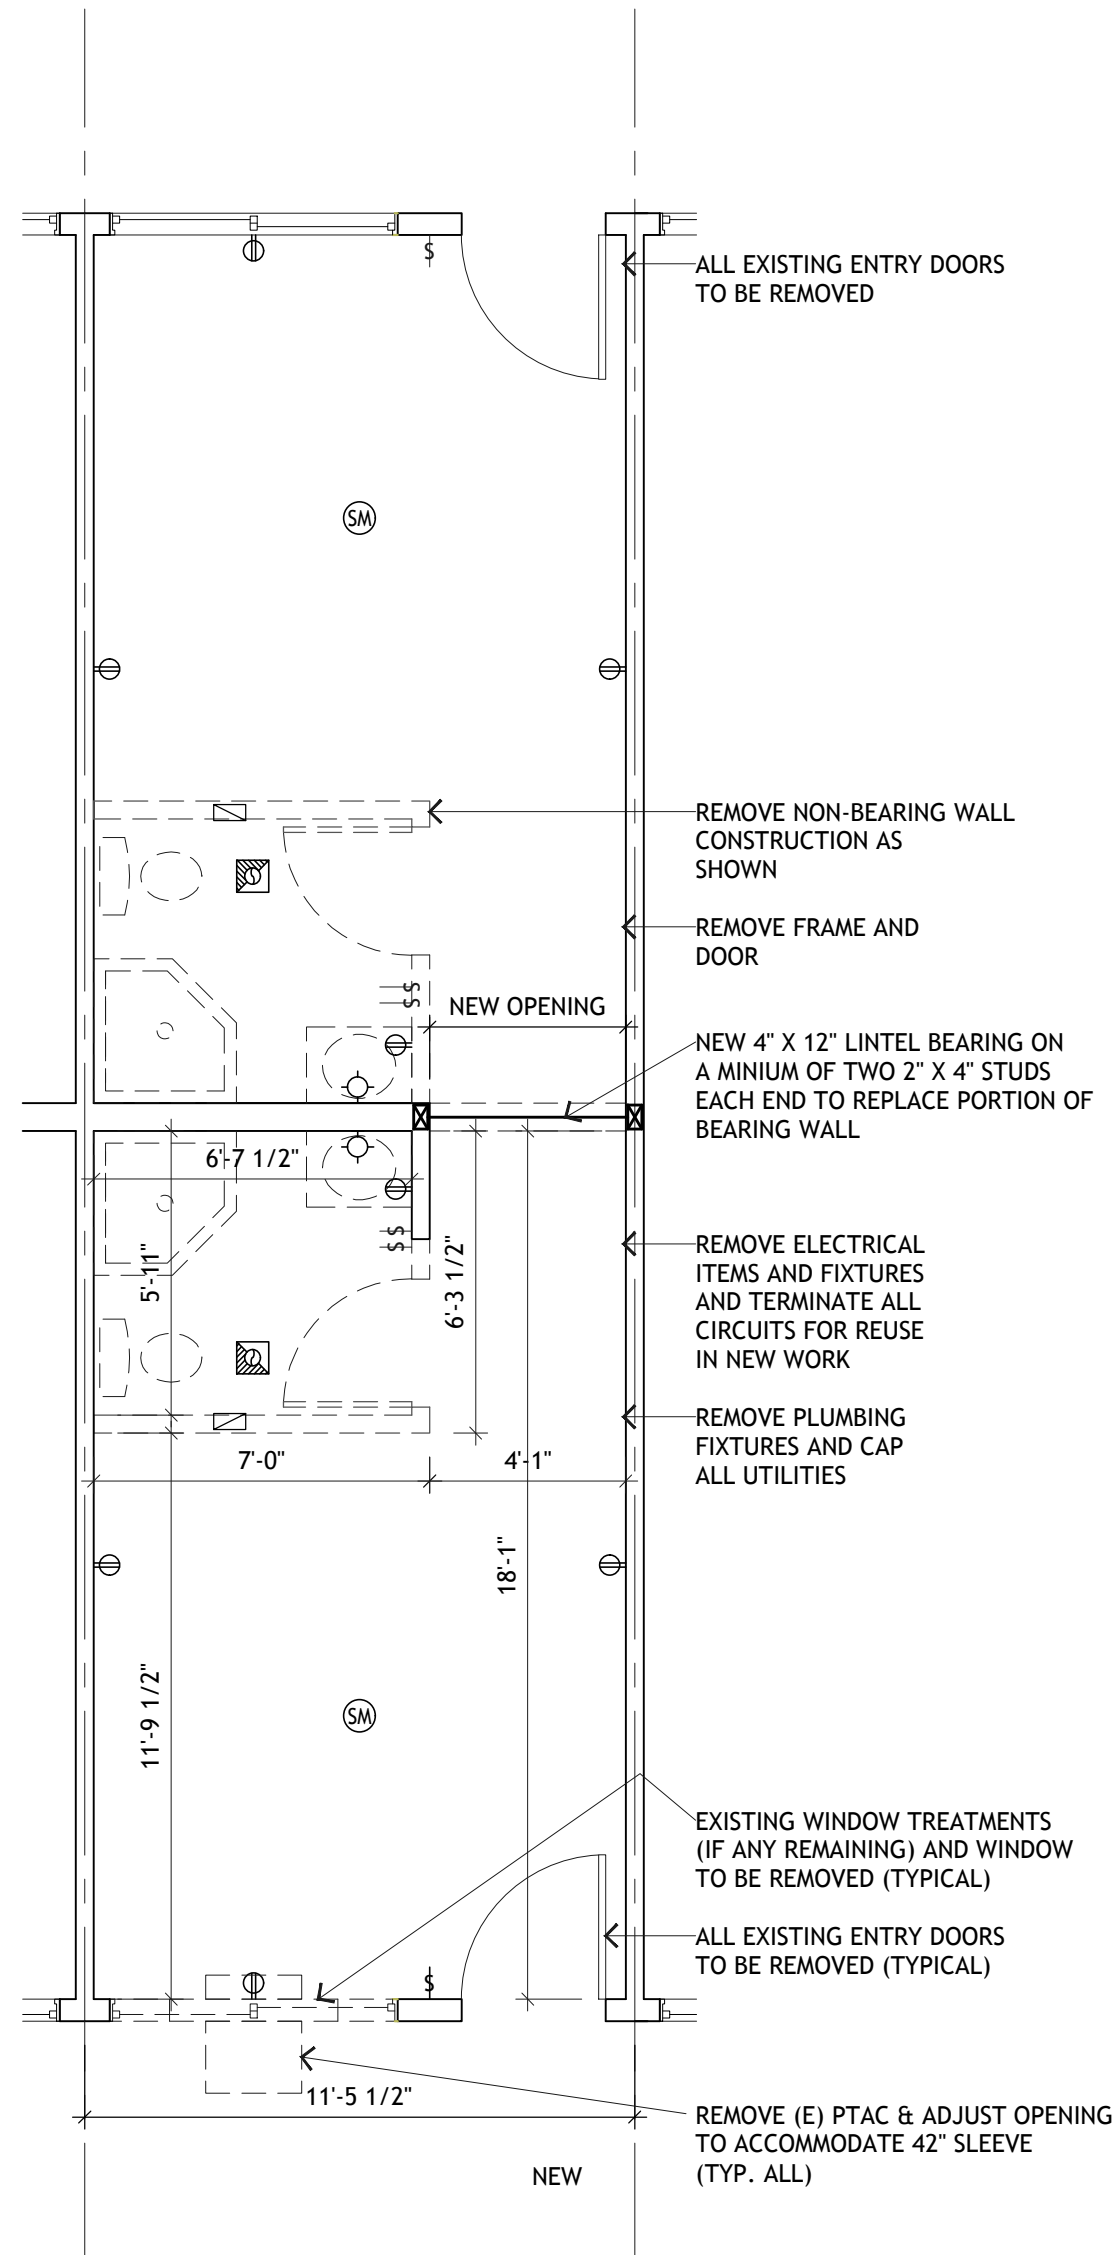

4 TYPICAL IN-LINE UNIT DEMOLITION PLAN
SCALE: 1/4" = 1'-0"

2130 FOURTH ST
SAN RAFAEL, CA 94901
PHONE (415) 457-6035
FAX (415) 457-6036

P.O.BOX 150539
SAN RAFAEL, CA 94915

CHARLES PICK, ARCHITECT



DRAWING REVISION LOG

FOR BIO	5-15-2018

PROJECT NAME:

DESERT HAVEN
(QUEEN'S MOTEL)
RE-DEVELOPMENT

PROJECT LOCATION:

16959 STODDARD WELLS RI
VICTORVILLE, CA 92395

SHEET TITLE:

TYPICAL
UNIT PLANS

A1.2

- 1 IN ANY NEWLY CREATED SLEEPING ROOM, THE EXISTING AND NEW RECEPTACLES SHALL BE CONNECTED TO AN NEW ARC FAULT BREAKER IN THE ELECTRICAL PANEL THAT REPLACES THE EXISTING.
SEE ELECTRICAL DRAWINGS.
- 2 IN EXISTING MANAGER'S UNIT (NO CHANGES) THE EXISTING SMOKE AND CARBON MONOXIDE ALARMS ARE BATTERY OPERATED AND SHALL BE EXISTING TO REMAIN.
- 3 IN THE NEW (REMODELED) COMMUNITY ROOM AND REMODELED DWELLING UNITS, THE SMOKE AND CARBON MONOXIDE ALARMS SHALL BE POWERED FROM THE BUILDINGS ELECTRICAL POWER SYSTEM AND SHALL HAVE INTEGRAL BATTERY BACK UP.
- 4 NEW COMBINATION SMOKE AND CARBON MONOXIDE ALARMS SHALL BE LOCATED WITHIN PROXIMITY TO THE NEW GAS FUELED RANGES.
- 5 A COMBINATION SMOKE AND CARBON MONOXIDE ALARM IN EACH UNIT SHALL BE INTERCONNECTED IN SUCH A MANNER THAT ACTUATION OF ONE SHALL CAUSE ALL OTHER ALARMS IN THE UNIT TO BE ACTIVATED (CBC 907.2.11, CRC R314, CRC R315).
- 6 A SMOKE ALARM, POWERED BY THE BUILDINGS FROM THE PERMANENT BUILDINGS ELECTRICAL SYSTEM SHALL BE PROVIDED IN EVERY SLEEPING ROOM AND SHALL HAVE INTEGRAL BATTERY BACKUP.
- 7 ALL SMOKE AND CARBON MONOXIDE ALARMS SHALL BE ON A CIRCUIT PROTECTED WITH A COMBINATION ARC FAULT CIRCUIT INTERRUPTER (2010 NEC 210.12).
- 8 IN GROUND FLOOR ACCESSIBLE DWELLING UNITS ALARM SHALL HAVE AUDIBLE AND VISUAL ALARMS.
- 9 AUDIBLE ALARMS SHALL PRODUCE A SOUND THAT EXCEEDS THE PREVAILING EQUIVALENT SOUND LEVEL IN THE ROOM OR SPACE BY AT LEAST 15 DECIBELS
OR EXCEEDS ANY MAXIMUM SOUND LEVEL WITH A DURATION OF 30 SECONDS BY 5 DECIBELS, WHICHEVER IS LOUDER.
SOUND LEVELS FOR ALARM SIGNALS SHALL NOT EXCEED 120 DECIBELS.
(UFAS 4.28.2)

ROOM FINISH SCHEDULE						
TYPICAL NON-ACCESSIBLE EFFICIENCY UNIT (GROUND OR SECOND)						
ROOM #	ROOM DESCRIPTION	FLOOR	BASE	WALLS	CEILING	NOTES
100	LIVING ROOM	NEW VINYL ON EXISTING CONCRETE SLAB ON GRADE (GROUND FLOOR) OR TOPPING SLAB (SECOND FLOOR)	NEW 4" COVE VINYL BASE	EXISTING GYP BRD TO BE PAINTED	EXISTING GYP BRD TO BE PAINTED	PATCH AND REPAIR EXISTING GYP BRD SURFACES AS REQD - -
101	BATHROOM	NEW VINYL ON EXISTING CONCRETE SLAB ON GRADE (GROUND FLOOR) OR TOPPING SLAB (SECOND FLOOR)	NEW 4" COVE VINYL BASE	EXISTING GYP BRD TO BE PAINTED	(N) OR (E) GYP BRD TO BE PAINTED	PATCH AND REPAIR EXISTING GYP BRD SURFACES AS REQD - -

- 1 NEW GYP BRD REQUIRED IN ANY CONSTRUCTION TO HAVE TEXTURED FINISH TO MATCH EXISTING ADJACENT FINISH
- 2 ALL NEW PAINT COLORS TO BE SELECTED BY OWNER FROM STANDARD COLORS
- 3 CONSTRUCTION CLEANING REQUIRED TO INCLUDE, BUT NOT BE LIMITED TO, TO THOROUGHLY CLEANING ANY EXISTING FIXTURES, FAUCETS, LIGHTING FIXTURES, ETC., TO BE REUSED IN NEW WORK.




- | ROOM # | ROOM DESCRIPTION | FLOOR | BASE | WALLS | CEILING | NOTES |
|--------|----------------------------------|--|------------------------|--|----------------------------------|-------------|
| 100 | ACCESSIBLE REMODELED LIVING ROOM | NEW VINYL ON EXISTING CONCRETE SLAB ON GRADE | NEW 4" COVE VINYL BASE | EXISTING AND NEW GYP BRD TO BE PAINTED | EXISTING GYP BRD TO BE PAINTED | -
-
- |
| 101 | ACCESSIBLE REMODELED BEDROOM | NEW VINYL ON EXISTING CONCRETE SLAB ON GRADE | NEW 4" COVE VINYL BASE | EXISTING GYP BRD TO BE PAINTED | EXISTING GYP BRD TO BE PAINTED | -
-
- |
| 102 | ACCESSIBLE REMODELED BATHROOM | NEW VINYL ON EXISTING CONCRETE SLAB ON GRADE | NEW 4" COVE VINYL BASE | EXISTING GYP BRD TO BE PAINTED | (N) OR (E) GYP BRD TO BE PAINTED | -
-
- |
| | | | | | | |


- 1 NEW GYP BRD REQUIRED IN ANY CONSTRUCTION TO HAVE TEXTURED FINISH TO MATCH EXISTING ADJACENT FINISH
- 2 ALL NEW PAINT COLORS TO BE SELECTED BY OWNER FROM STANDARD COLORS
- 3 CONSTRUCTION CLEANING REQUIRED TO INCLUDE, BUT NOT BE LIMITED TO, TO THOROUGHLY CLEANING ANY EXISTING FIXTURES, FAUCETS, LIGHTING FIXTURES, ETC., TO BE REUSED IN NEW WORK.




5 SEE INTERIOR ELEVATIONS FOR ADAPTABILITY REQUIREMENTS.

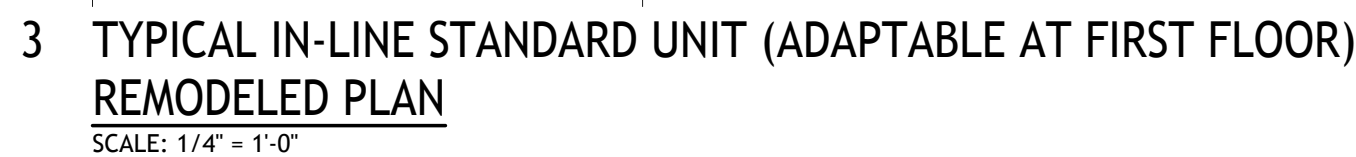

A1.3

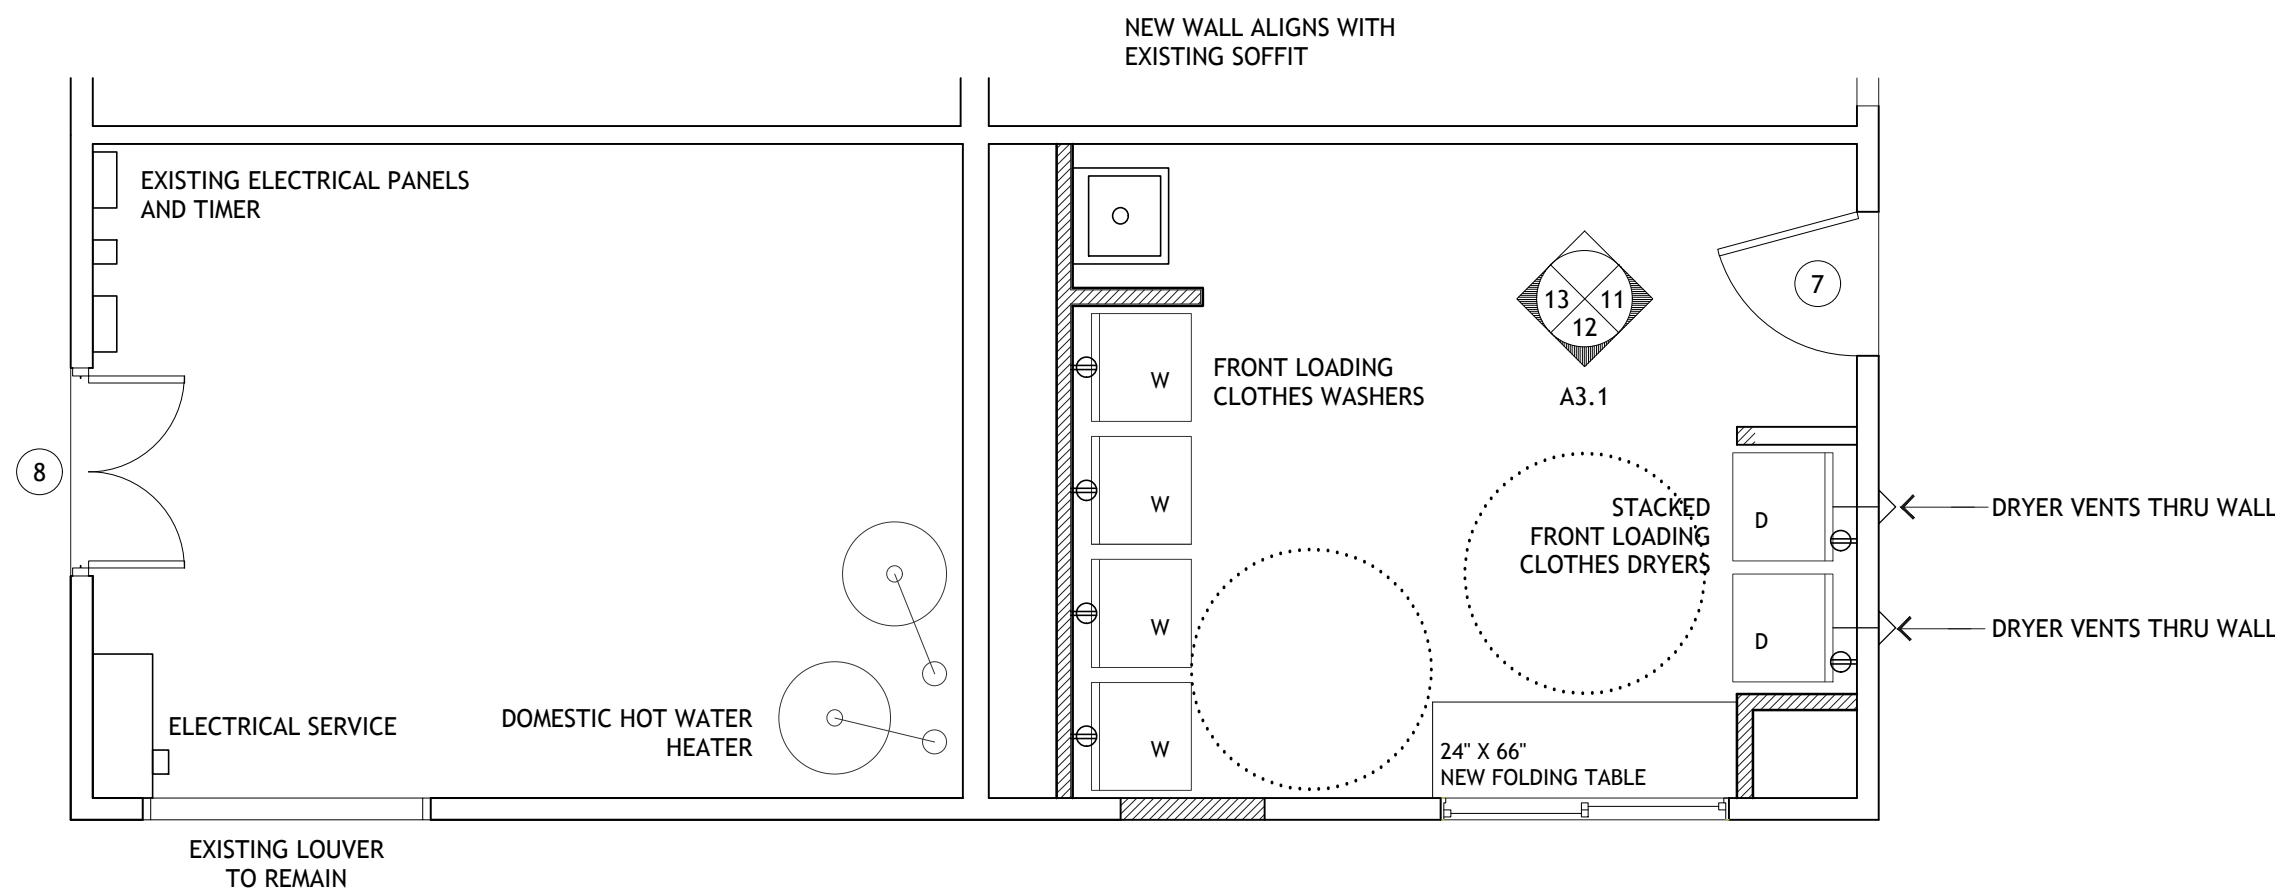


4 REMODELED COMMON LAUNDRY PLAN
SCALE: 1/4" = 1'-0"

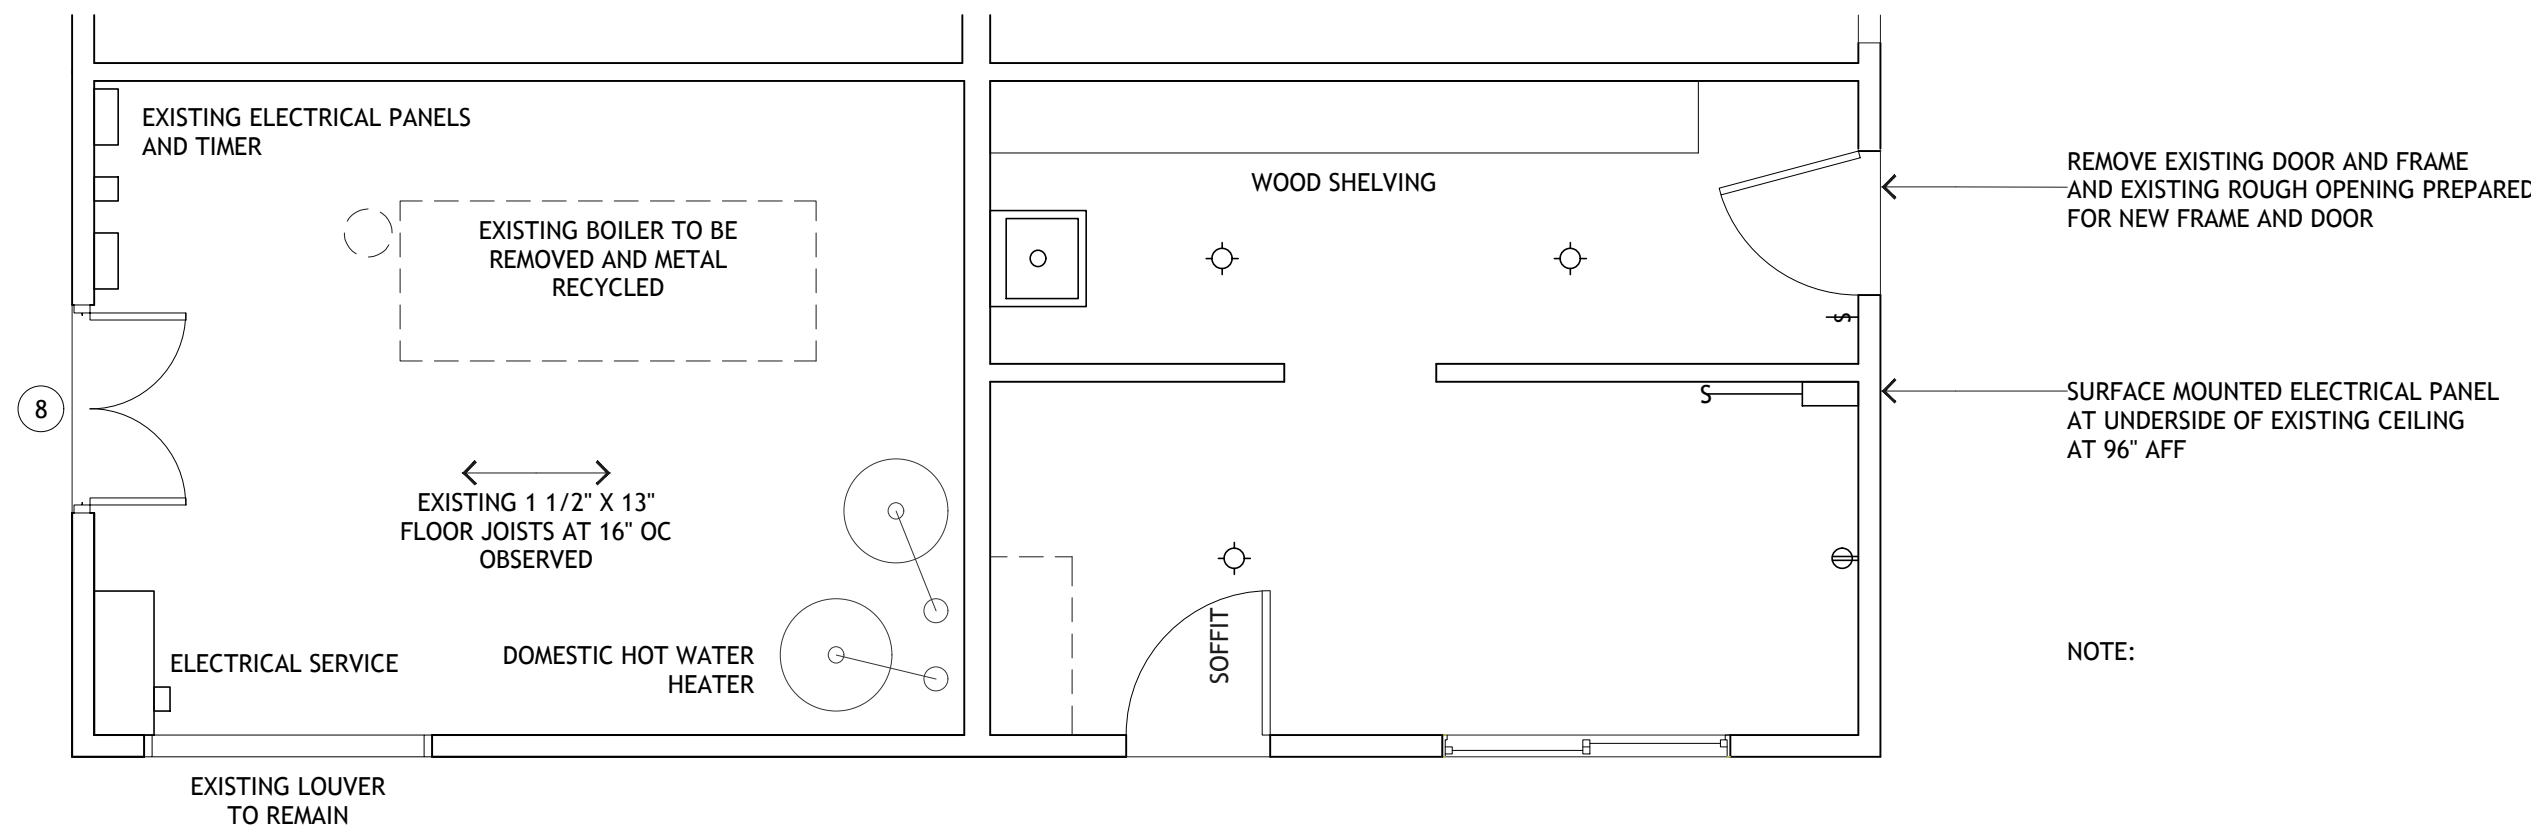


5 EXISTING CONDITIONS AND DEMOLITION - LAUNDRY AND MECHANICAL ROOM
SCALE: 1/4" = 1'-0"

ROOM FINISH SCHEDULE UNITS 211 + 212						
ROOM #	ROOM DESCRIPTION	FLOOR	BASE	WALLS	CEILING	NOTES
100	REMODELED LIVING ROOM	NEW VINYL ON EXISTING CONCRETE TOPPING SLAB	NEW 4" COVE VINYL BASE	EXISTING AND NEW GYP BRD TO BE PAINTED	EXISTING GYP BRD TO BE PAINTED	- - -
101	REMODELED BEDROOM	NEW VINYL ON EXISTING CONCRETE TOPPING SLAB	NEW 4" COVE VINYL BASE	EXISTING GYP BRD TO BE PAINTED	EXISTING GYP BRD TO BE PAINTED	- - -
102	REMODELED BATHROOM	NEW VINYL ON EXISTING CONCRETE TOPPING SLAB	NEW 4" COVE VINYL BASE	EXISTING GYP BRD TO BE PAINTED	EXISTING GYP BRD TO BE PAINTED	- - -


- GENERAL NOTES FOR INTERIOR FINISHES:
- 1 NEW GYP BRD REQUIRED IN ANY CONSTRUCTION TO HAVE TEXTURED FINISH TO MATCH EXISTING ADJACENT FINISH
 - 2 ALL NEW PAINT COLORS TO BE SELECTED BY OWNER FROM STANDARD COLORS
 - 3 CONSTRUCTION CLEANING REQUIRED TO INCLUDE, BUT NOT BE LIMITED TO, TO THOROUGHLY CLEANING ANY EXISTING FIXTURES, FAUCETS, LIGHTING FIXTURES, ETC., TO BE REUSED IN NEW WORK.

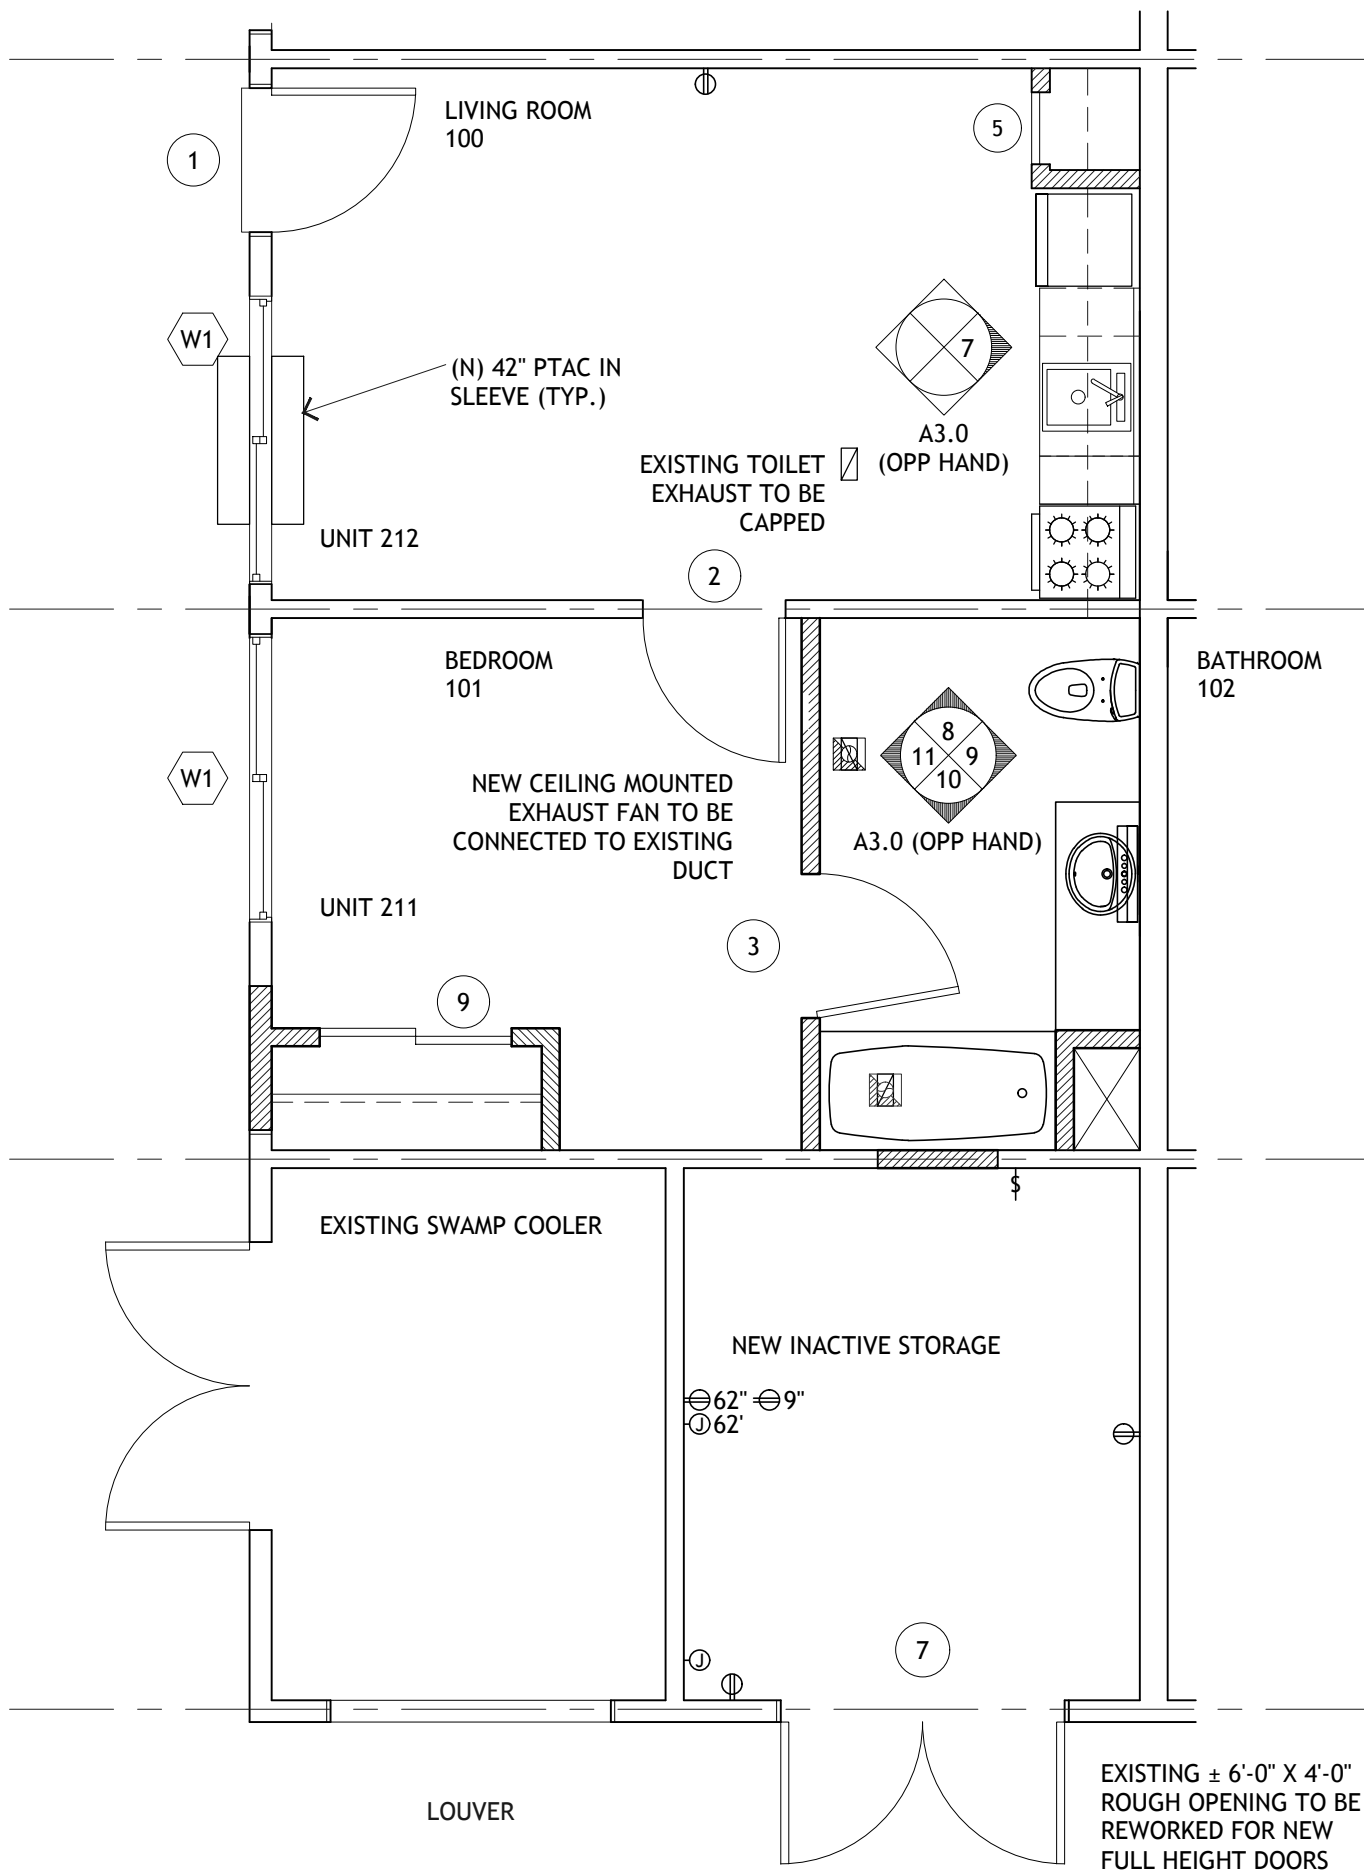

1 REMODELED PLAN UNITS 211 + 212
SCALE: 1/4" = 1'-0"

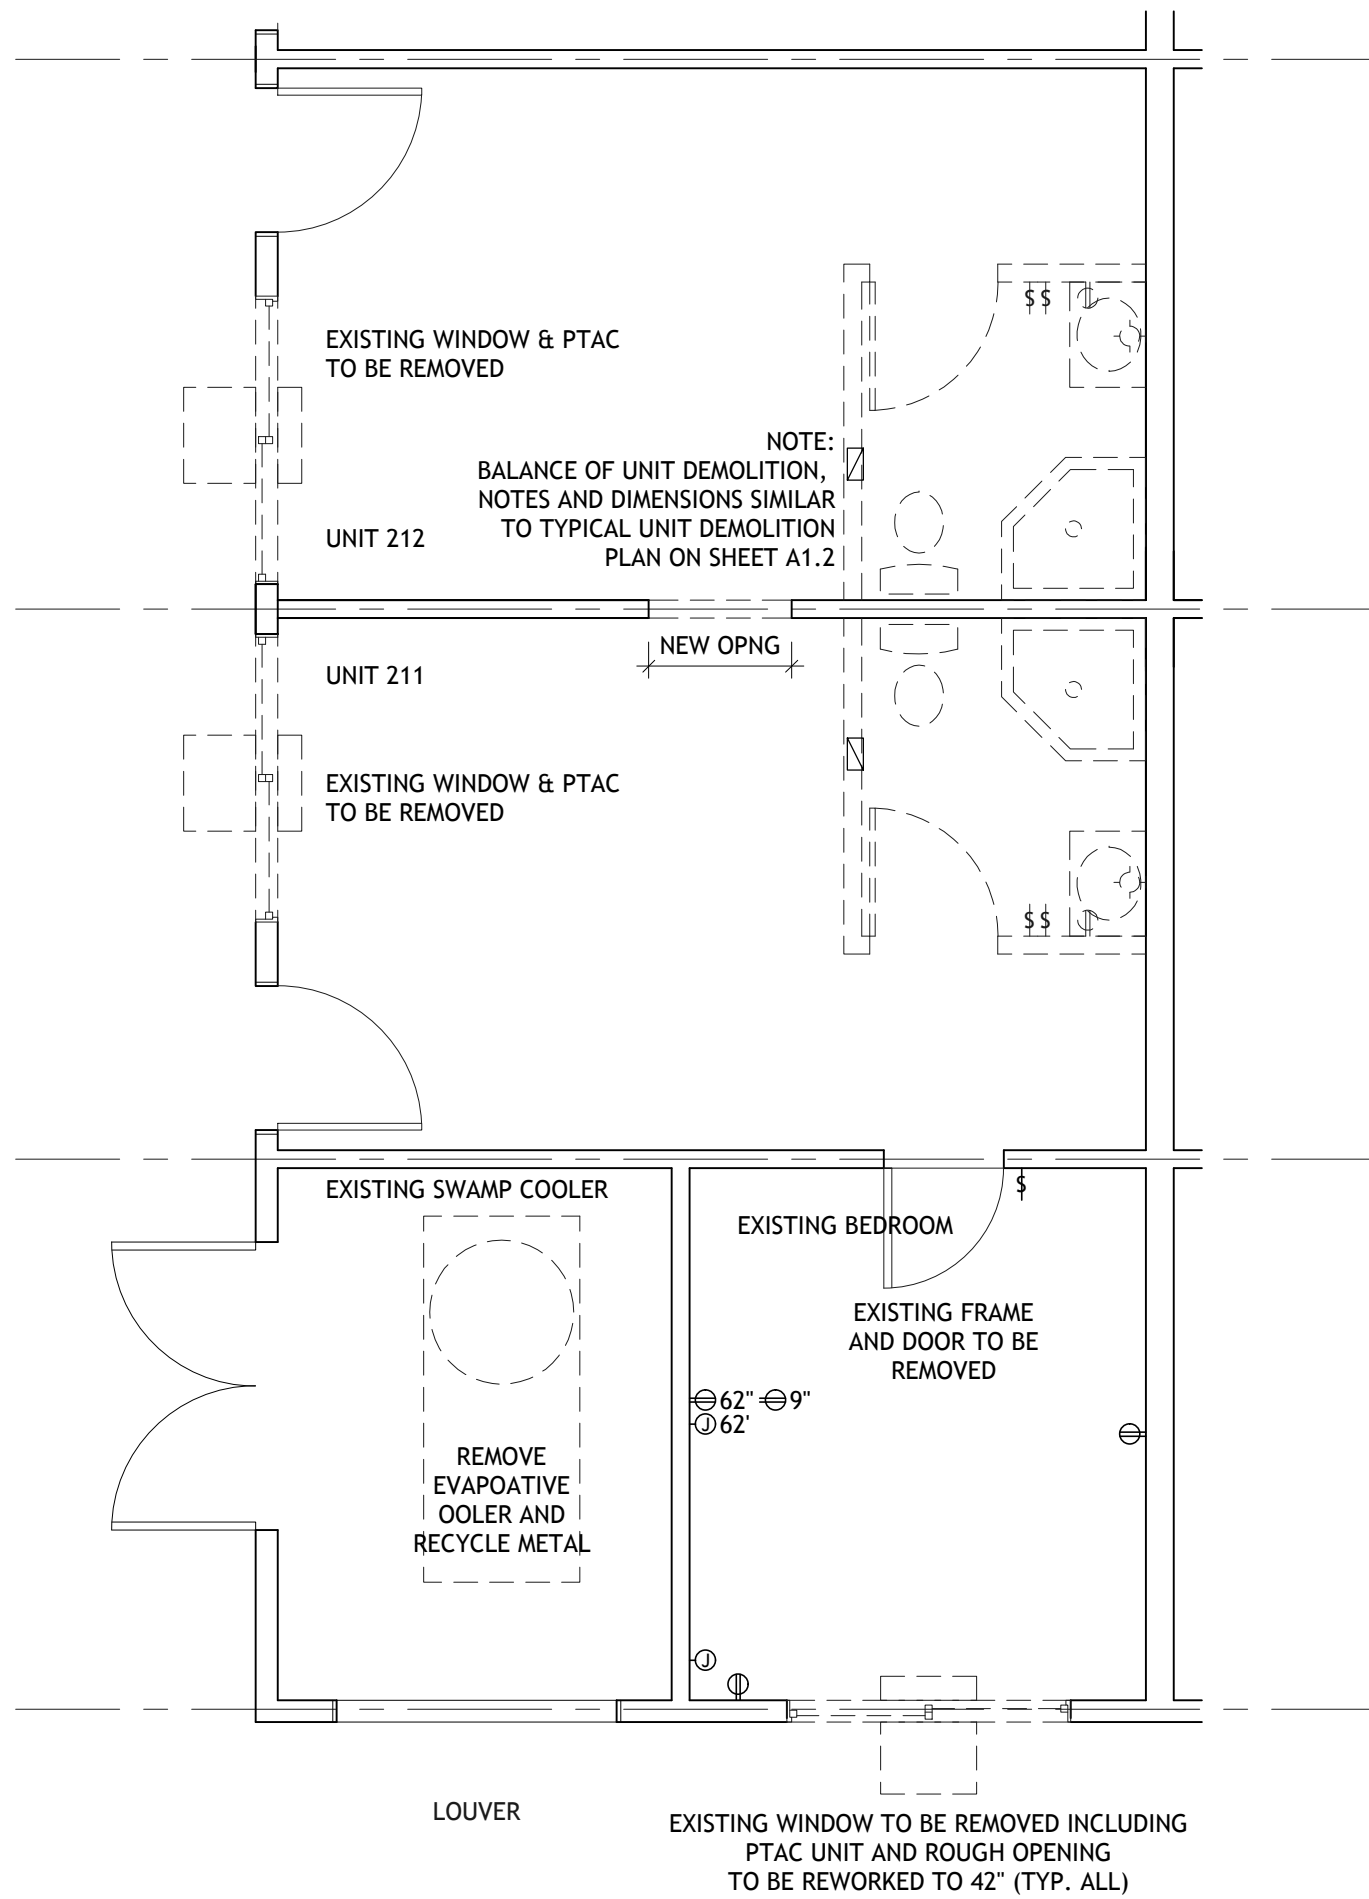

2 DEMOLITION PLAN UNITS 211 + 212
SCALE: 1/4" = 1'-0"

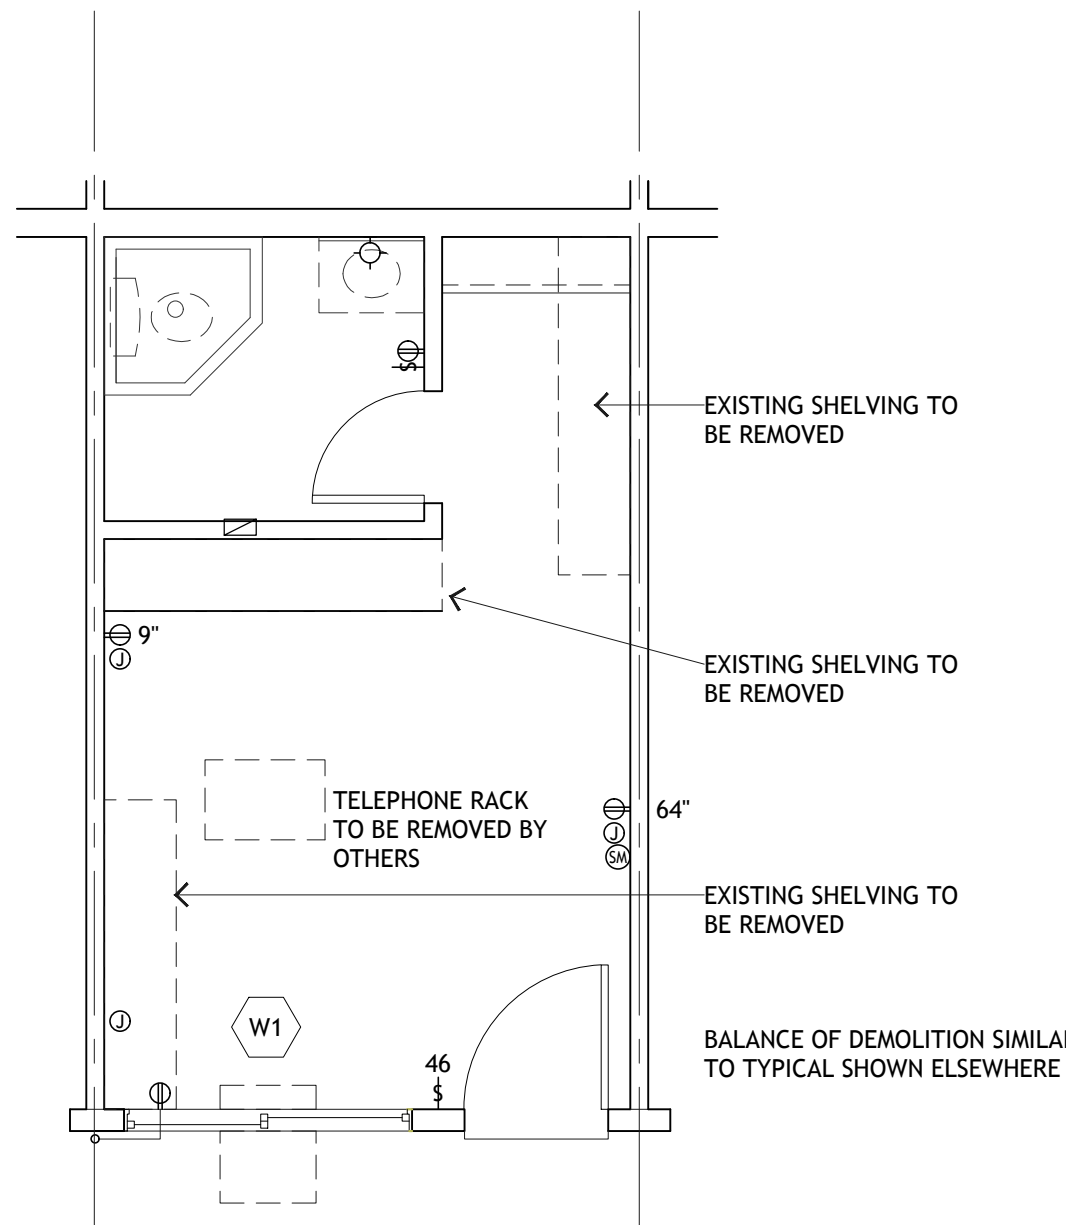

3 ADDITIONAL DEMOLITION REQD IN UNIT 107
SCALE: 1/4" = 1'-0"

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DETAIL
PLANS





A1.4

ROOM FINISH SCHEDULE GROUND FLOOR MANAGER'S UNIT						
ROOM #	ROOM DESCRIPTION	FLOOR	BASE	WALLS	CEILING	NOTES
M - 100	LIVING ROOM	NEW VINYL ON EXISTING CONCRETE SLAB ON GRADE	NEW 4" COVE VINYL BASE	EXISTING GYP BRD TO BE PAINTED	EXISTING GYP BRD TO BE PAINTED	- - -
M - 101	DINING ROOM	NEW VINYL ON EXISTING CONCRETE SLAB ON GRADE	NEW 4" COVE VINYL BASE	EXISTING GYP BRD TO BE PAINTED	EXISTING GYP BRD TO BE PAINTED	- - -
M - 102	KITCHEN	NEW VINYL ON EXISTING CONCRETE SLAB ON GRADE	NEW 4" COVE VINYL BASE	EXISTING GYP BRD TO BE PAINTED	EXISTING GYP BRD TO BE PAINTED	- - -
M - 103	BEDROOM	NEW VINYL ON EXISTING CONCRETE SLAB ON GRADE	NEW 4" COVE VINYL BASE	EXISTING GYP BRD TO BE PAINTED	EXISTING GYP BRD TO BE PAINTED	- - -
M - 104	BATHROOM	NEW VINYL ON EXISTING CONCRETE SLAB ON GRADE	NEW 4" COVE VINYL BASE	EXISTING GYP BRD TO BE PAINTED	EXISTING GYP BRD TO BE PAINTED	- - -

ROOM FINISH SCHEDULE ACCESSIBLE GROUND FLOOR OFFICE						
ROOM #	ROOM DESCRIPTION	FLOOR	BASE	WALLS	CEILING	NOTES
O - 100	EXISTING LOBBY	NEW VINYL ON EXISTING CONCRETE SLAB ON GRADE	NEW 4" COVE VINYL BASE	EXISTING AND NEW GYP BRD TO BE PAINTED	EXISTING GYP BRD TO BE PAINTED	SEE SHEET A5.0 FOR NEW ACCESSIBLE SERVICE COUNTER -
O - 101	EXISTING PUBLIC SPACE BEDROOM	NEW VINYL ON EXISTING CONCRETE SLAB ON GRADE	NEW 4" COVE VINYL BASE	EXISTING GYP BRD TO BE PAINTED	EXISTING GYP BRD TO BE PAINTED	- - -
O - 102	NEW UNISEX ACCESSIBLE TOILET	NEW VINYL ON EXISTING CONCRETE SLAB ON GRADE	NEW 4" COVE VINYL BASE	EXISTING GYP BRD TO BE PAINTED	EXISTING GYP BRD TO BE PAINTED	- - -

ROOM FINISH SCHEDULE ACCESSIBLE GROUND FLOOR COMMUNITY ROOM						
ROOM #	ROOM DESCRIPTION	FLOOR	BASE	WALLS	CEILING	NOTES
100	MULTI-PURPOSE ROOM LIVING ROOM	NEW VINYL ON EXISTING CONCRETE SLAB ON GRADE	NEW 4" COVE VINYL BASE	GYP BRD TO BE PAINTED	GYP BRD TO BE PAINTED	- - -
101	WOMEN'S ACCESSIBLE TOILET	NEW VINYL ON EXISTING CONCRETE SLAB ON GRADE	NEW 4" COVE VINYL BASE	GYP BRD TO BE PAINTED	GYP BRD TO BE PAINTED	- - -
102	MEN'S ACCESSIBLE TOILET	NEW VINYL ON EXISTING CONCRETE SLAB ON GRADE	NEW 4" COVE VINYL BASE	GYP BRD TO BE PAINTED	GYP BRD TO BE PAINTED	- - -

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BASIS Architecture & Consulting

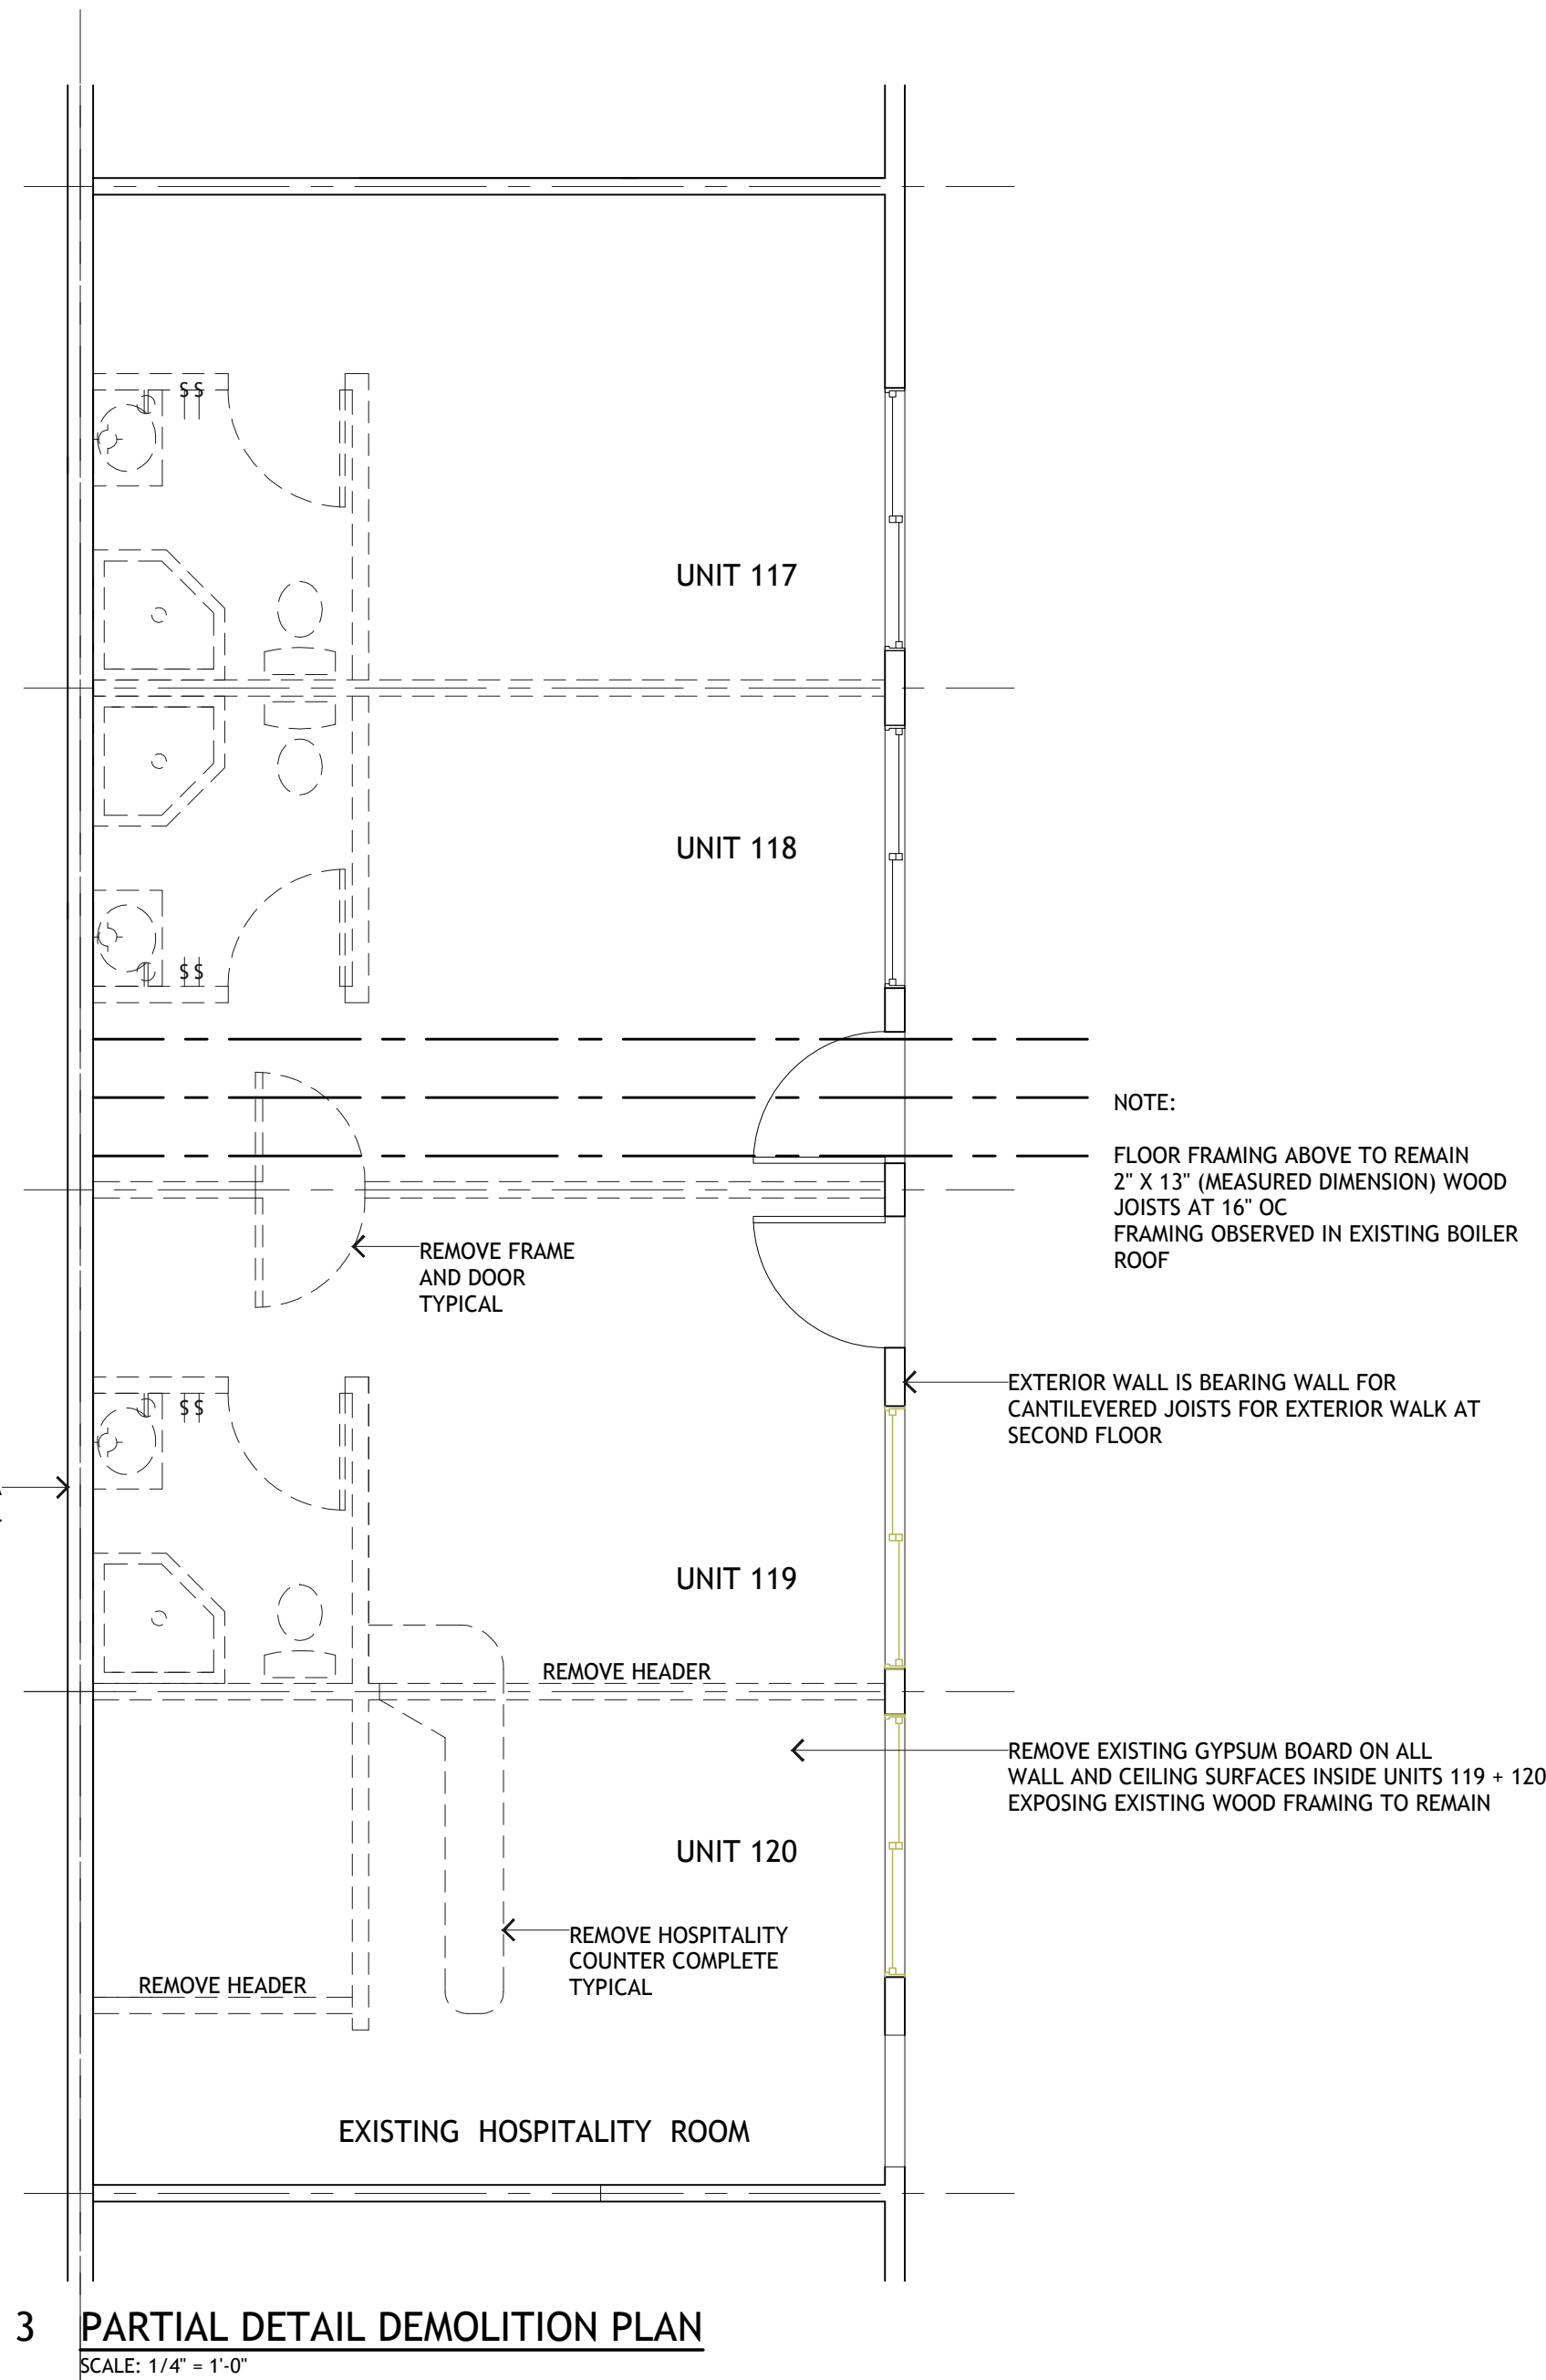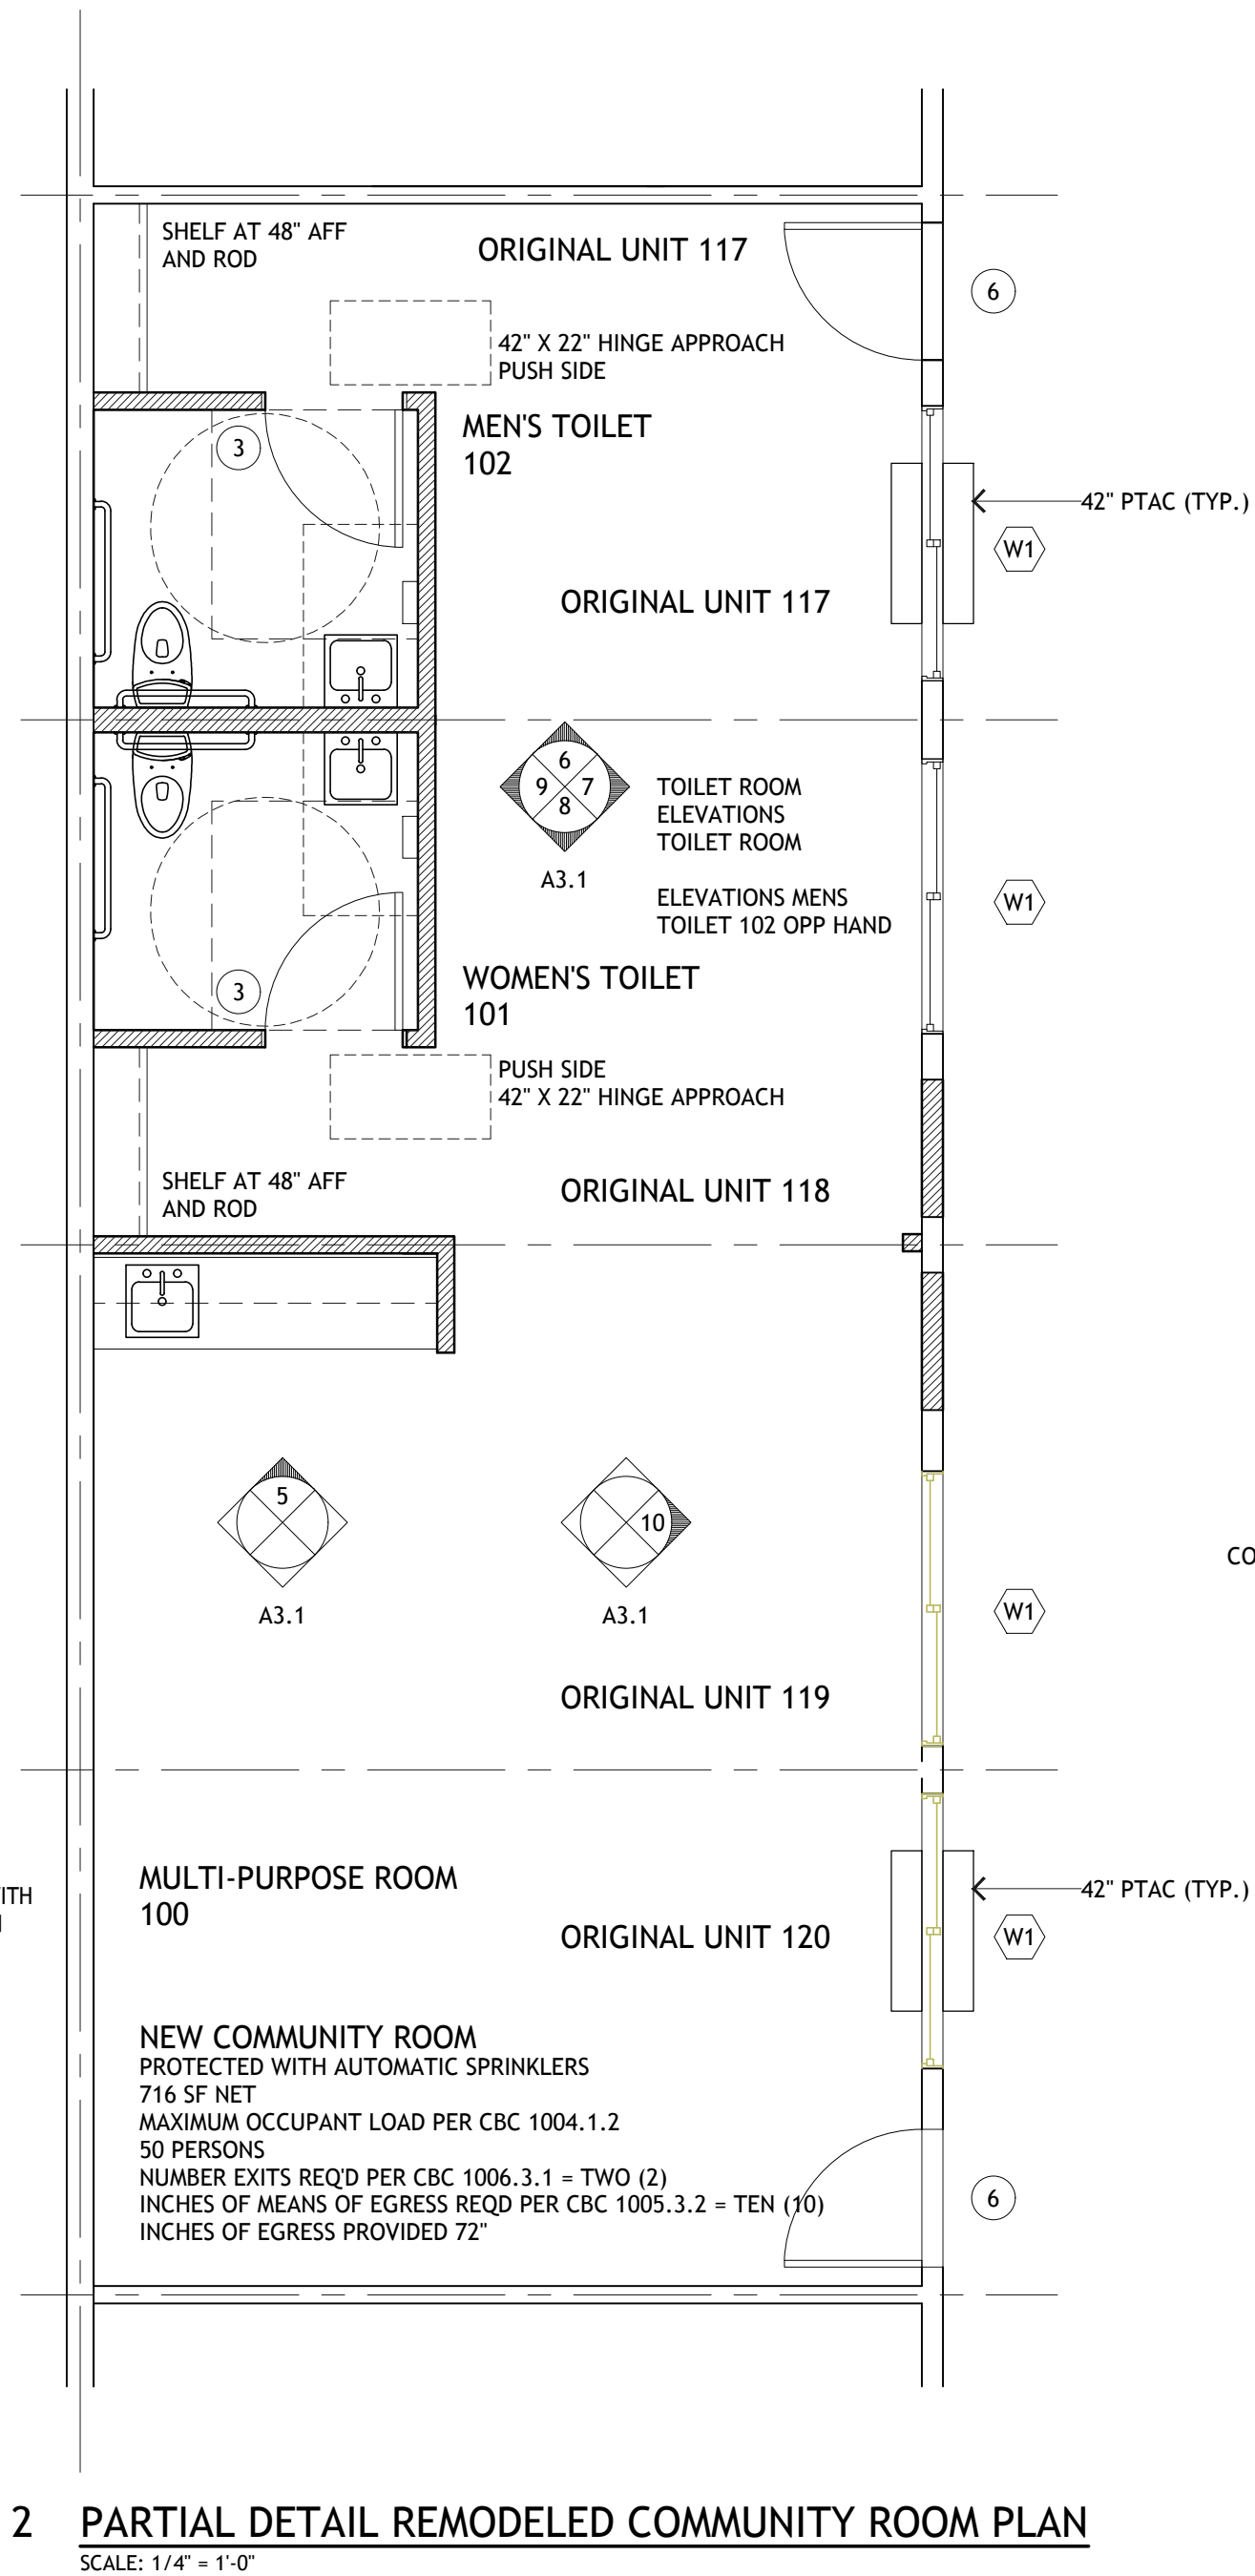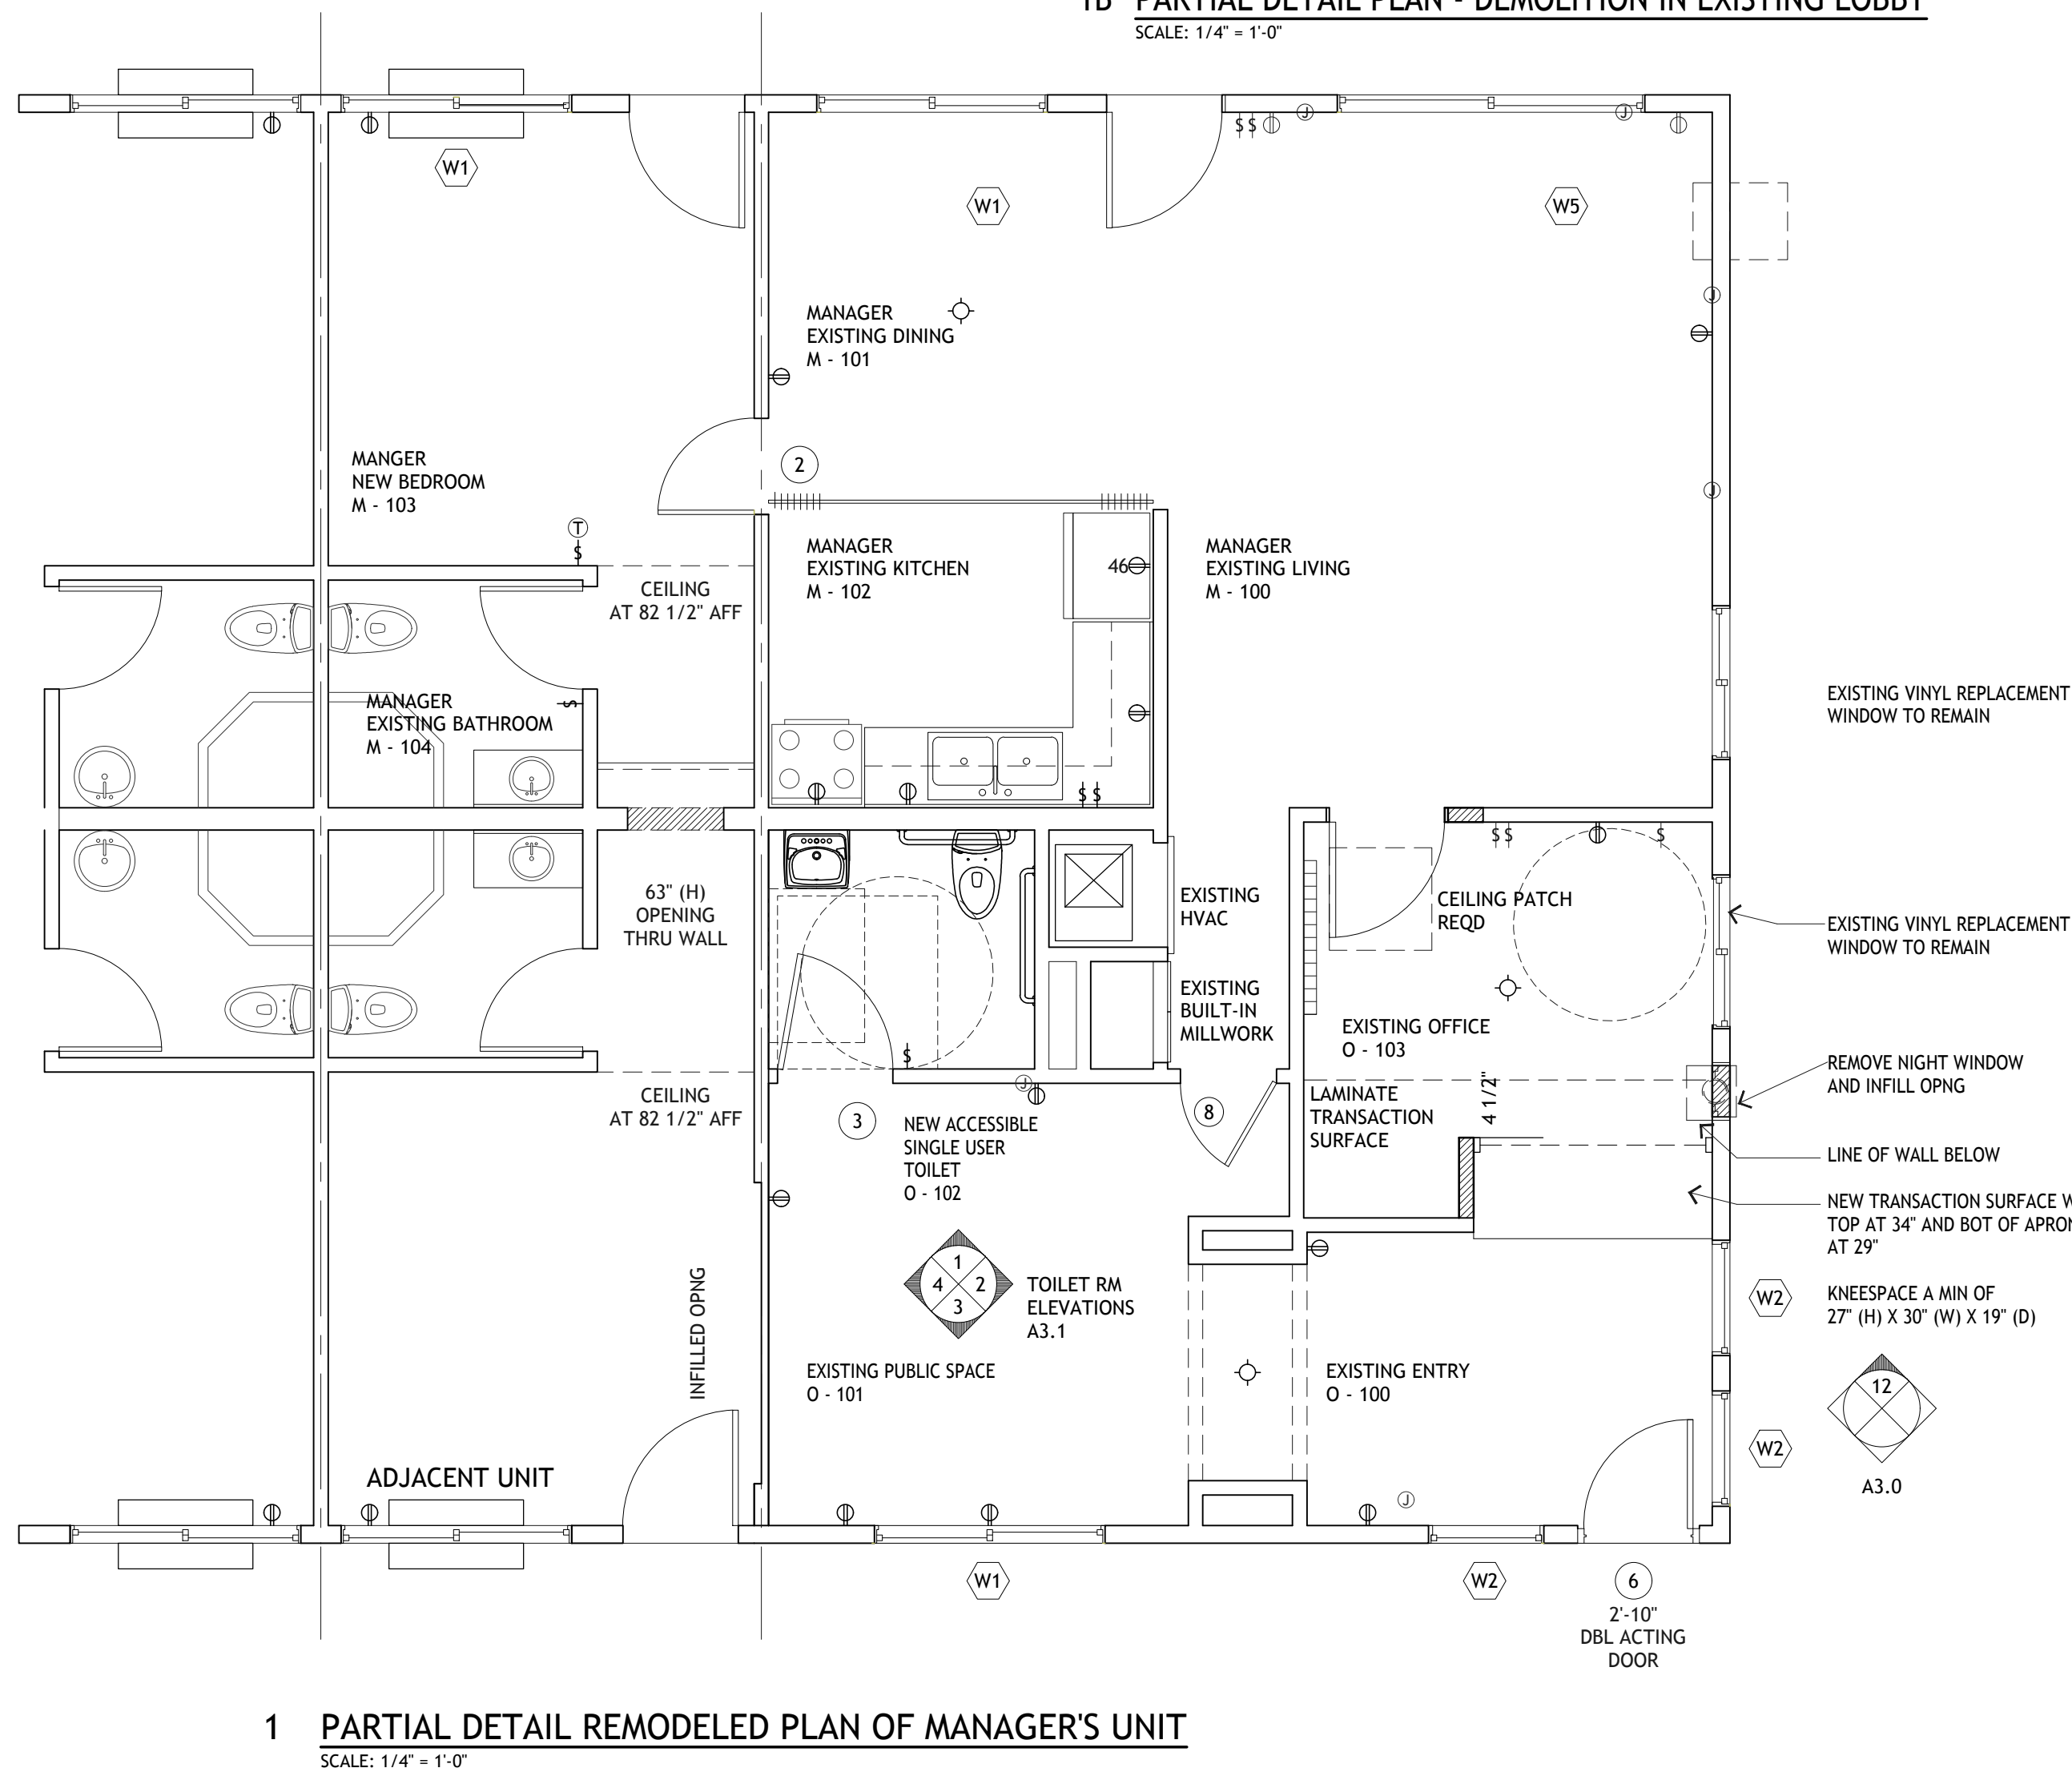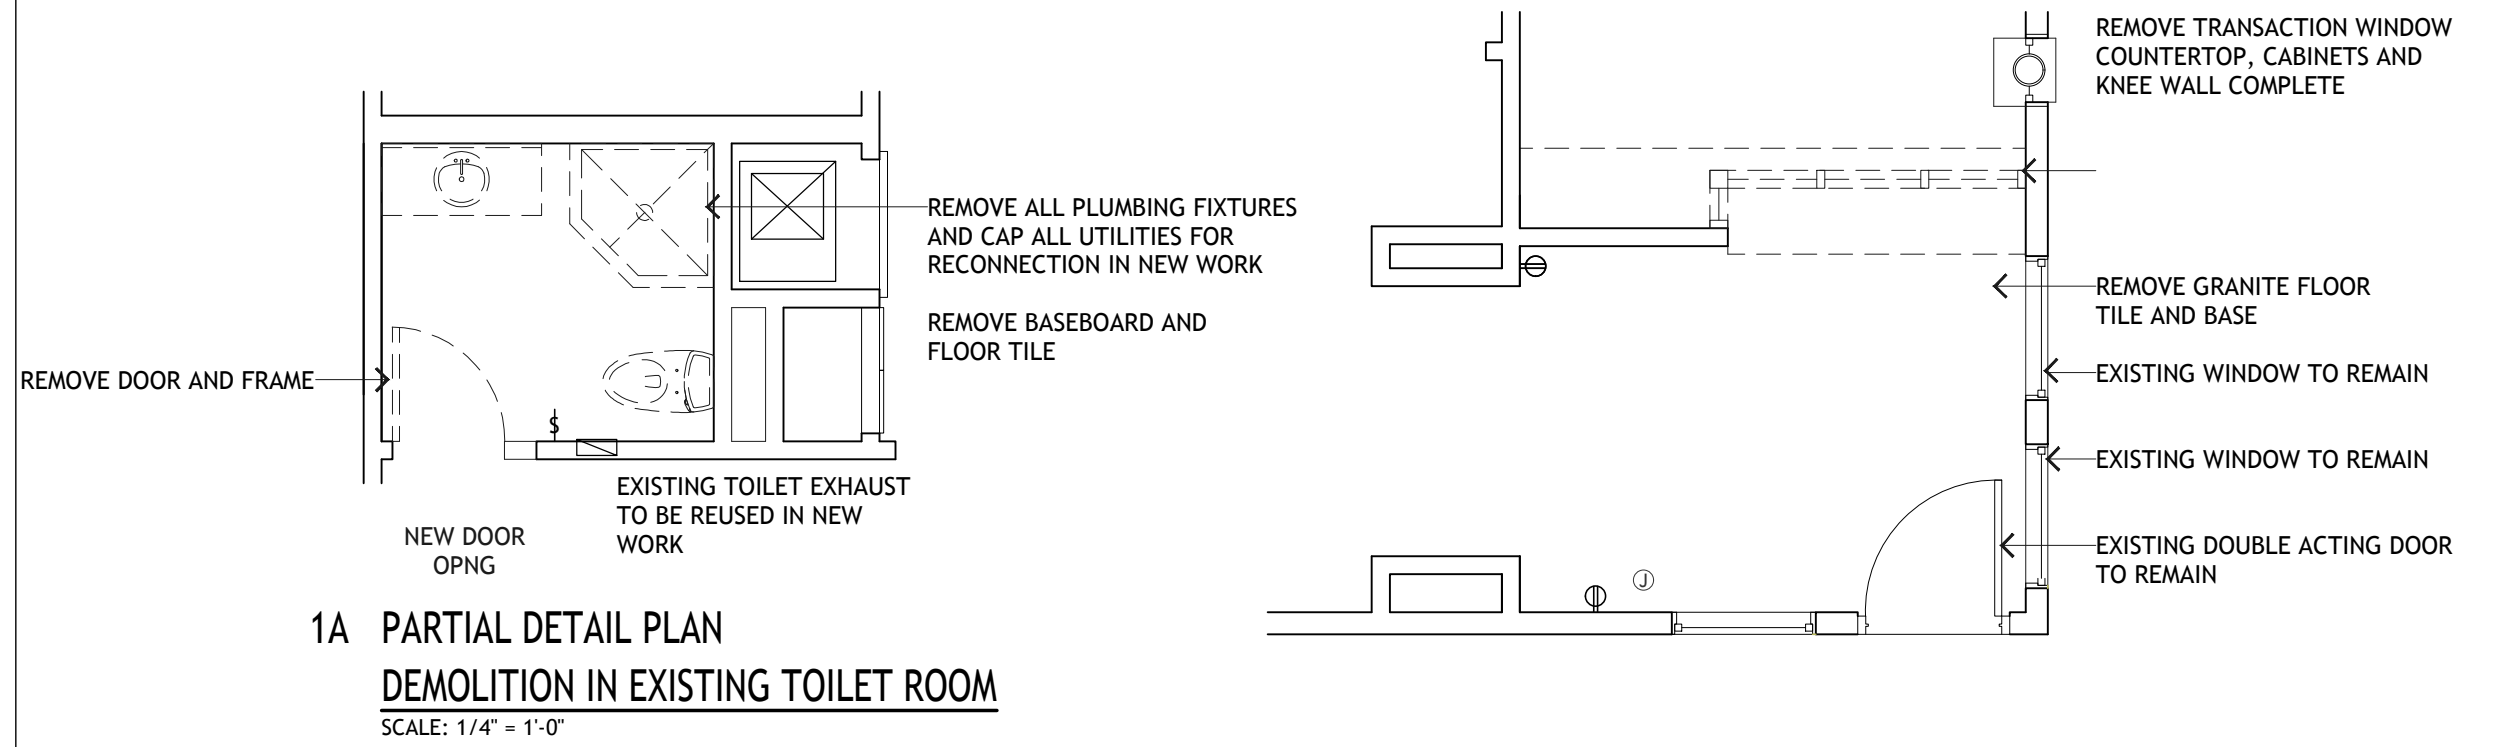2130 FOURTH ST
SAN RAFAEL, CA 94901
PHONE (415) 457-6035
FAX (415) 457-6036

P.O.BOX 150539
SAN RAFAEL, CA 94915

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SHEET TITLE:

DETAIL
PLANS

A1.5



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(QUEEN'S MOTEL)
RE-DEVELOPMENT


PROJECT LOCATION:

16959 STODDARD WELLS RI
VICTORVILLE, CA 92395

SHEET TITLE:


DETAIL
PLANS

A1.6

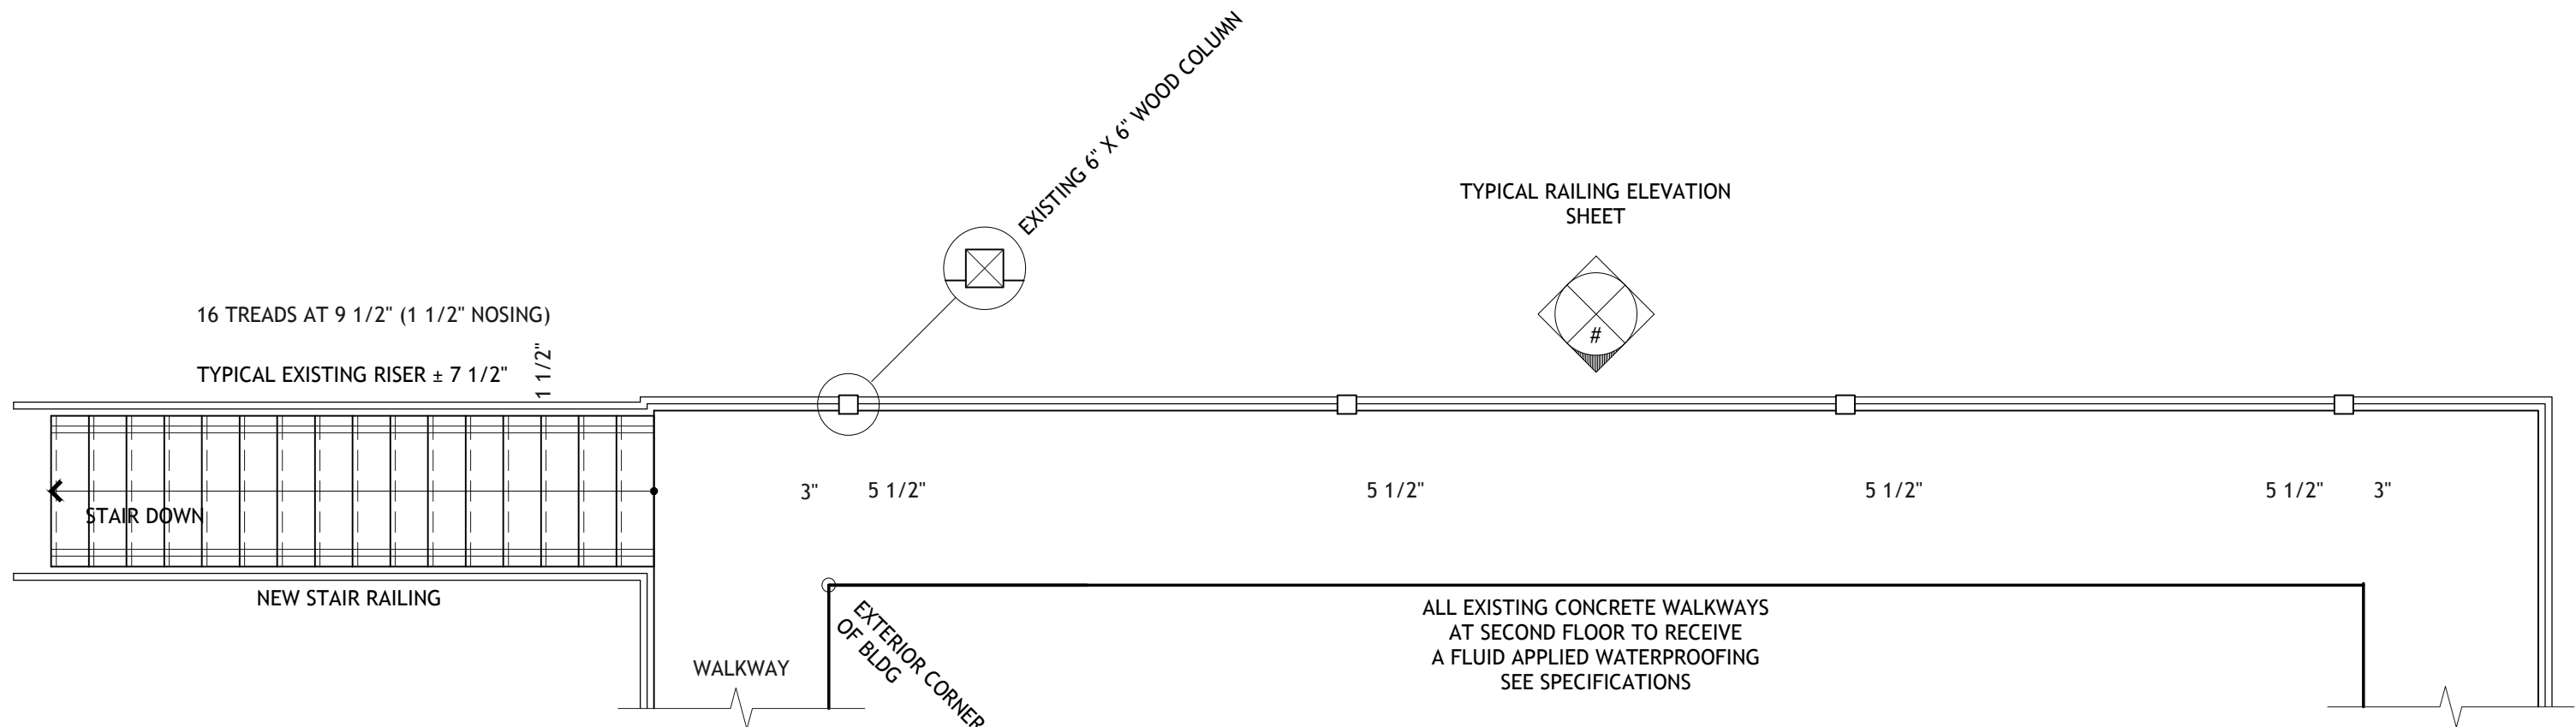


1 DETAIL PLAN OF STAIR AT SECOND FLOOR

SCALE: 1/4" = 1'-0"

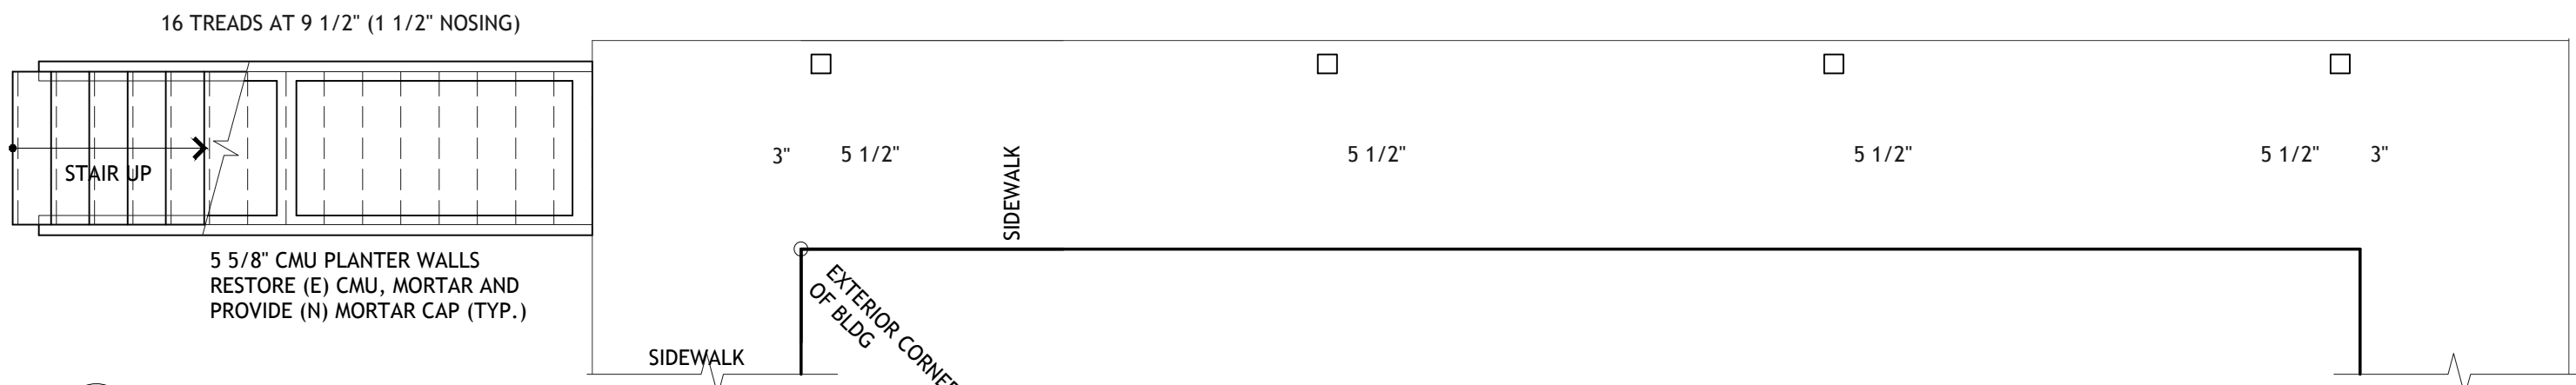


2 DETAIL PLAN OF STAIR AT GROUND FLOOR

SCALE: 1/4" = 1'-0"

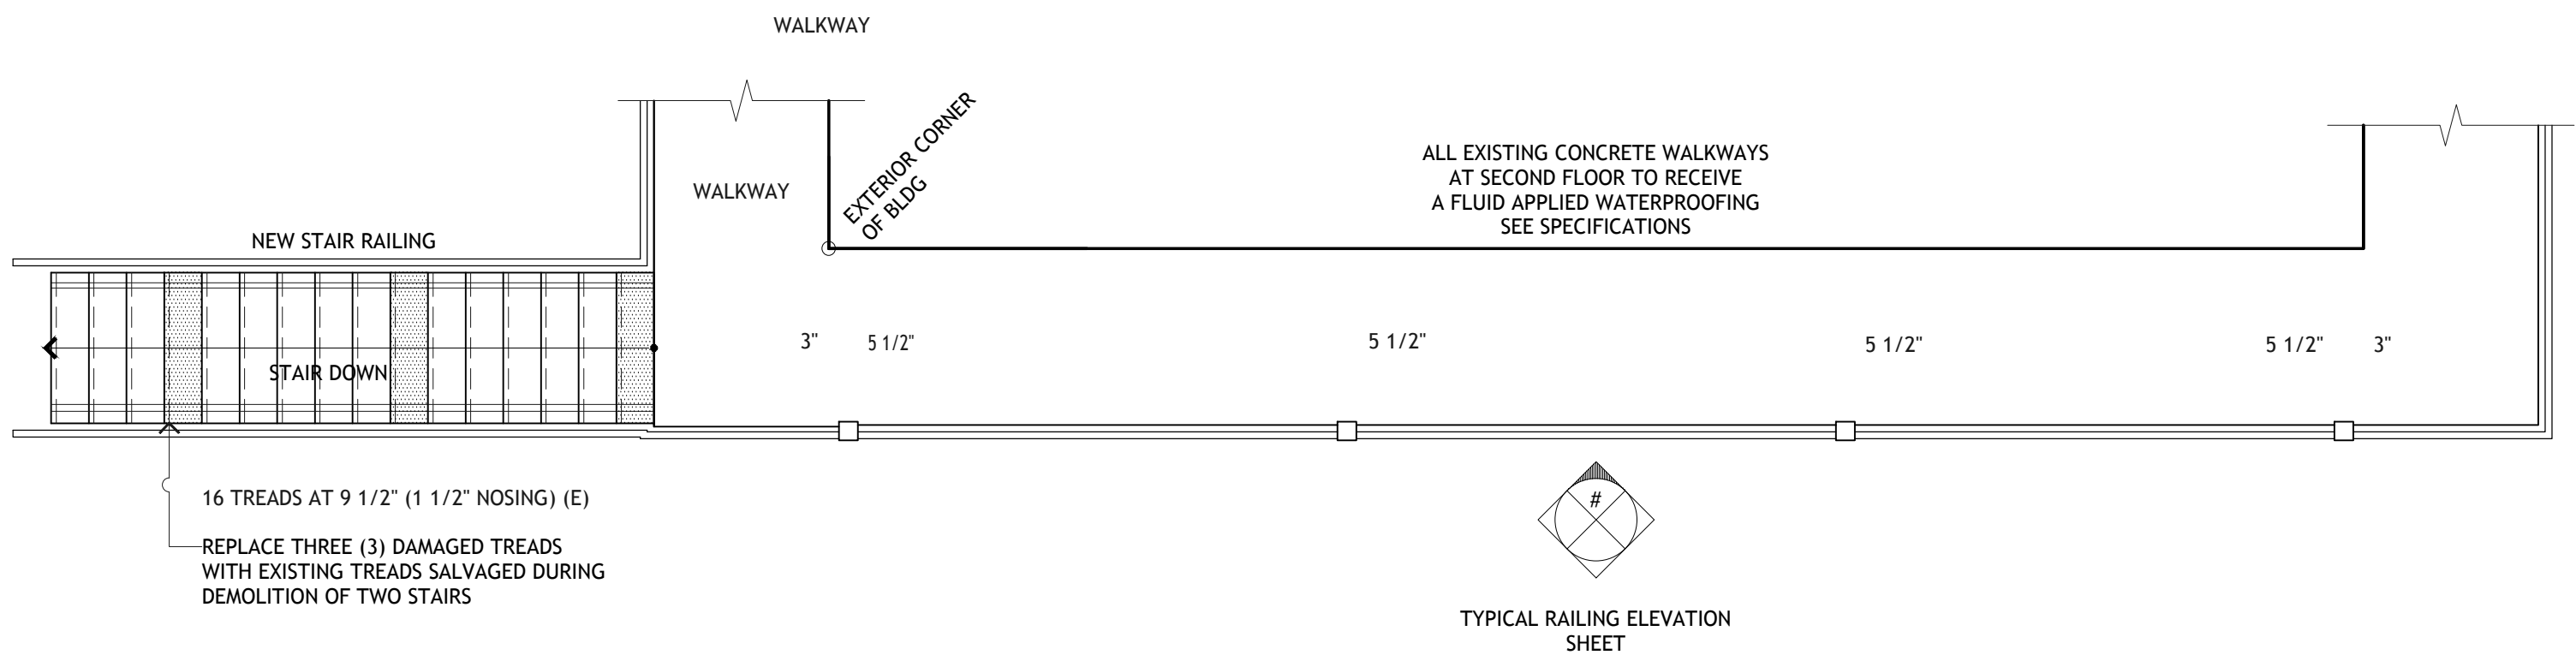


3 DETAIL PLAN OF STAIR AT SECOND FLOOR

SCALE: 1/4" = 1'-0"

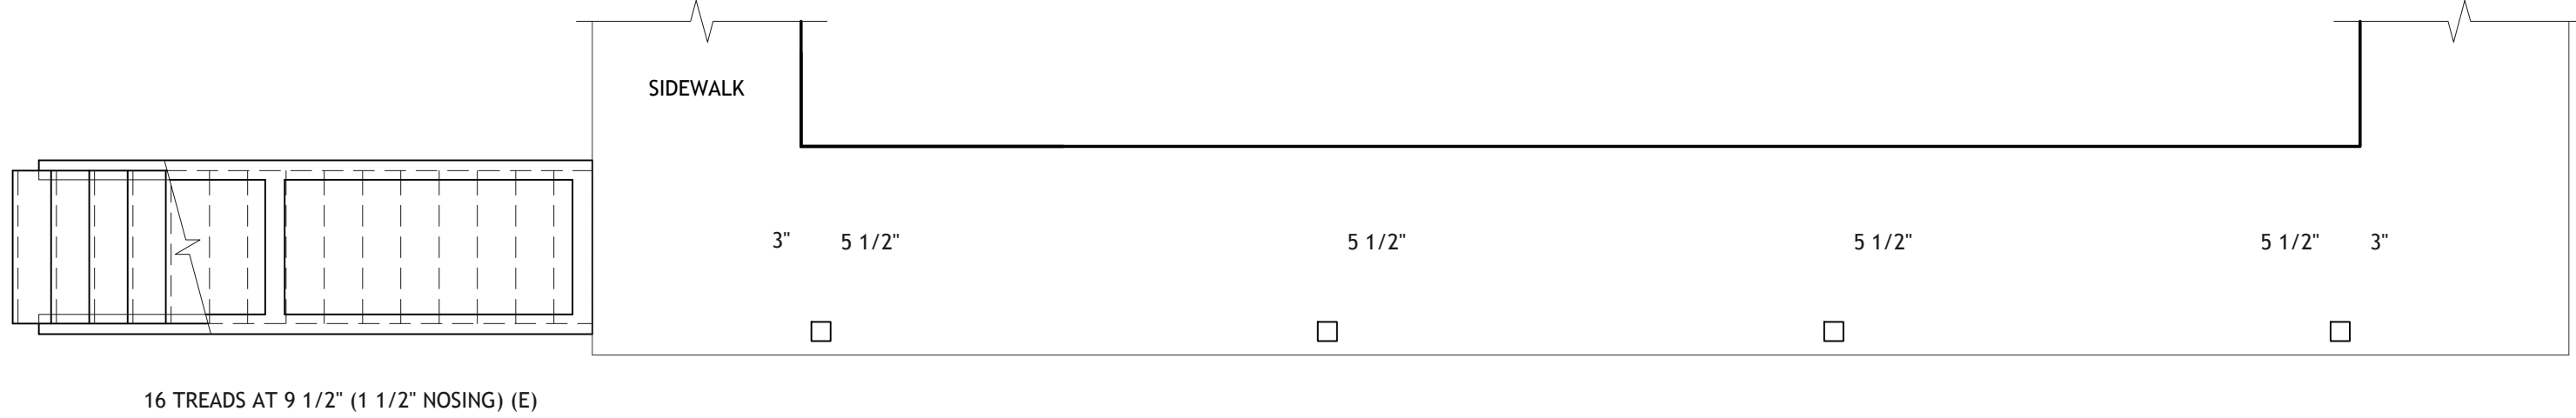


4 DETAIL PLAN OF STAIR AT GROUND FLOOR

SCALE: 1/4" = 1'-0"

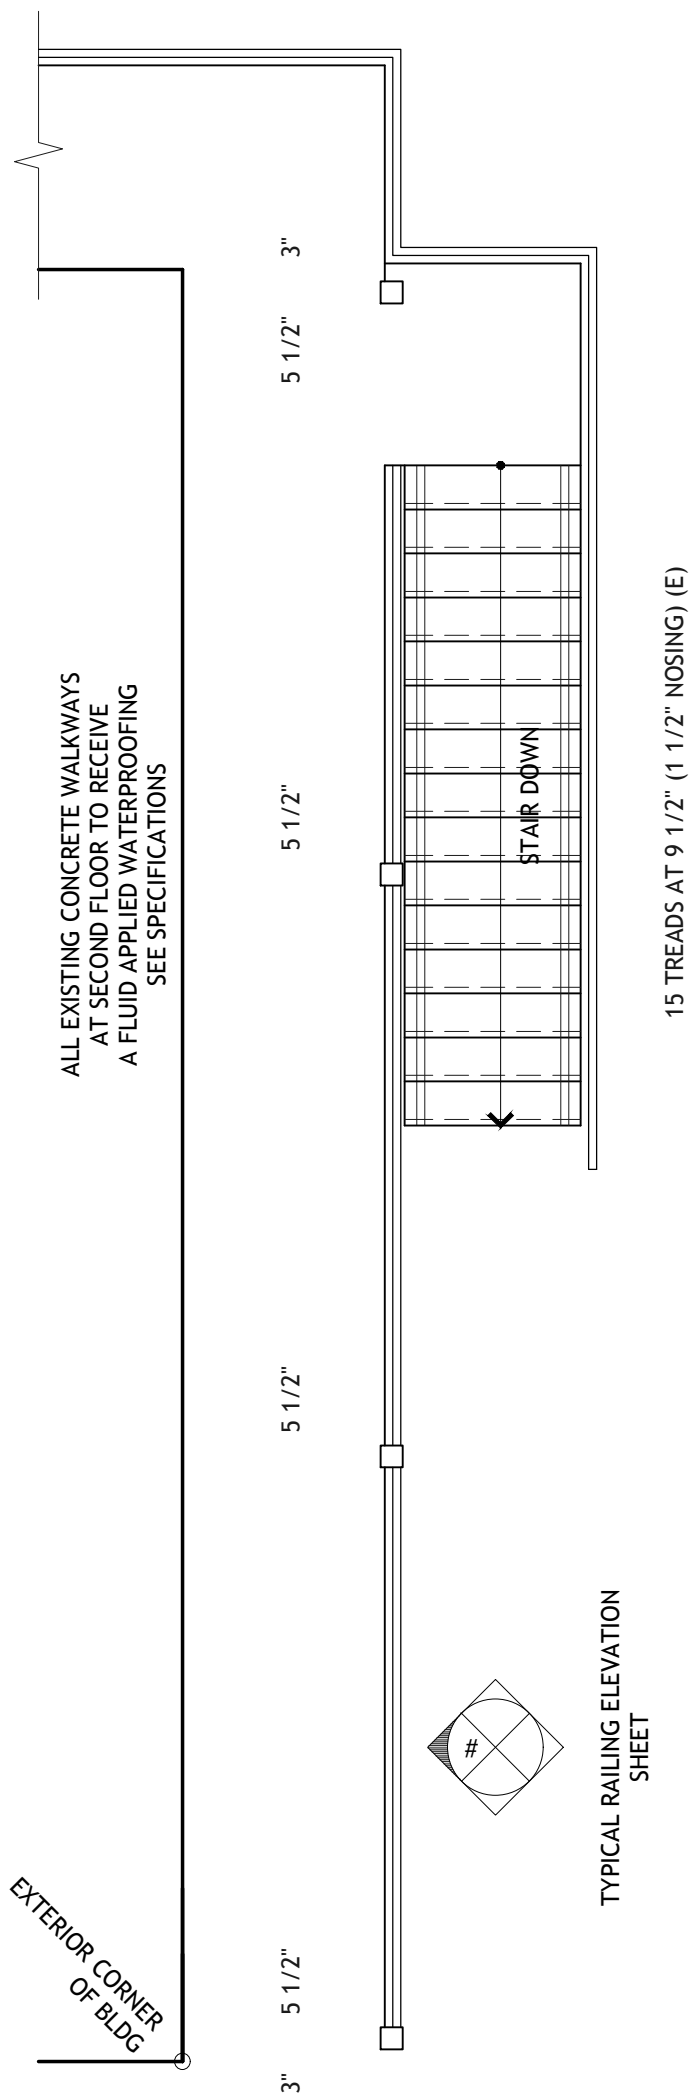


5 DETAIL PLAN OF STAIR AT SECOND FLOOR

SCALE: 1/4" = 1'-0"

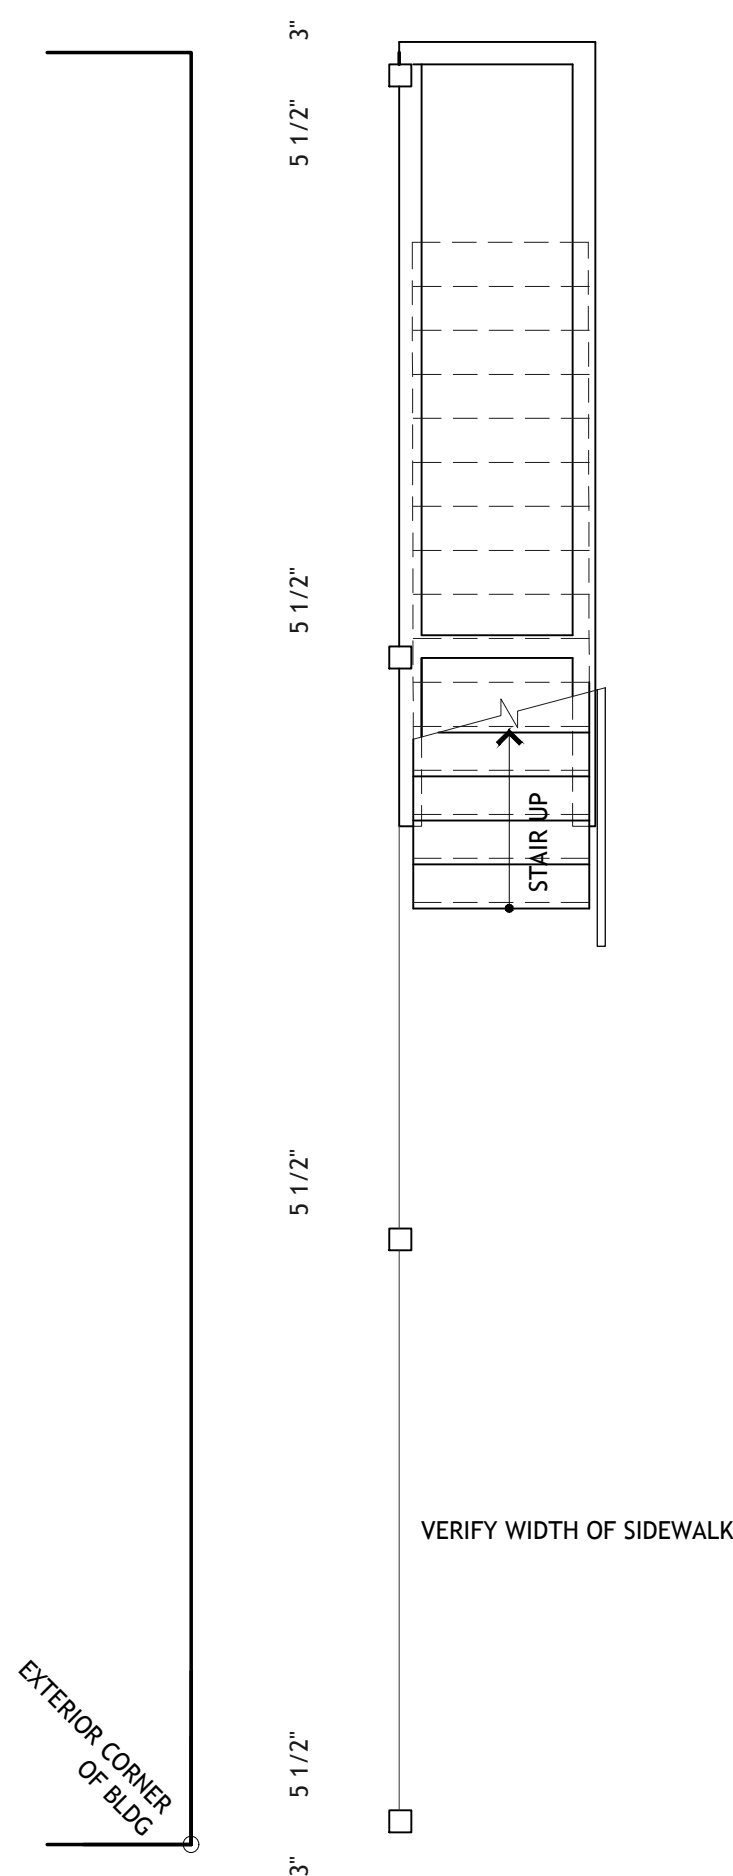


6 DETAIL PLAN OF STAIR GROUND FLOOR


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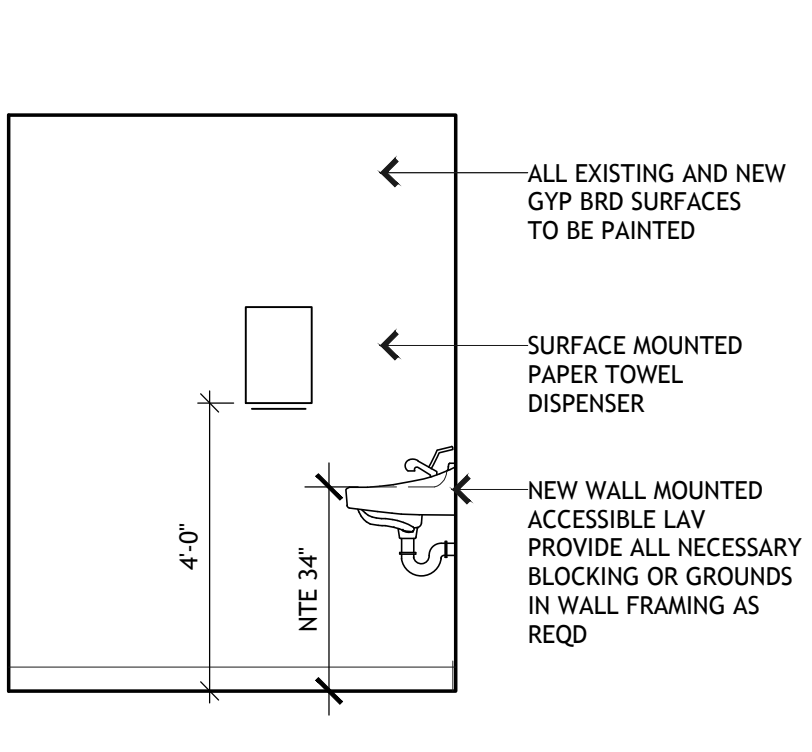
1 ACCESSIBLE OFFICE SINGLE USER TOILET
SCALE: 3/4" = 1'-0"

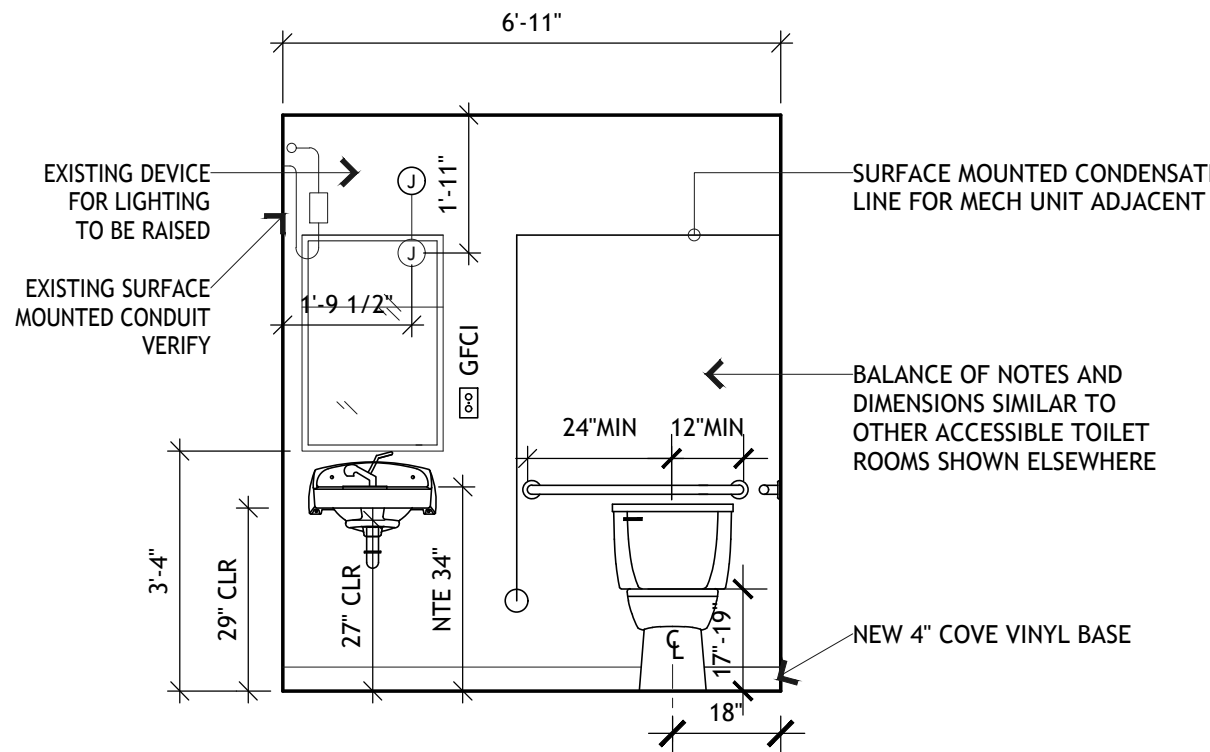


2 ACCESSIBLE OFFICE SINGLE USER TOILET
SCALE: 3/4" = 1'-0"

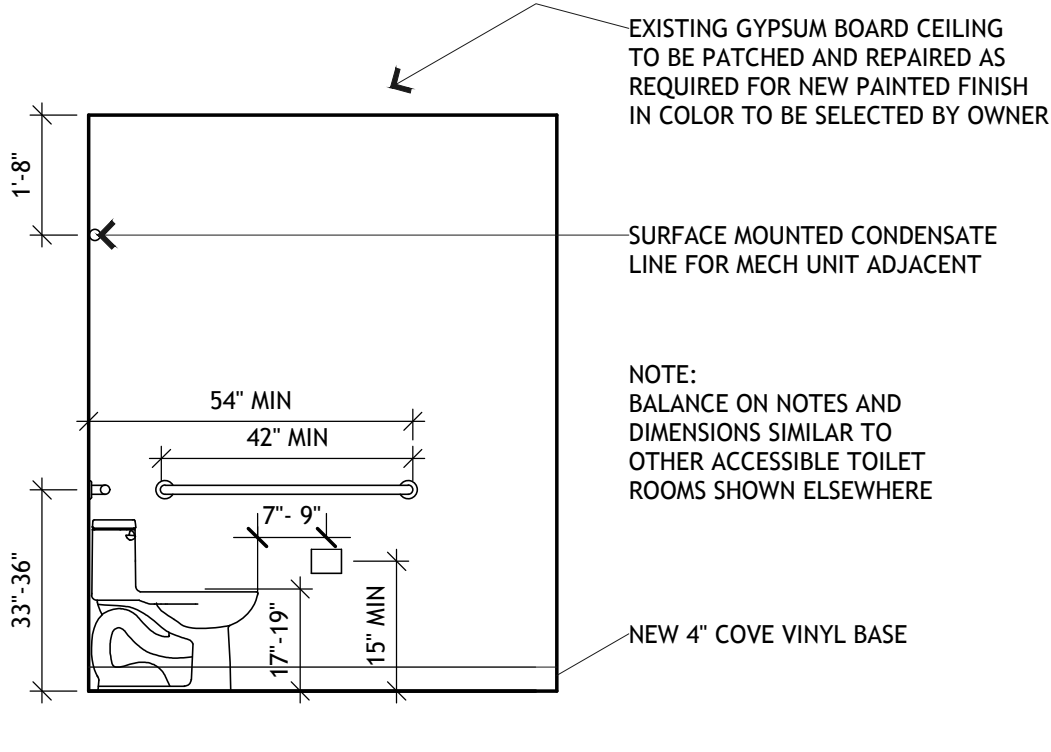


3 ACCESSIBLE OFFICE SINGLE USER TOILET
SCALE: 3/4" = 1'-0"

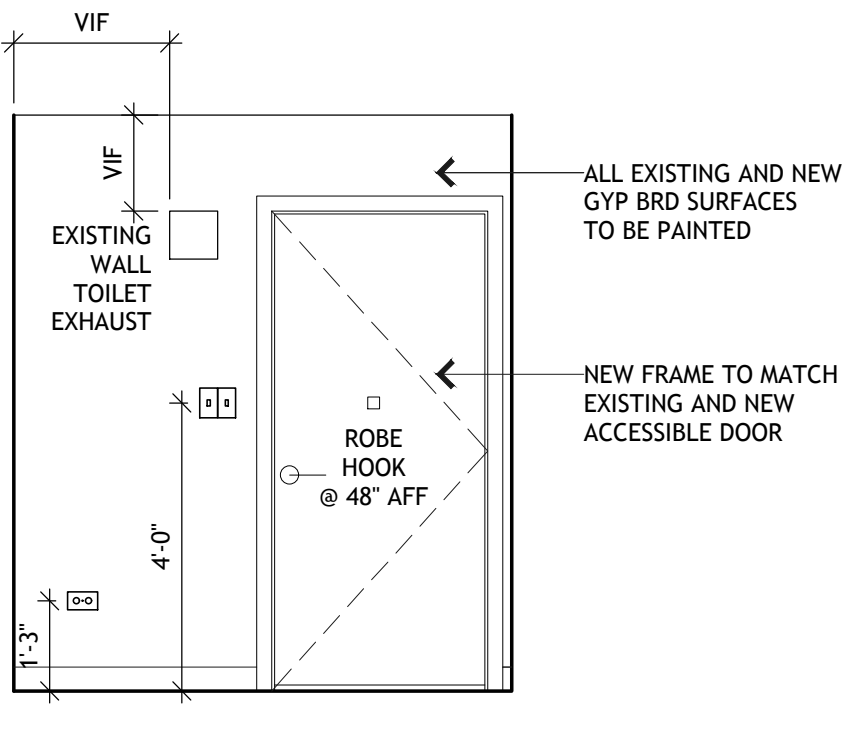


4 ACCESSIBLE OFFICE SINGLE USER TOILET
SCALE: 3/4" = 1'-0"

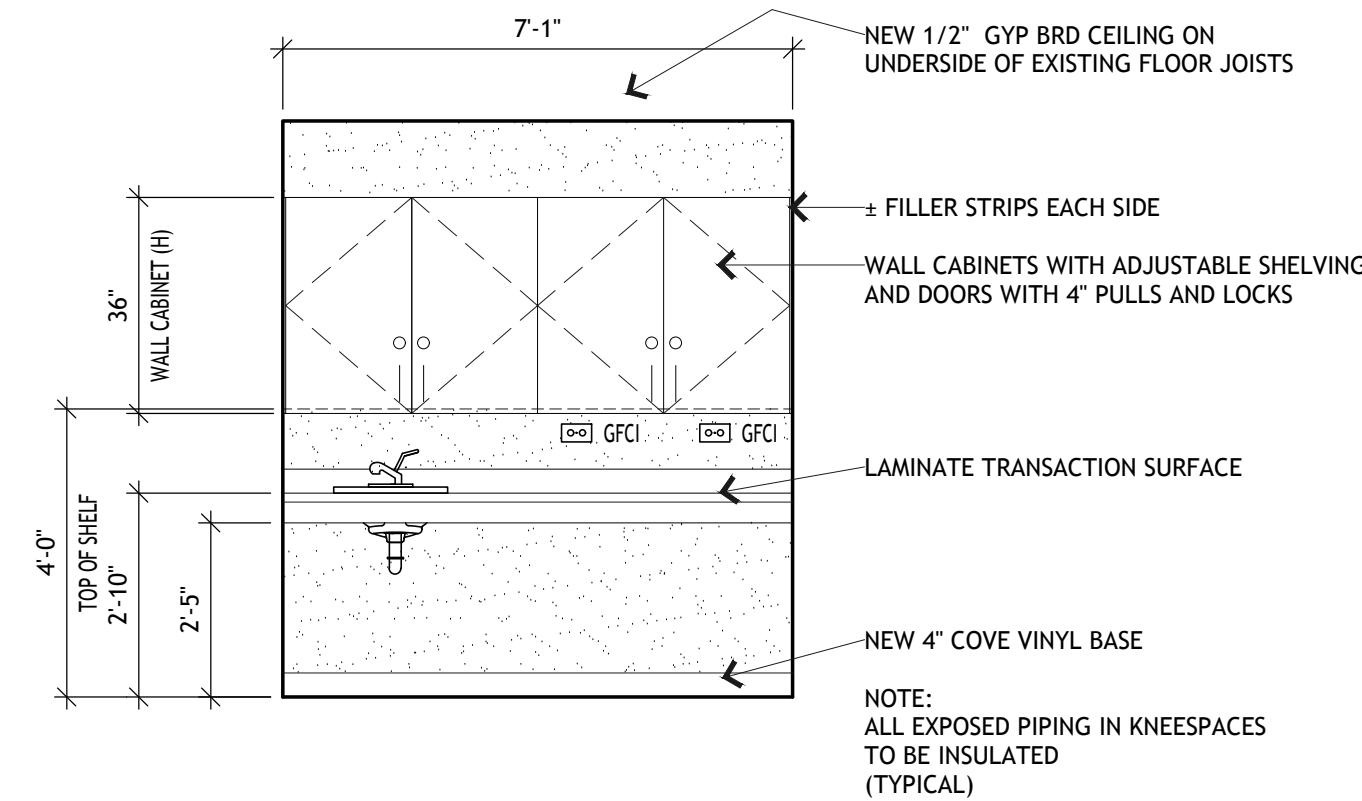


5 ACCESSIBLE COMMUNITY ROOM PANTRY
SCALE: 3/4" = 1'-0"

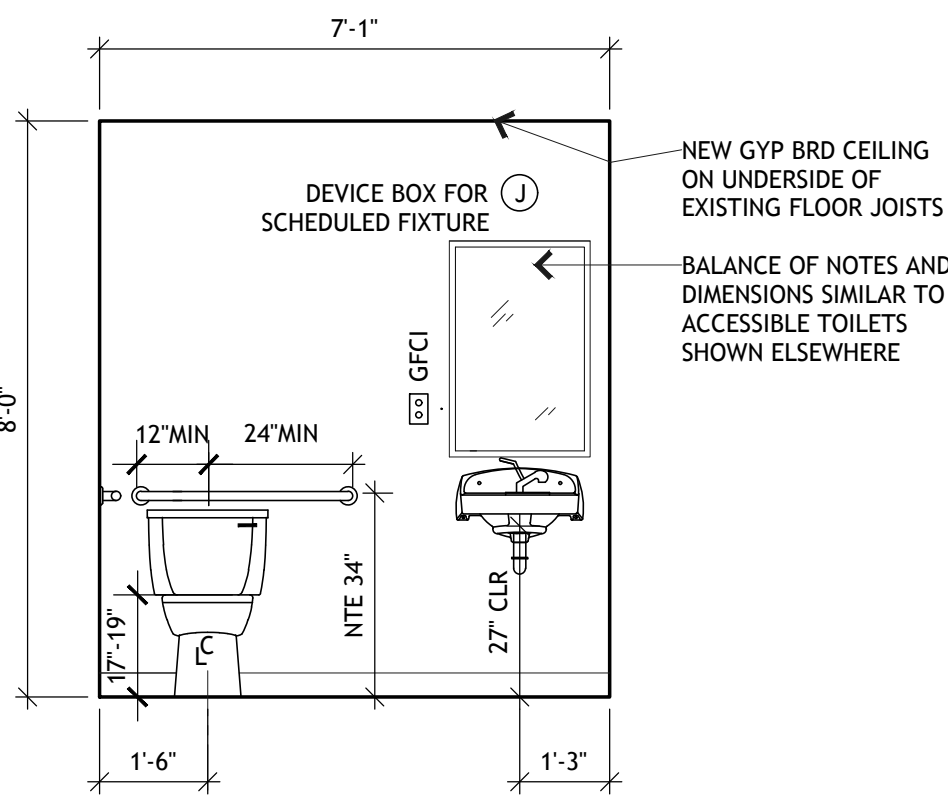


6 COMMUNITY RM ACCESSIBLE TOILET
SCALE: 3/4" = 1'-0"

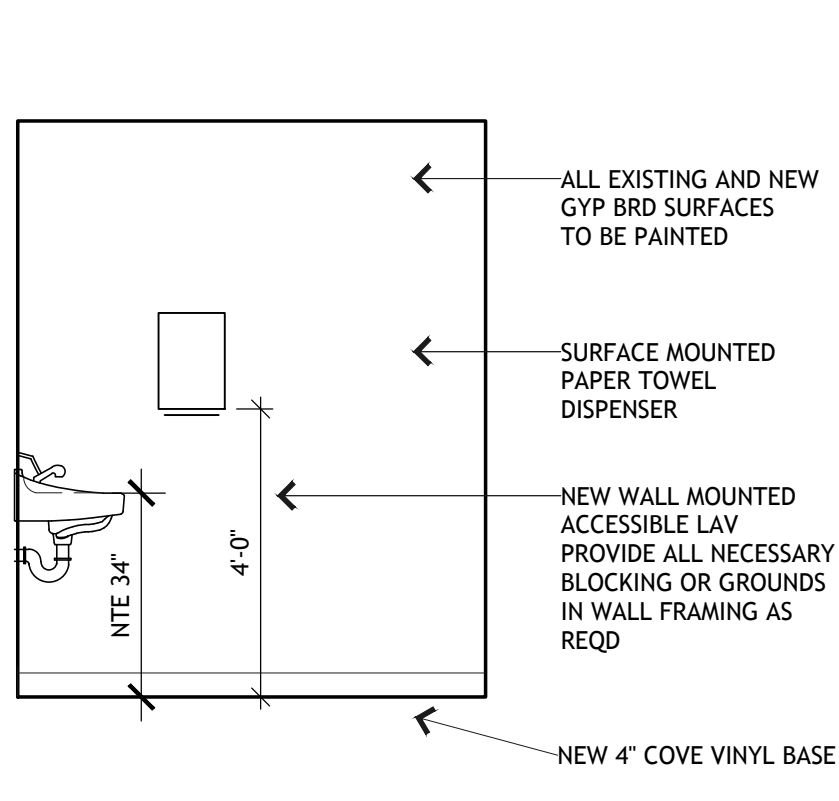


7 COMMUNITY RM ACCESSIBLE TOILET
SCALE: 3/4" = 1'-0"

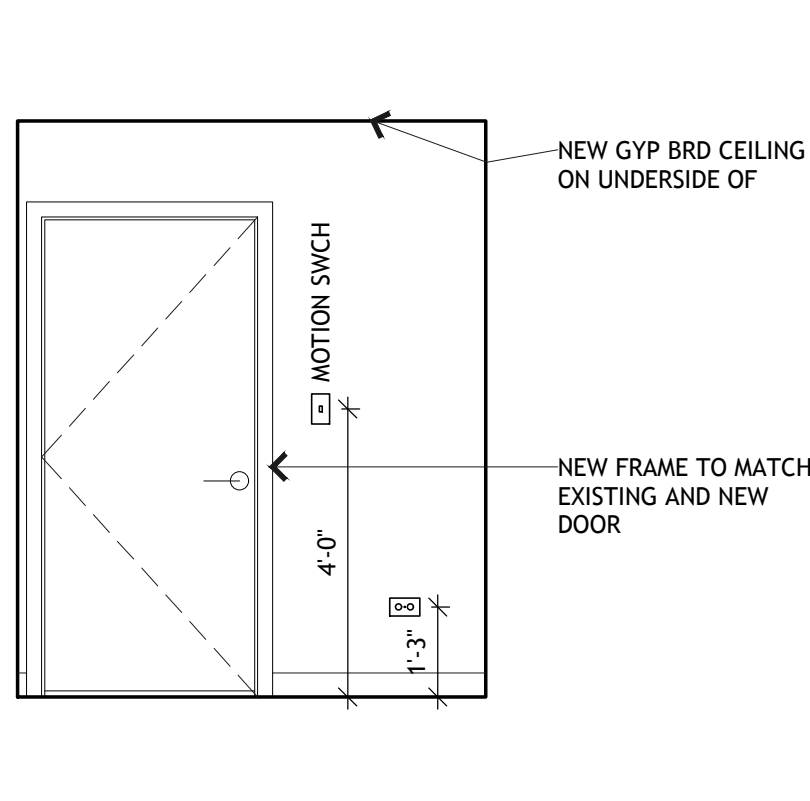


8 COMMUNITY RM ACCESSIBLE TOILET
SCALE: 3/4" = 1'-0"

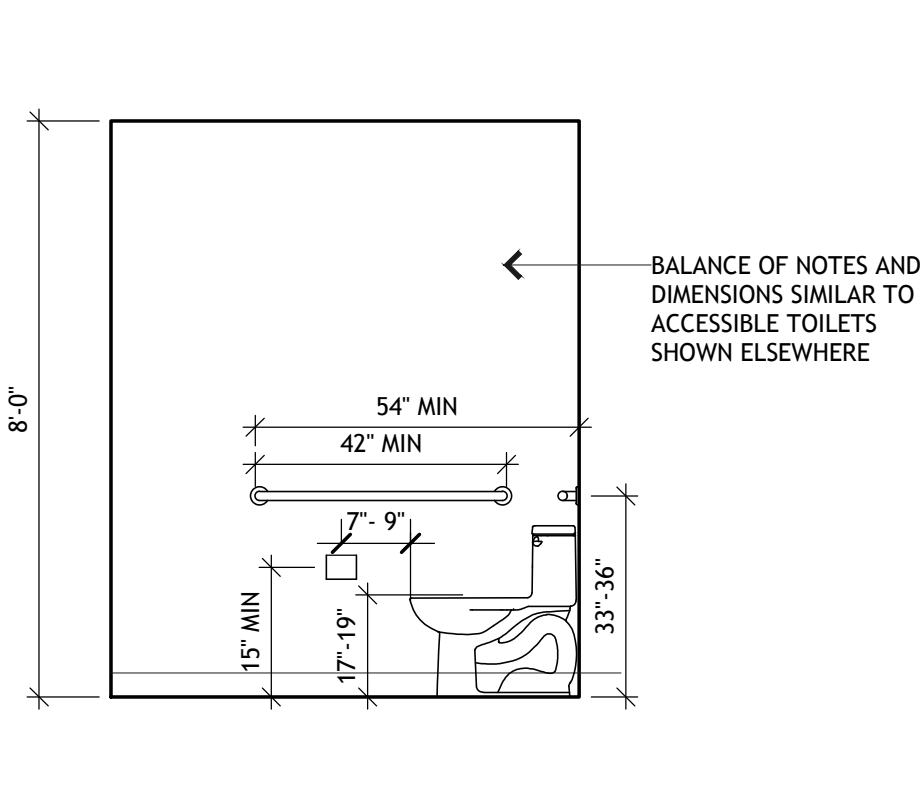


9 COMMUNITY RM ACCESSIBLE TOILET
SCALE: 3/4" = 1'-0"

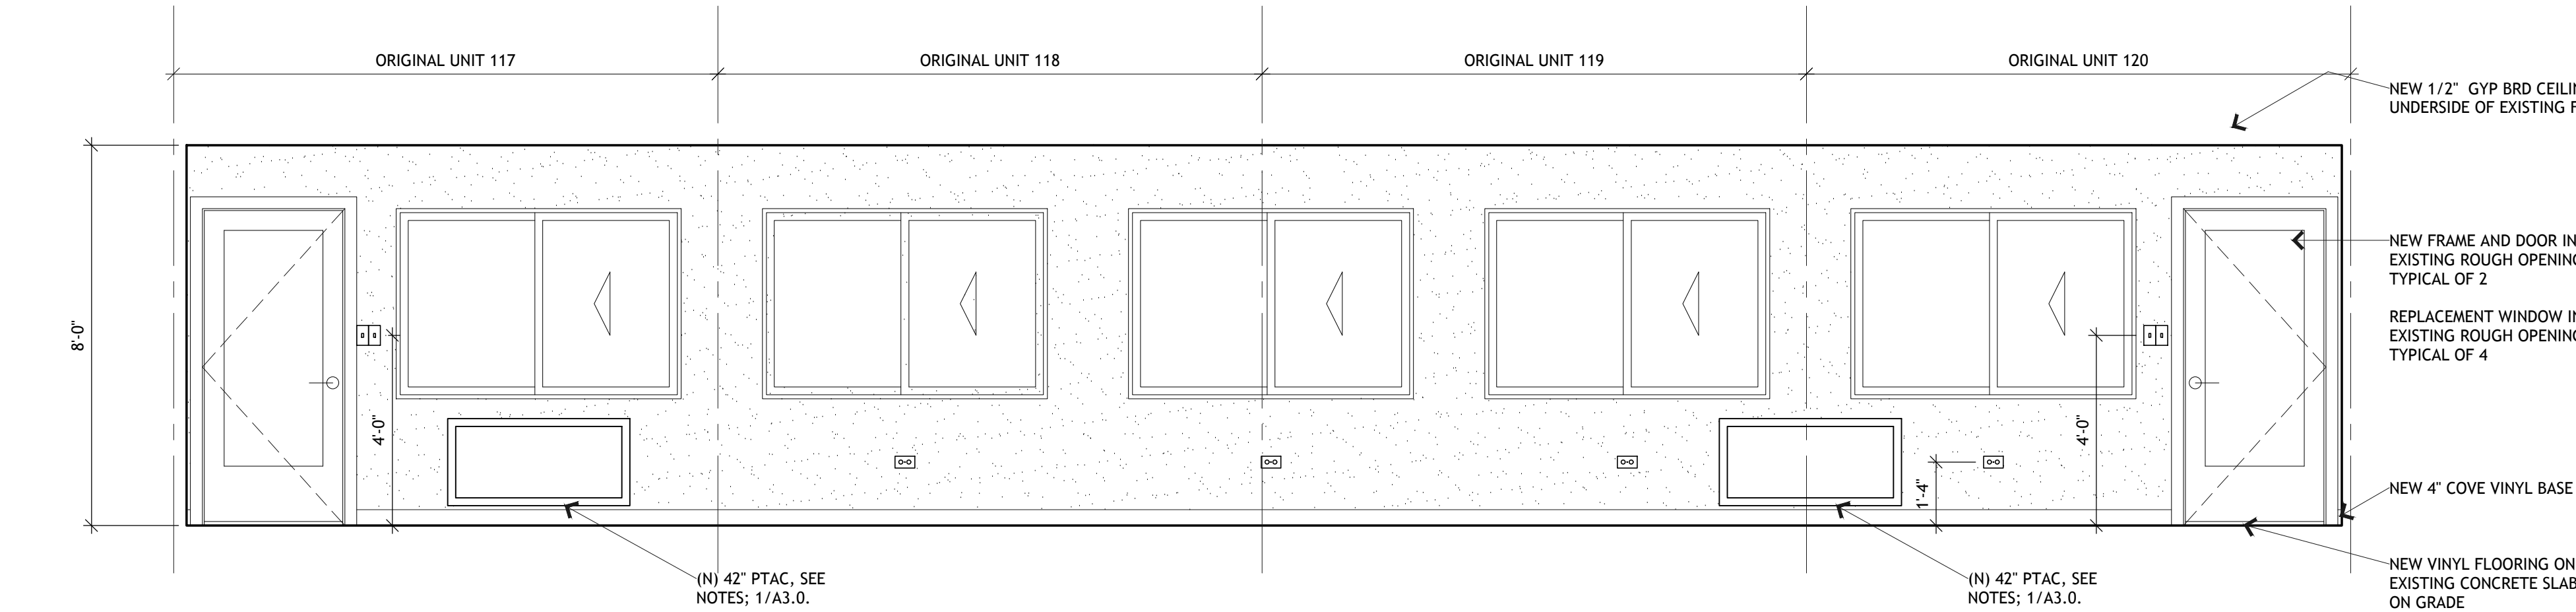


10 INTERIOR ELEVATION - COMMUNITY ROOM
SCALE: 3/4" = 1'-0"

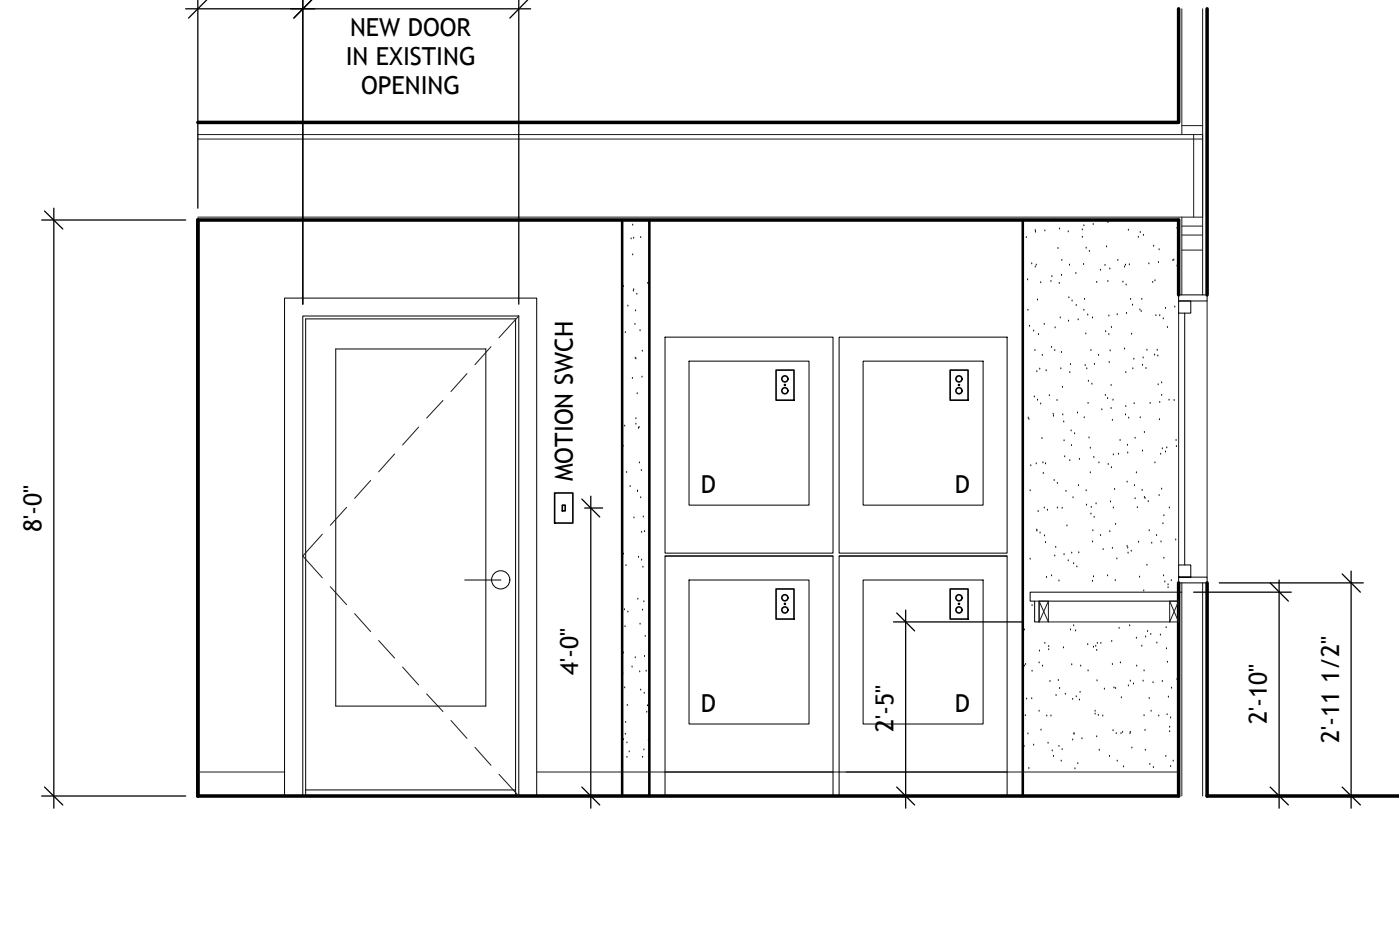

11 INTERIOR ELEVATION - COMMUNITY ROOM
SCALE: 3/4" = 1'-0"

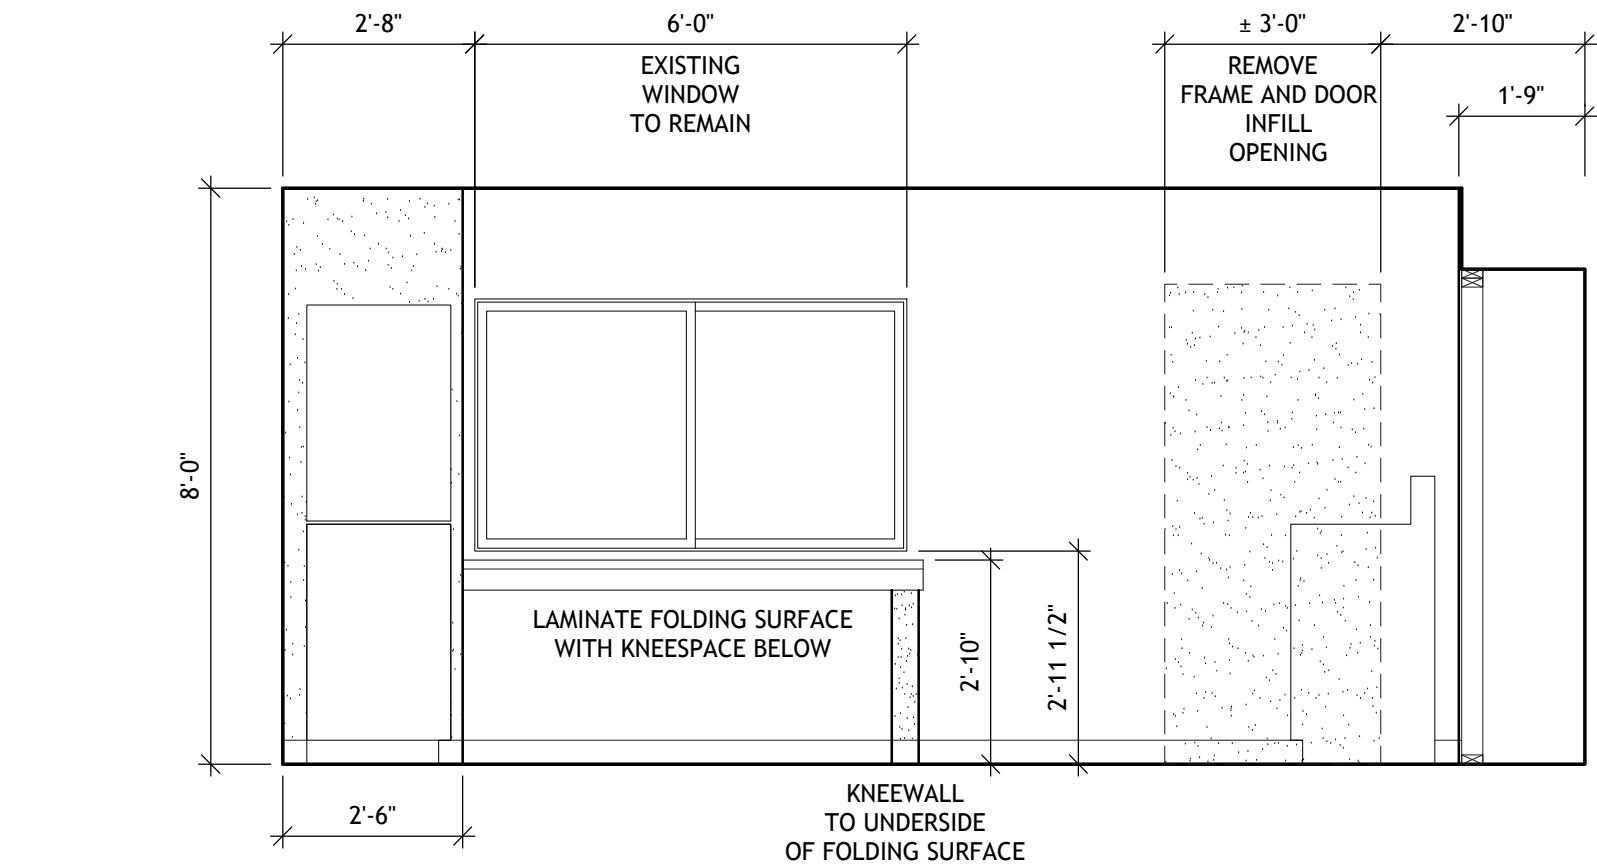

12 INTERIOR ELEVATION - REMODELED LAUNDRY
SCALE: 3/4" = 1'-0"

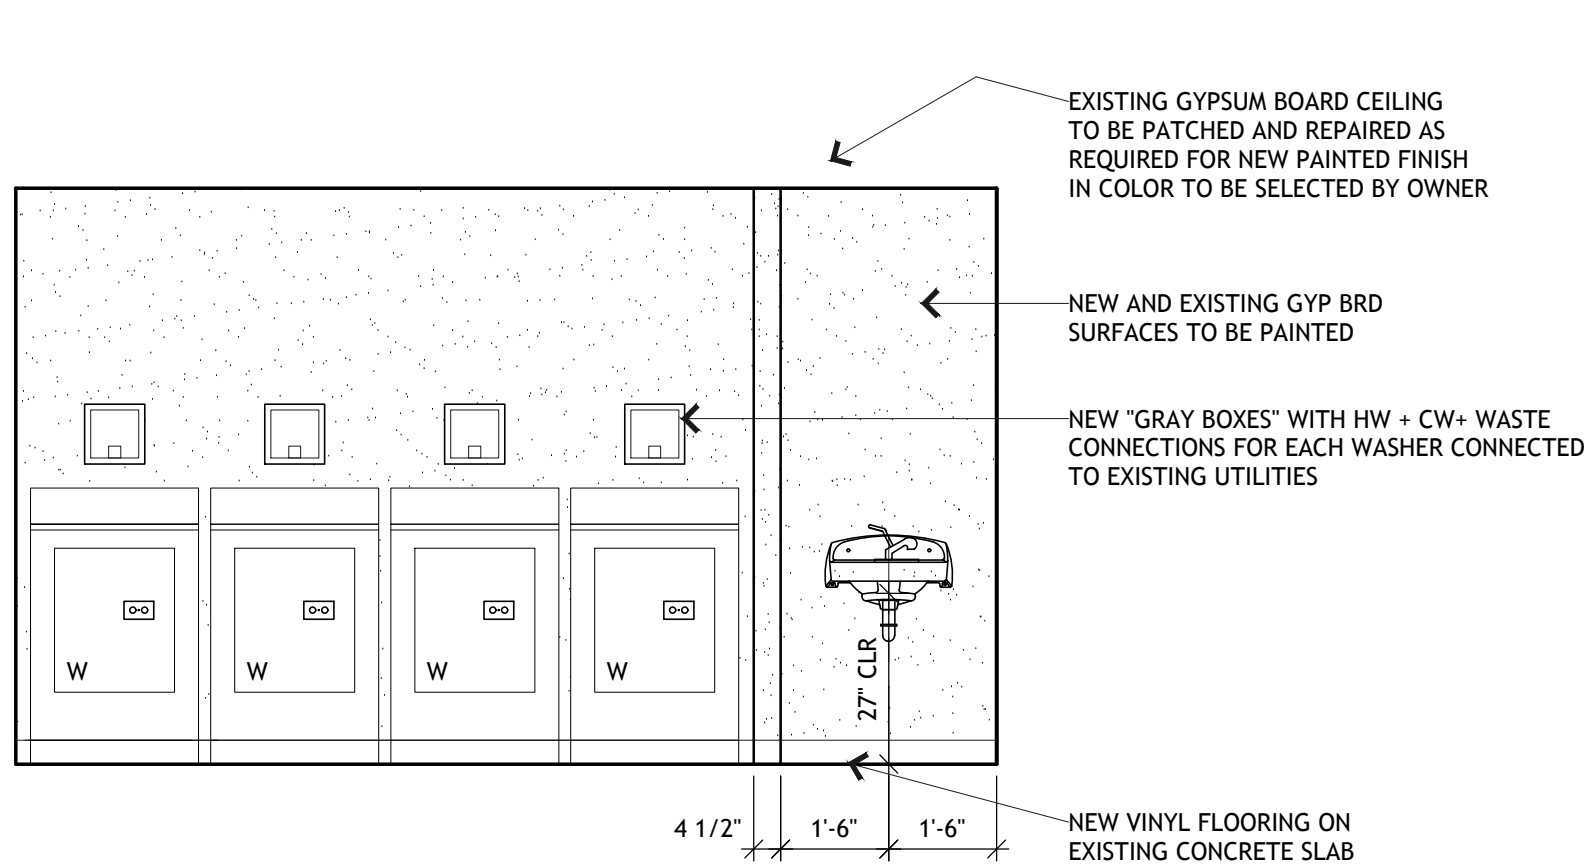

13 INTERIOR ELEVATION - REMODELED LAUNDRY
SCALE: 3/4" = 1'-0"



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SHEET TITLE:

INTERIOR
ELEVATIONS

A3.1



BUILDING EXTERIOR GENERAL NOTES

- 1 STUCCO REPAIRS: ROUTE HAIRLINE CRACKS LESS THAN 1/8", FULLY SEAL, SAND FINISH TO MATCH EXISTING STUCCO. SEAL ALL.
- 2 SEAL ALL PENETRATIONS FOR PESTS AND RODENTS.
- 3 SEAL AND PAINT: APPLY WATERPROOFING CAULKING AT ALL JOINTS AND MATERIAL PENETRATIONS. PROPERLY PREPARED, PRIME, AND PAINT ALL WOOD ELEMENTS, TRIMS, SOFFITS, AND BARGE BOARDS.
- 4 EXTERIOR PAINT/ WATERPROOFING: APPLY NEW ACRYLIC TEXTURED TOPCOAT TO STUCCO AT WALLS. REMOVE EXISTING EXTERIOR CALKING AND REPLACE WITH NEW POLYURETHANE FOR WATERPROOFING INTEGRITY. UPON COMPLETION, PAINT ALL STUCCO SURFACES.
- 5 REPLACE ALL WINDOWS AT EXISTING ROUGH OPENINGS. COMPLY WITH EGRESS STANDARDS.
- 6 FASCIA REPAIR: INSPECT AND REPLACE/ DRY-ROTTED OR DAMAGED FASCIA THROUGHOUT. VERIFY CONDITIONS FOR DRY ROT, REPAIR AS NEEDED.
- 7 ROOF DRAINAGE: REPLACE ALL GUTTERS WITH FULL DEPTH FASCIA TYPE. REPLACE DOWNSPOUTS.
- 8 EXTERIOR KITCHEN AND BATH EXHAUST VENT HOODS: INTEGRATE WITH ROOFING REPLACEMENT.
- 9 BUILDING-MOUNTING LIGHTING: REPLACE ALL EXTERIOR LIGHTING WITH HIGH-EFFICIENCY TYPE.
- 10 CHECK ALL SOFFIT VENTS FOR AIRFLOW. BEAD BLAST OR OTHERWISE REMOVE PAINT WHERE IMPROPERLY APPLIED OVER VENT HOLES, PREVENTING PROPER OPERATION.
- 11 (N) RAILING
- 12 EXPAND (E) PTAC OPENING AND PROVIDE (N) 42" SLEEVE. SEE 10/A5.0.
- 13 LOCATIONS OF STUCCO INFILL @ EX-PTAC LOCATIONS NOT SHOWN.

GENERAL NOTES FOR GUARDS AND RAILINGS

- 1 THE DETAILS SHOWN ARE INTENDED TO BE REPRESENTATIVE OF THE TYPICAL CONDITIONS FOR THE GUARDS AND RAILINGS, BUT DO NOT NECESSARILY DEPICT ALL CONDITIONS WITH RESPECT TO VARIATIONS IN THE EXISTING STAIRS TO BE REUSED IN THE NEW WORK.
 - 2 THE CONTRACTOR OR HIS SUB CONTRACTOR SHALL BE RESPONSIBLE FOR FIELD VERIFYING THE EXISTING DIMENSIONS AND CONDITIONS AT EACH BUILDING, AND SHALL ACCOUNT FOR THESE DIMENSIONS AND CONDITIONS IN THE SHOP DRAWINGS REQUIRED FOR THE GUARDS AND RAILINGS.
 - 3 THE CONTRACTOR IS SOLELY RESPONSIBLE FOR THE MEANS AND METHODS OF THE NEW WORK.
- CONDITIONS FOR THE MEANS AND METHODS THAT MIGHT DIFFER FROM THE DETAILS SHOWN SHALL BE ACCOUNTED FOR IN THE SHOP DRAWING SUBMITTAL, INCLUDING BUT NOT LIMITED TO STRUCTURAL CALCULATIONS DEMONSTRATING COMPLIANCE WITH THE APPLICABLE CODES AS REFERENCED IN DETAIL ON SHEET A1.2, AND AS DUPLICATED HEREAFTER:

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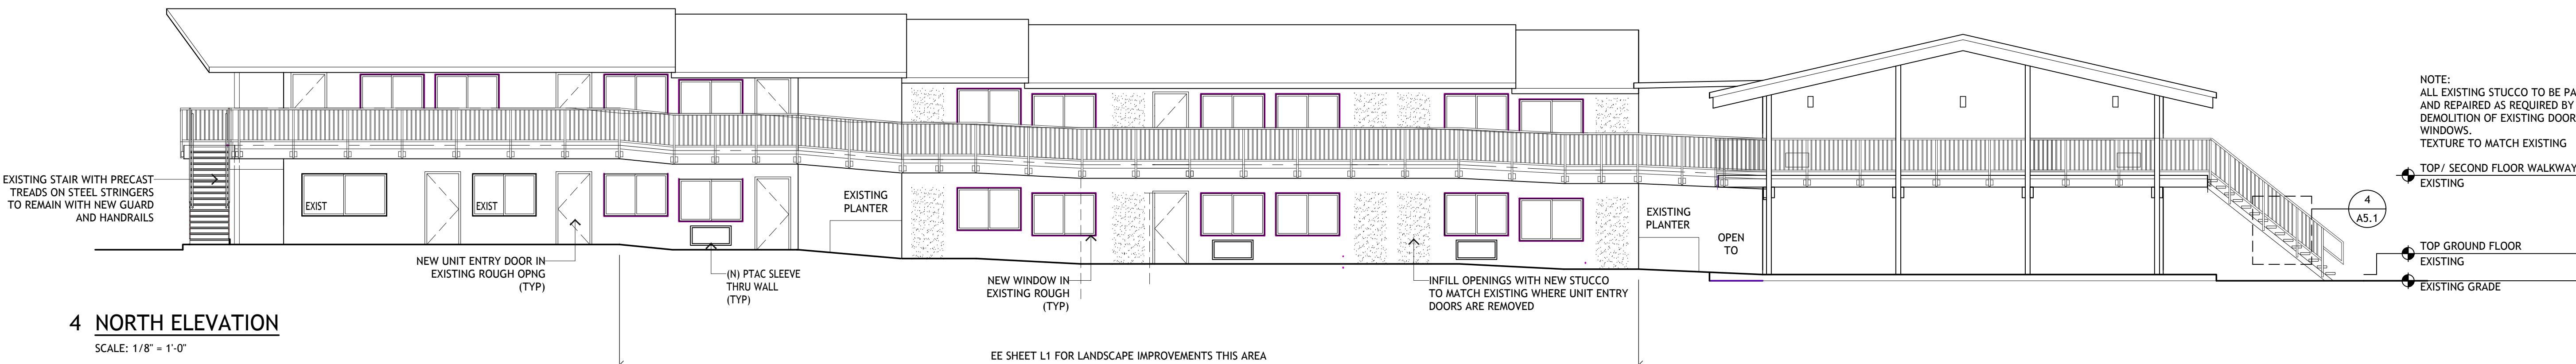
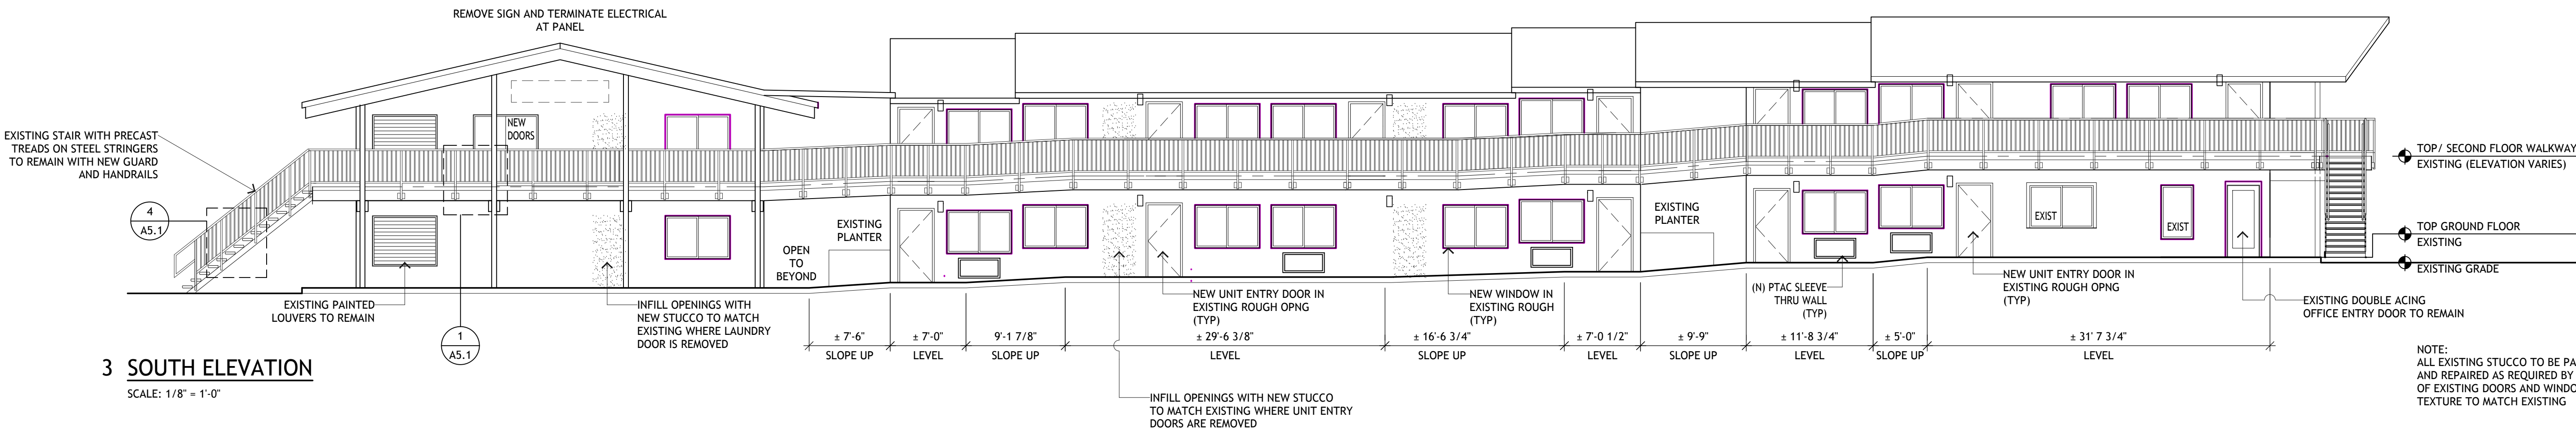
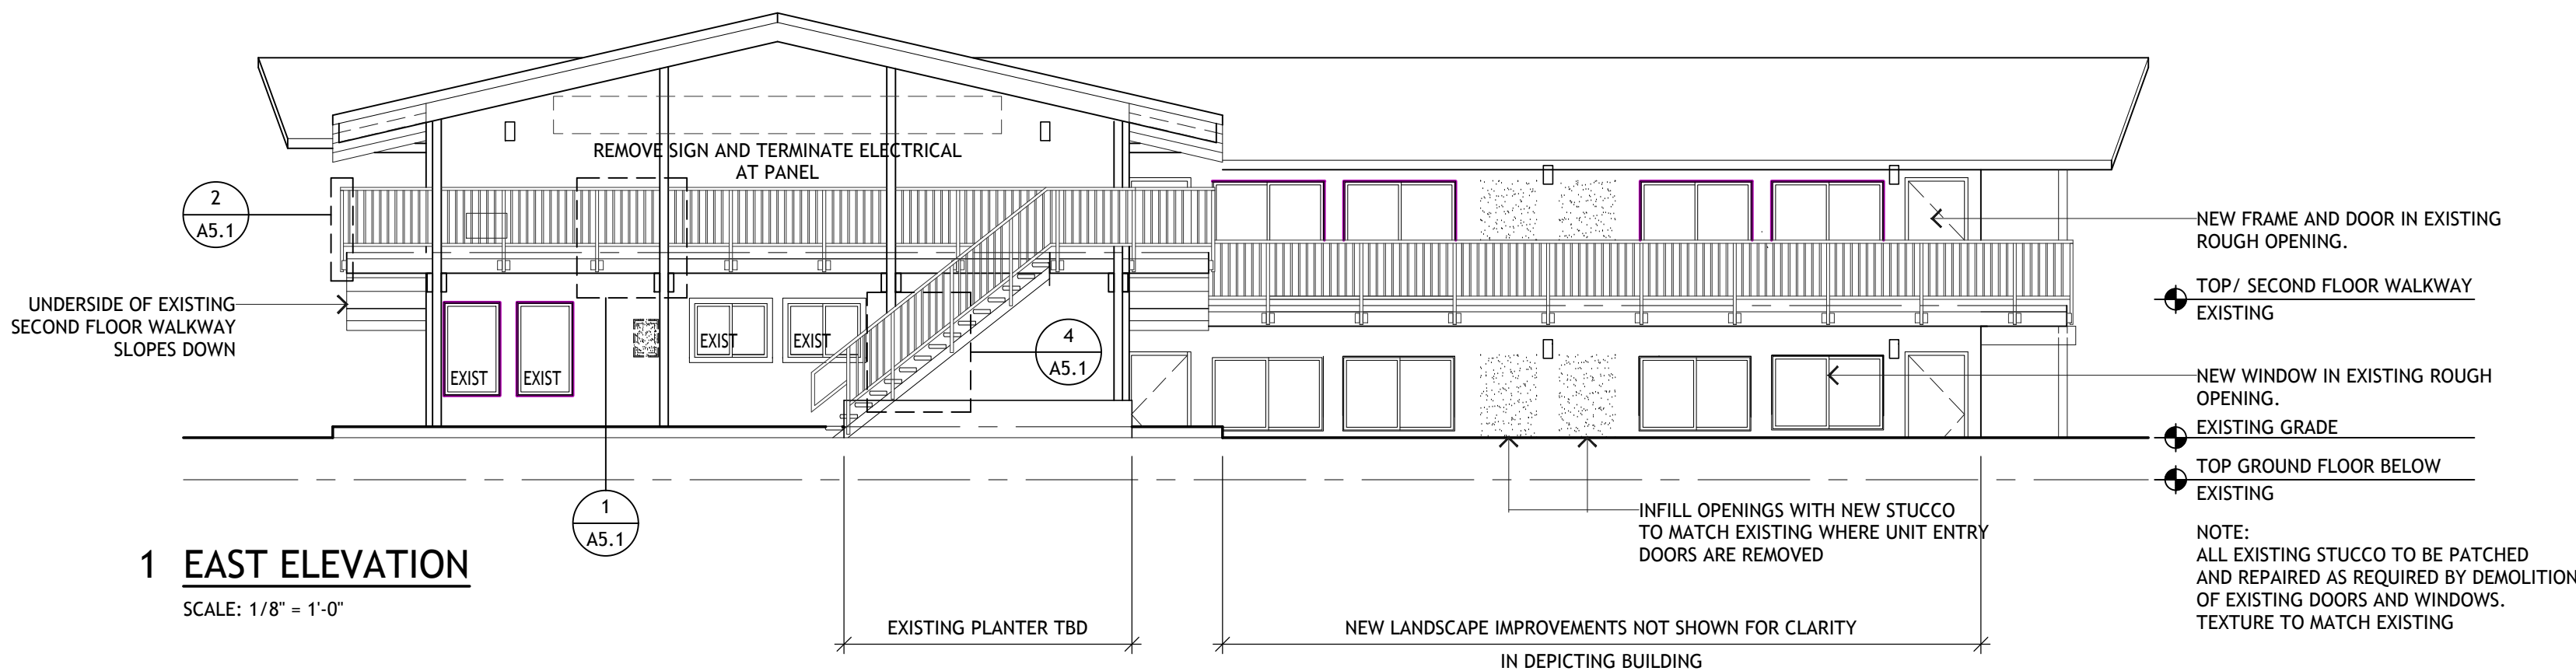
PROJECT LOCATION:


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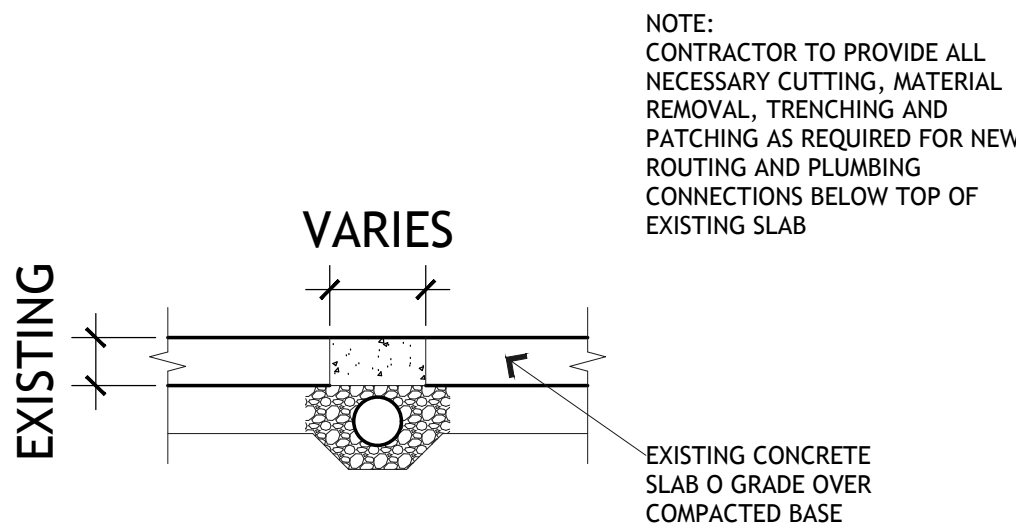
EXTERIOR
ELEVATIONS

A4.0







1 OFFICE TRANSACTION COUNTER
SCALE: 3/4" =1'-0"

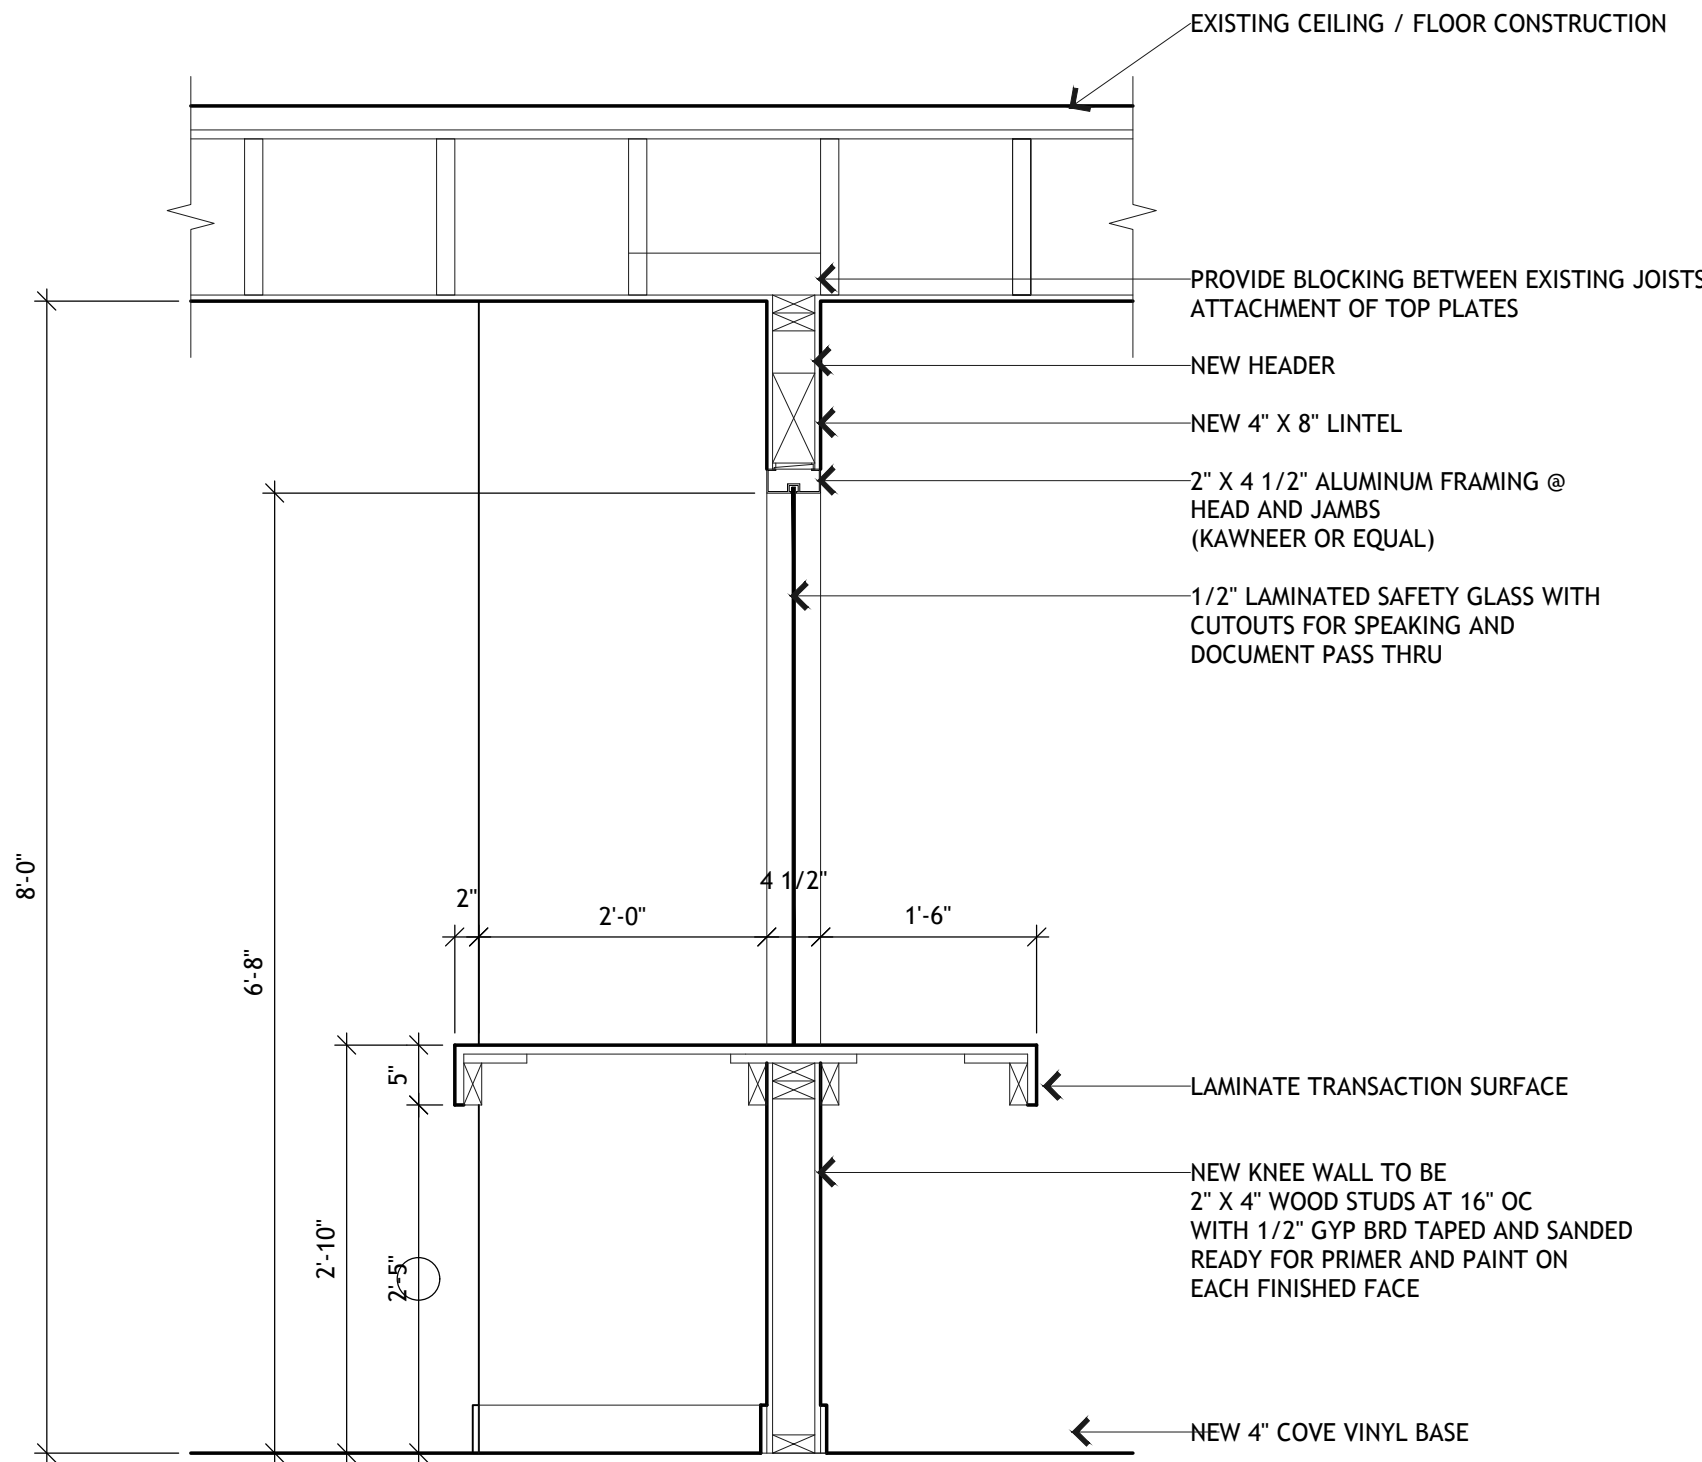


2 EXISTING CONCRETE FLOOR SLAB ON GRADE
1 HOUR RATED WITH STC 38
SCALE: 3/4" =1'-0"

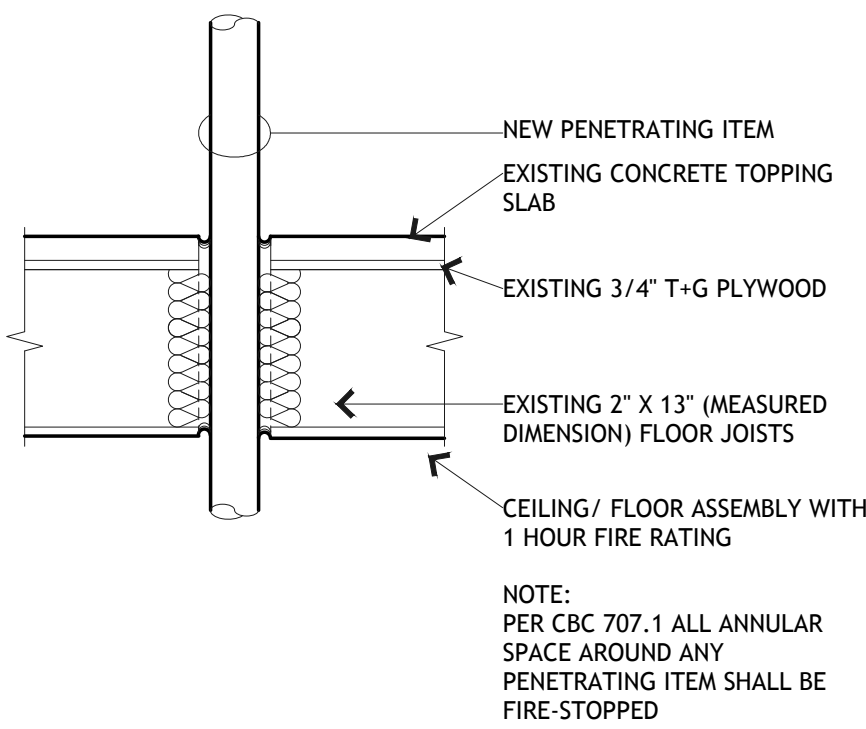


3 NEW PENETRATIONS OF EXISTING WOOD FRAMED
1 HR RATED CEILING/WALL ASSEMBLIES
SCALE: 3/4" =1'-0"

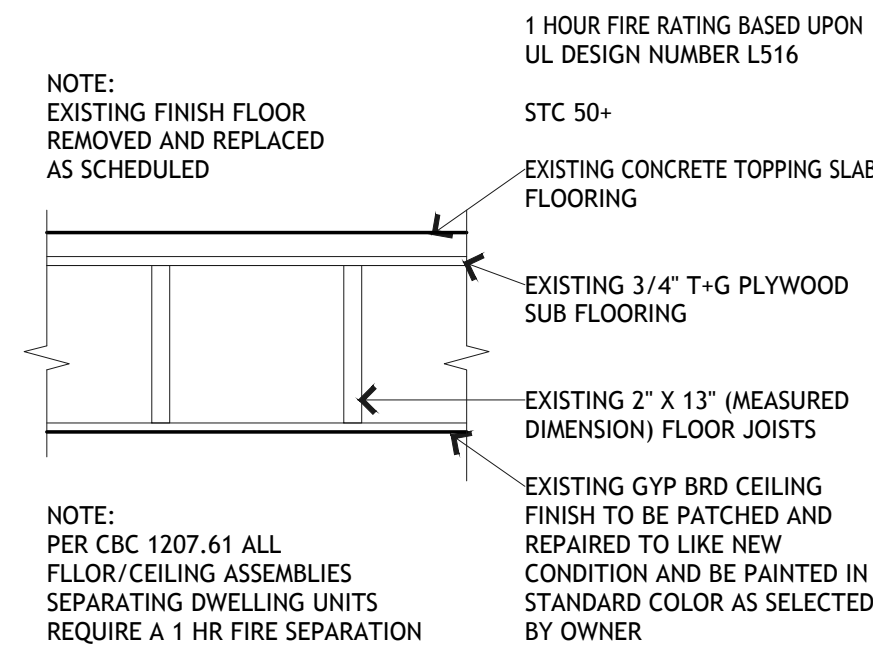


4 EXISTING WOOD FRAMED CEILING/FLOOR
1 HOUR RATED WITH STC 50
SCALE: 3/4" =1'-0"

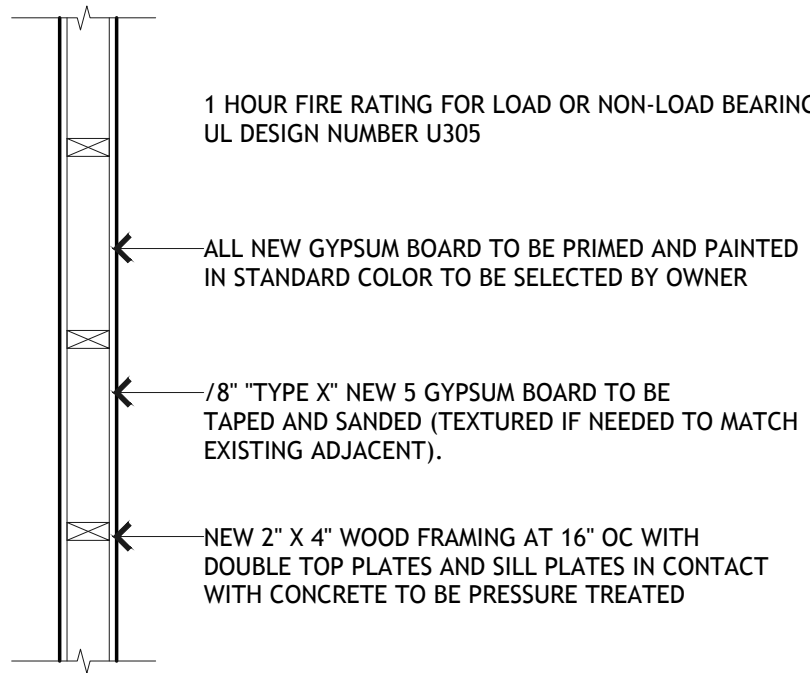


5 TYPICAL NEW BEARING OR NON-BEARING
INTERIOR PARTITION (1 HR RATED)
SCALE: 3/4" =1'-0"

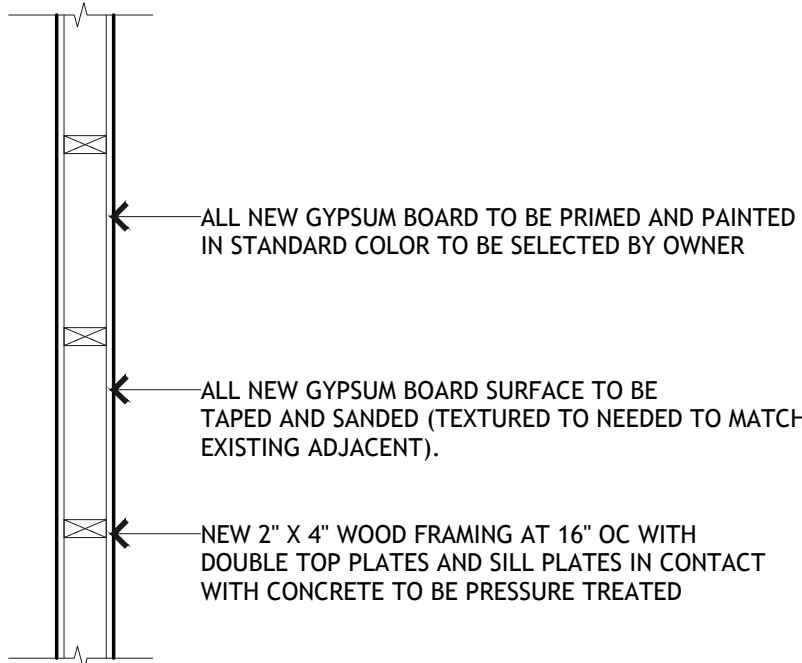


6 TYPICAL NEW BEARING OR NON-BEARING
INTERIOR PARTITION (NON-RATED)
SCALE: 3/4" =1'-0"

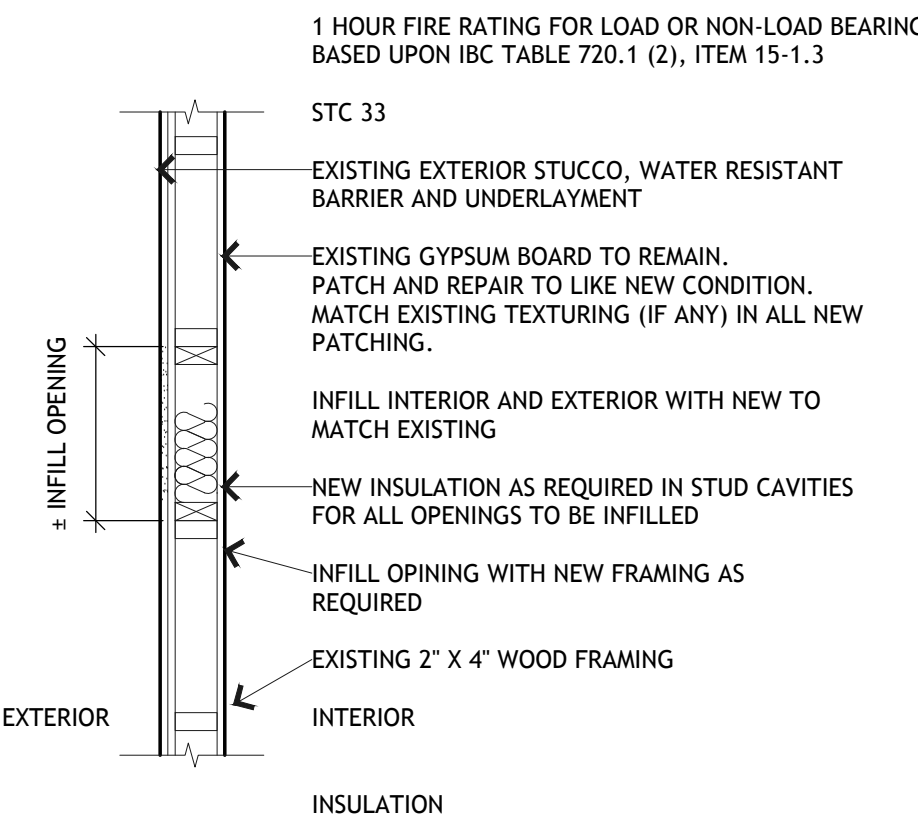


7 EXISTING EXTERIOR STUCCO WALL PATCHING
SCALE: 3/4" =1'-0"

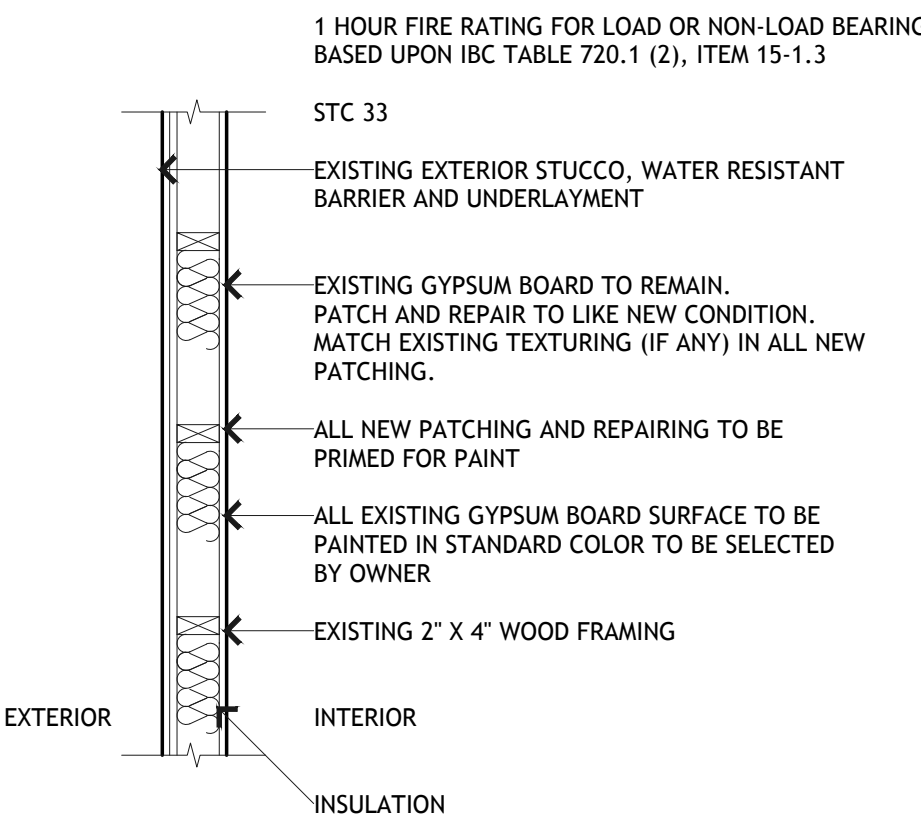

8 TYPICAL EXISTING EXTERIOR STUCCO WALL
SCALE: 3/4" =1'-0"

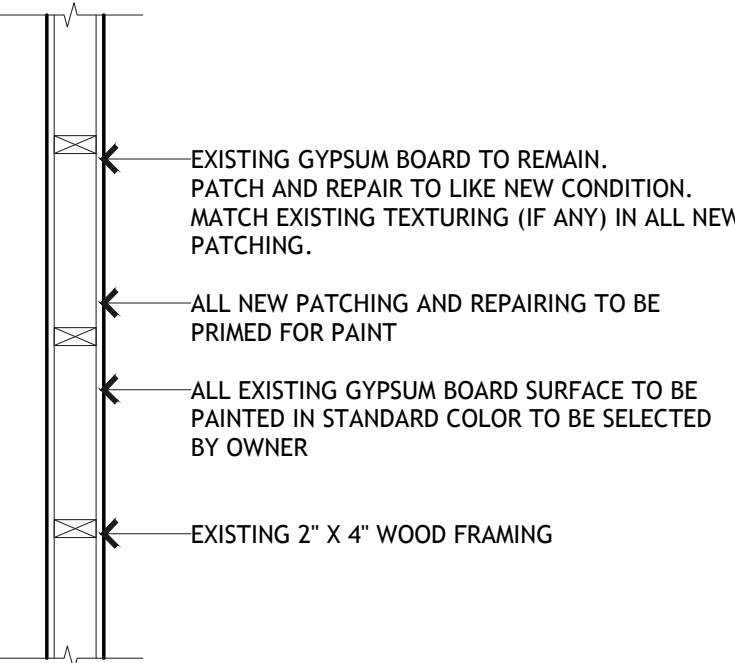

9 TYPICAL EXISTING INTERIOR PARTITION
SCALE: 3/4" =1'-0"

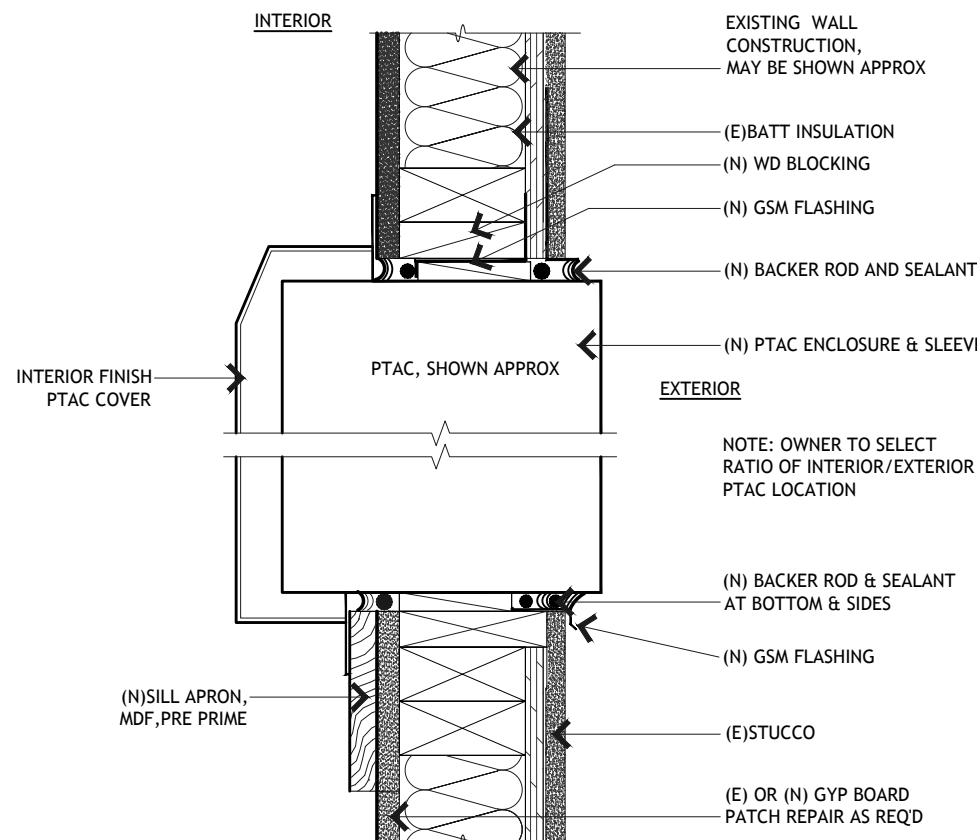

10 THRU WALL AC UNIT DETAIL AT UNITS
SCALE: 1" =1'-0"

DRAWING REVISION LOG

FOR BIO	5-15-2018

PROJECT NAME:

DESERT HAVEN
(QUEEN'S MOTEL)
RE-DEVELOPMENT

PROJECT LOCATION:


16959 STODDARD WELLS RD
VICTORVILLE, CA 92395

SHEET TITLE:

WALL DETAILS


A5.0

NOTE: SEE SHOP DRAWINGS FOR PANEL DIMENSIONS AND SPACING AT NEW RAILING

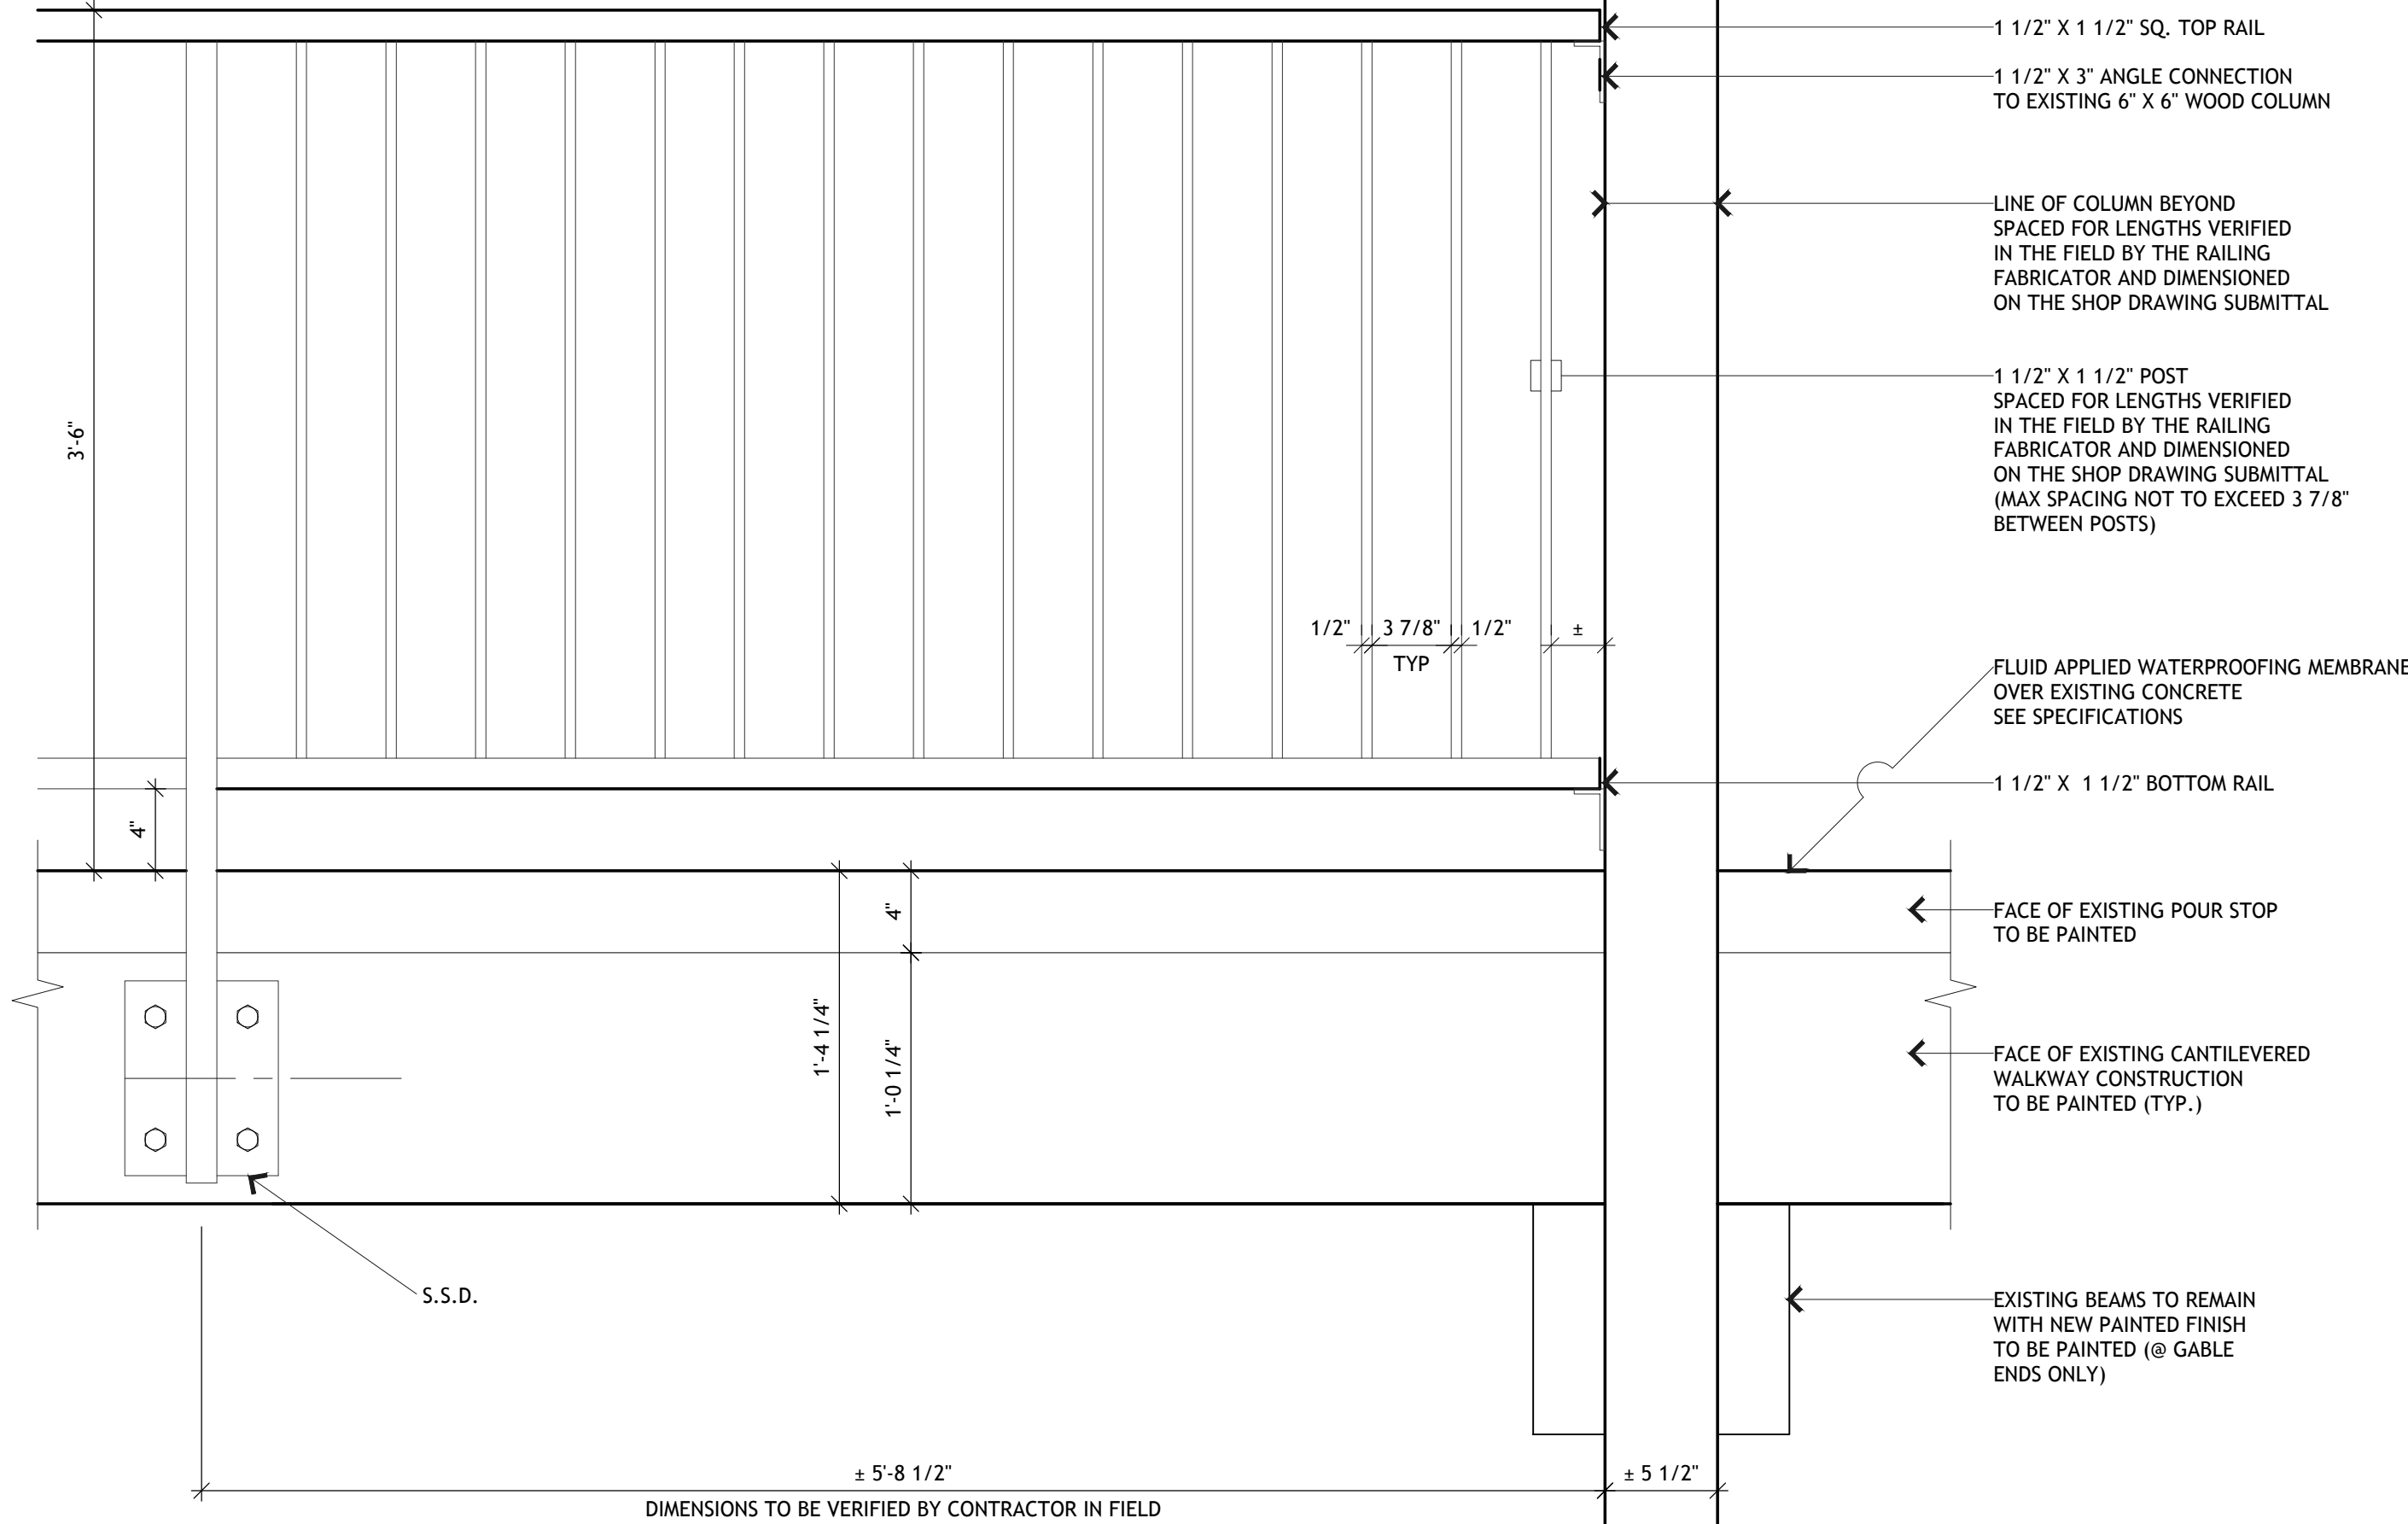


1 TYPICAL GUARD RAIL ELEVATION

SCALE: 1 1/2" = 1'-0"

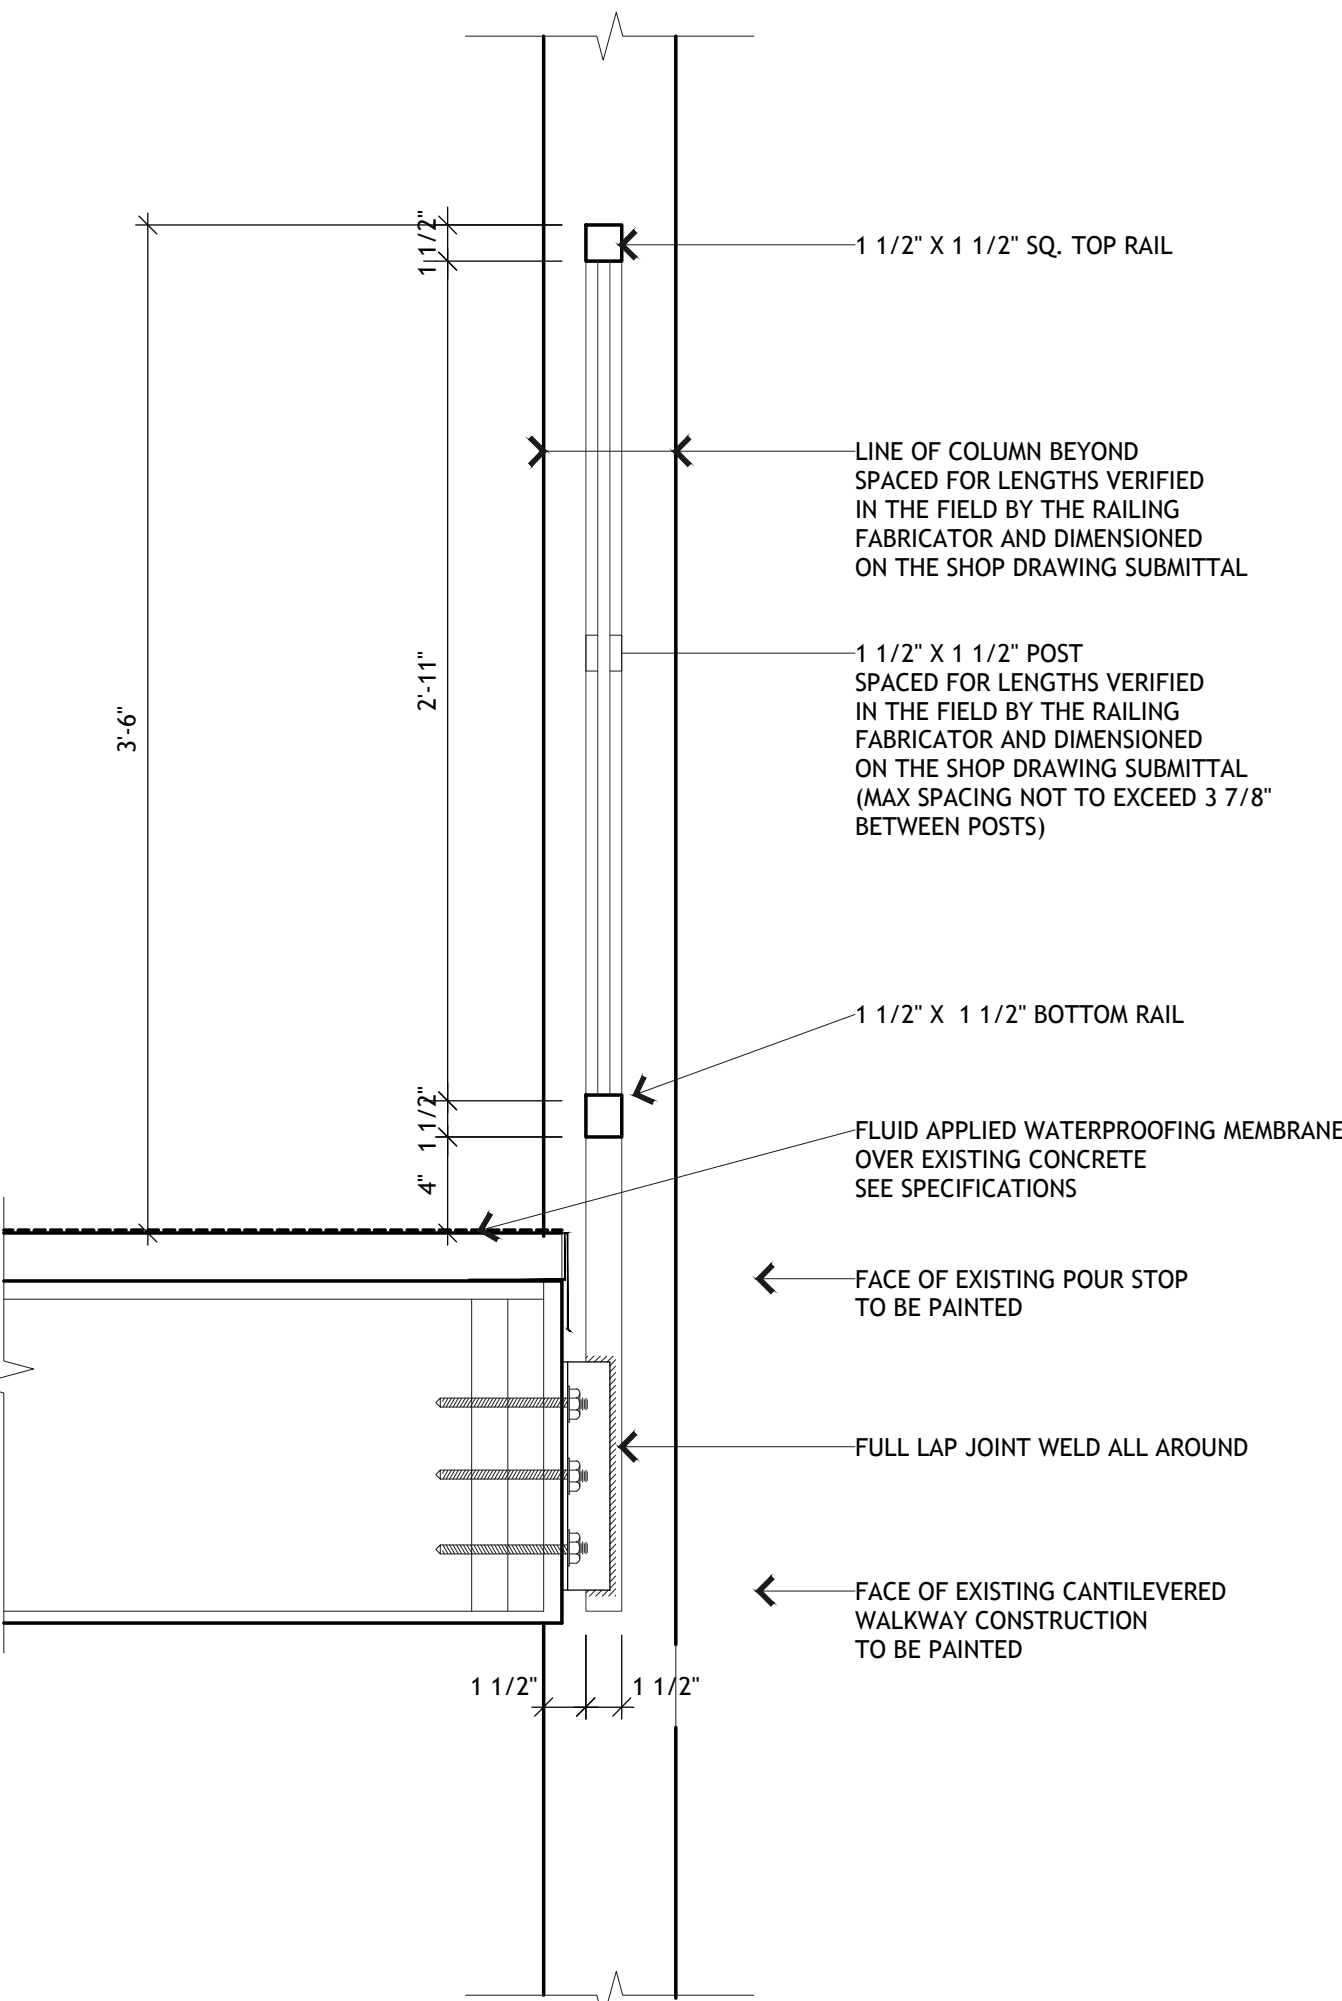

2 TYPICAL GUARD RAIL SECTION AT SECOND FLOOR

SCALE: 1 1/2" = 1'-0"

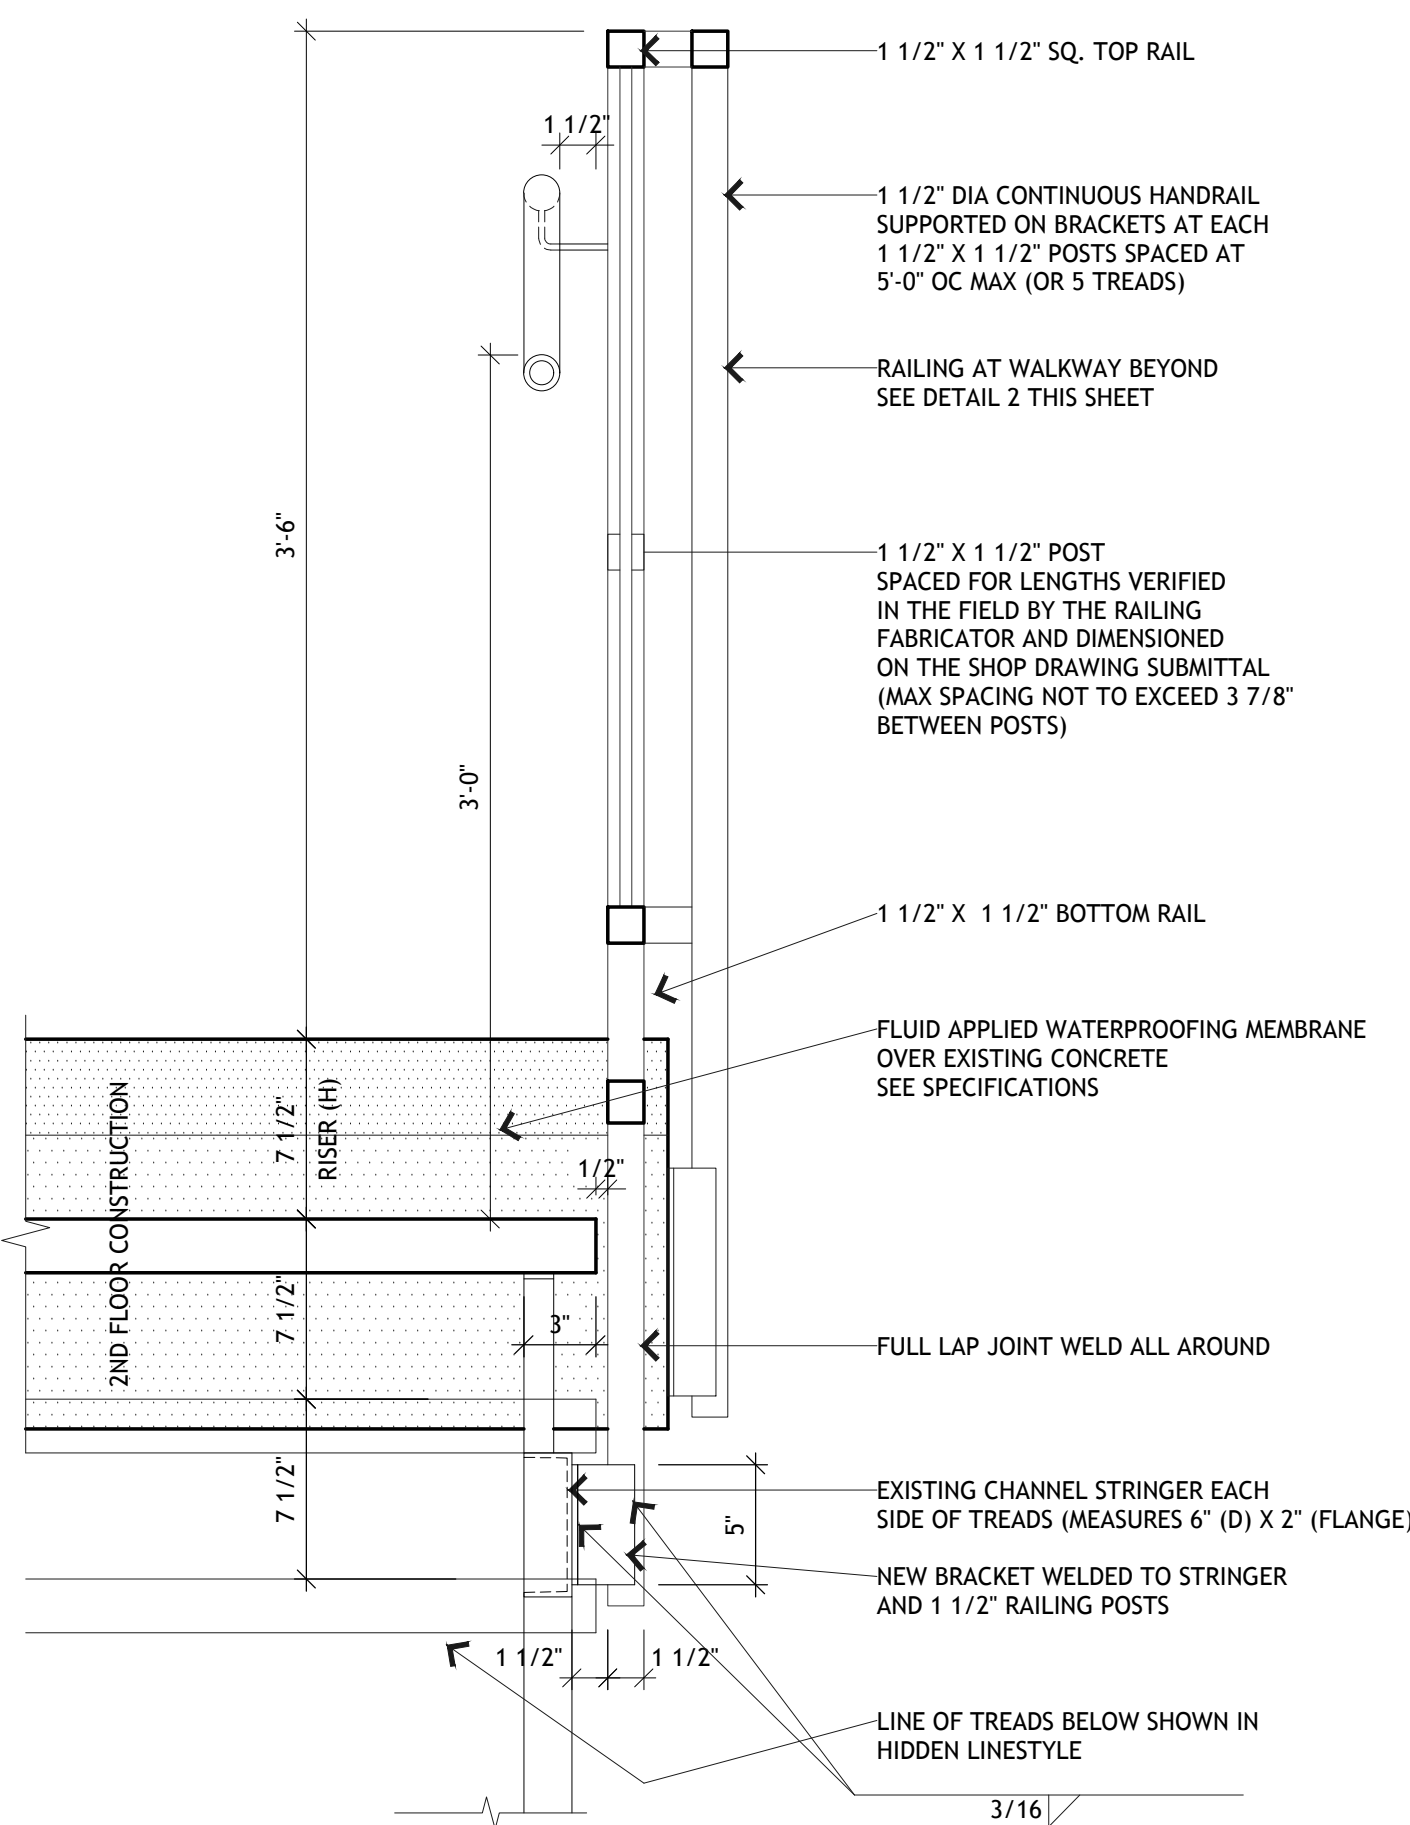

3 TYPICAL GUARD RAIL SECTION AT EXISTING STAIRS

SCALE: 1 1/2" = 1'-0"

GENERAL NOTES FOR GUARDS AND RAILINGS

- THE DETAILS SHOWN ARE INTENDED TO BE REPRESENTATIVE OF THE TYPICAL CONDITIONS FOR THE GUARDS AND RAILINGS, BUT DO NOT NECESSARILY DEPICT ALL CONDITIONS WITH RESPECT TO VARIATIONS IN THE EXISTING STAIRS TO BE REUSED IN THE NEW WORK.
- THE CONTRACTOR OR HIS SUB CONTRACTOR SHALL BE RESPONSIBLE FOR FIELD VERIFYING THE EXISTING DIMENSIONS AND CONDITIONS AT EACH BUILDING, AND SHALL ACCOUNT FOR THESE DIMENSIONS AND CONDITIONS IN THE SHOP DRAWINGS REQUIRED FOR THE GUARDS AND RAILINGS.
- THE CONTRACTOR IS SOLELY RESPONSIBLE FOR THE MEANS AND METHODS OF THE NEW WORK.

CONDITIONS FOR THE MEANS AND METHODS THAT MIGHT DIFFER FROM THE DETAILS SHOWN SHALL BE ACCOUNTED FOR IN THE SHOP DRAWING SUBMITTAL, INCLUDING BUT NOT LIMITED TO STRUCTURAL CALCULATIONS DEMONSTRATING COMPLIANCE WITH THE APPLICABLE CODES AS REFERENCED IN DETAIL ON SHEET A1.2, AND AS DUPLICATED HEREAFTER.

LOADS ON HANDRAILS

CBC 1607.7.1 HANDRAILS AND GUARDS

HANDRAILS AND GUARDS SHALL BE DESIGNED TO RESIST A LOAD OF 50 POUNDS PER LINEAR FOOT (PLF) APPLIED IN ANY DIRECTION AT THE TOP AND TO TRANSFER THIS LOAD THROUGH THE SUPPORTS TO THE STRUCTURE.

CBC 1607.7.1.1 CONCENTRATED LOAD
HANDRAILS AND GUARDS SHALL BE ABLE TO RESIST A SINGLE CONCENTRATED LOAD OF 200 POUNDS, APPLIED IN ANY DIRECTION AT ANY POINT ALONG THE TOP, AND TO TRANSFER THIS LOADS THROUGH THE SUPPORTS TO THE STRUCTURE. THIS LOAD NEED NOT BE ASSUMED TO ACT CONCURRENTLY WITH THE LOADS SPECIFIED IN 1607.7.1.

CBC 1607.7.1.2 COMPONENTS
INTERMEDIATE RAILS (ALL THIS EXCEPT THE HANDRAIL, BALUSTERS AND PANEL FILLERS SHALL BE DESIGNED TO WITHSTAND A HORIZONTALLY APPLIED NORMAL LOAD OF 50 POUNDS ON AN AREA EQUAL TO 1 SQUARE FOOT, INCLUDING OPENINGS AND SPACE BETWEEN RAILS, REACTIONS DUE TO THIS LOADING ARE NOT REQUIRED TO BE SUPERIMPOSED WITH THOSE OF SECTION 1607.7.1 OR 1607.7.1.1.

HANDRAILS

CBC 1012.2 HEIGHT
HANDRAIL HEIGHT, MEASURED ABOVE STAIR TREAD NOSING, OR FINISH SURFACE OF RAMP SLOPE, SHALL BE UNIFORM, NOT LESS THAN 34 INCHES AND NOT MORE THAN 38 INCHES.

CBC 1012.3 HANDRAIL GRASPABILITY

CBC 1012.3.1 TYPE I HANDRAILS.
HANDRAILS WITH A CIRCULAR CROSS SECTION SHALL HAVE AN OUTSIDE DIAMETER OF AT LEAST 1 1/4 INCHES AND NOT GREATER THAN 2 INCHES. IF THE HANDRAIL IS NOT CIRCULAR, IT SHALL HAVE A PERIMETER DIMENSION OF AT LEAST 4 INCHES AND NOT GREATER THAN 6 1/2 INCHES WITH A MAXIMUM CROSS-SECTION DIMENSION OF 2 1/4 INCHES. EDGES SHALL HAVE A MINIMUM RADIUS OF 0.01 INCH.


CBC 1012.4 CONTINUITY
HANDRAIL GRIPPING SURFACES SHALL BE CONTINUOUS, WITHOUT INTERRUPTION...

CBC 1013.2 (REQUIRED HEIGHT OF) GUARDS
REQUIRED GUARDS SHALL BE NOT LESS THAN 42 INCHES HIGH, MEASURED VERTICALLY ABOVE THE ADJACENT WALKING SURFACES.

CBC 1013.3 OPENING LIMITATIONS
REQUIRED GUARDS SHALL NOT HAVE OPENINGS WHICH ALLOW PASSAGE OF A SPHERE 4 INCHES IN DIAMETER FROM THE WALKING SURFACE TO THE REQUIRED GUARD HEIGHT.


EXCEPTIONS:
FROM A HEIGHT OF 36 INCHES TO 42 INCHES, GUARDS SHALL NOT HAVE OPENINGS WHICH ALLOW PASSAGE OF A SPHERE 4 3/8 INCHES IN DIAMETER.

THE TRIANGULAR OPENINGS AT THE OPEN SIDE OF A STAIR, FORMED BY THE RISER, TREAD AND BOTTOM RAIL SHALL NOT ALLOW PASSAGE OF A SPHERE 6 INCHES IN DIAMETER.

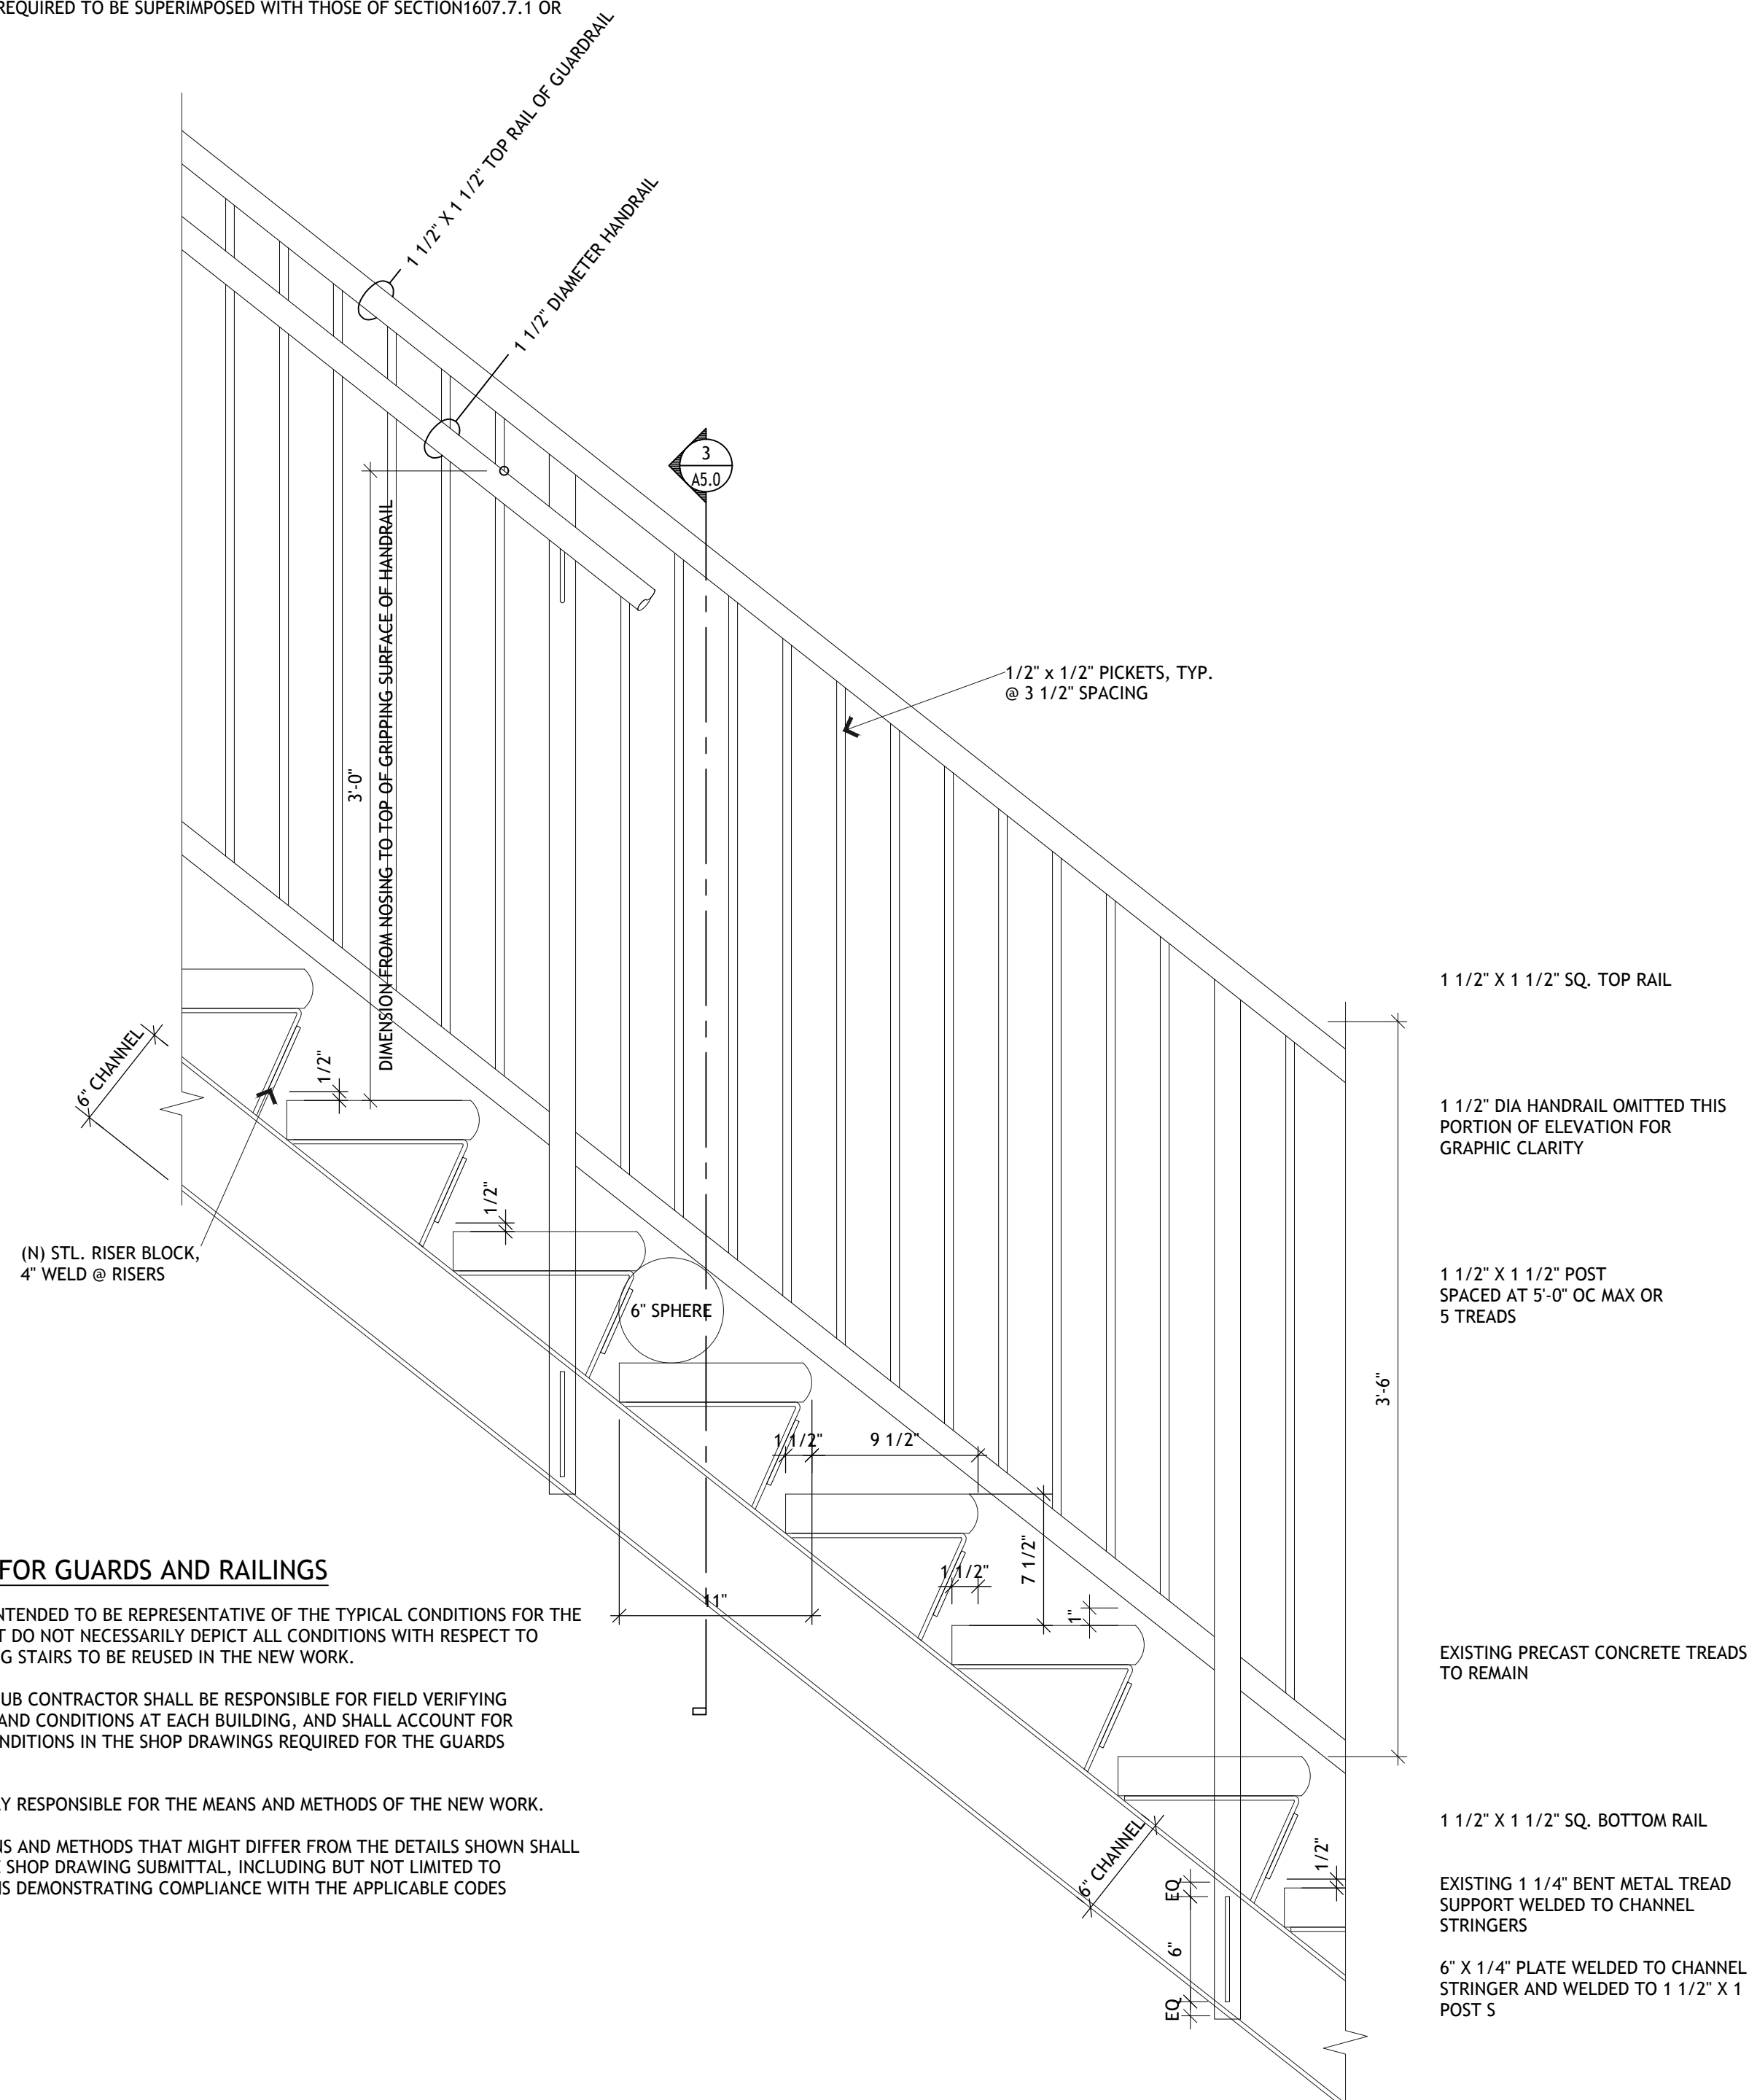

4 DETAIL ELEVATION OF RAILING AND HANDRAIL AT EXISTING STAIR

SCALE: 1 1/2" = 1'-0"

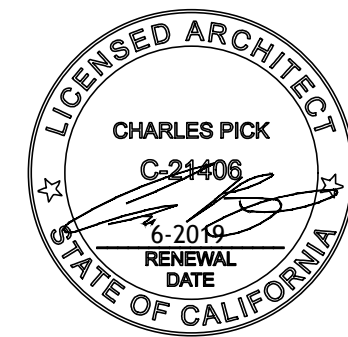

DRAWING REVISION LOG

FOR BIO	5-15-2018

PROJECT NAME:

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(QUEEN'S MOTEL)
RE-DEVELOPMENT

PROJECT LOCATION:

16959 STODDARD WELLS RI
VICTORVILLE, CA 92395

SHEET TITLE:

RAILING
DETAILS



DRAWING REVISION LOG

FOR BIO	5-15-2018

PROJECT NAME:

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(QUEEN'S MOTEL)
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PROJECT LOCATION:

16959 STODDARD WELLS RI
VICTORVILLE, CA 92395

SHEET TITLE:


RAILING
DETAILS

A5.2


GENERAL NOTES FOR GUARDS AND RAILINGS

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- THE CONTRACTOR OR HIS SUB CONTRACTOR SHALL BE RESPONSIBLE FOR FIELD VERIFYING THE EXISTING DIMENSIONS AND CONDITIONS AT EACH BUILDING, AND SHALL ACCOUNT FOR THESE DIMENSIONS AND CONDITIONS IN THE SHOP DRAWINGS REQUIRED FOR THE GUARDS AND RAILINGS.
- THE CONTRACTOR IS SOLELY RESPONSIBLE FOR THE MEANS AND METHODS OF THE NEW WORK.


CONDITIONS FOR THE MEANS AND METHODS THAT MIGHT DIFFER FROM THE DETAILS SHOWN SHALL BE ACCOUNTED FOR IN THE SHOP DRAWING SUBMITTAL.

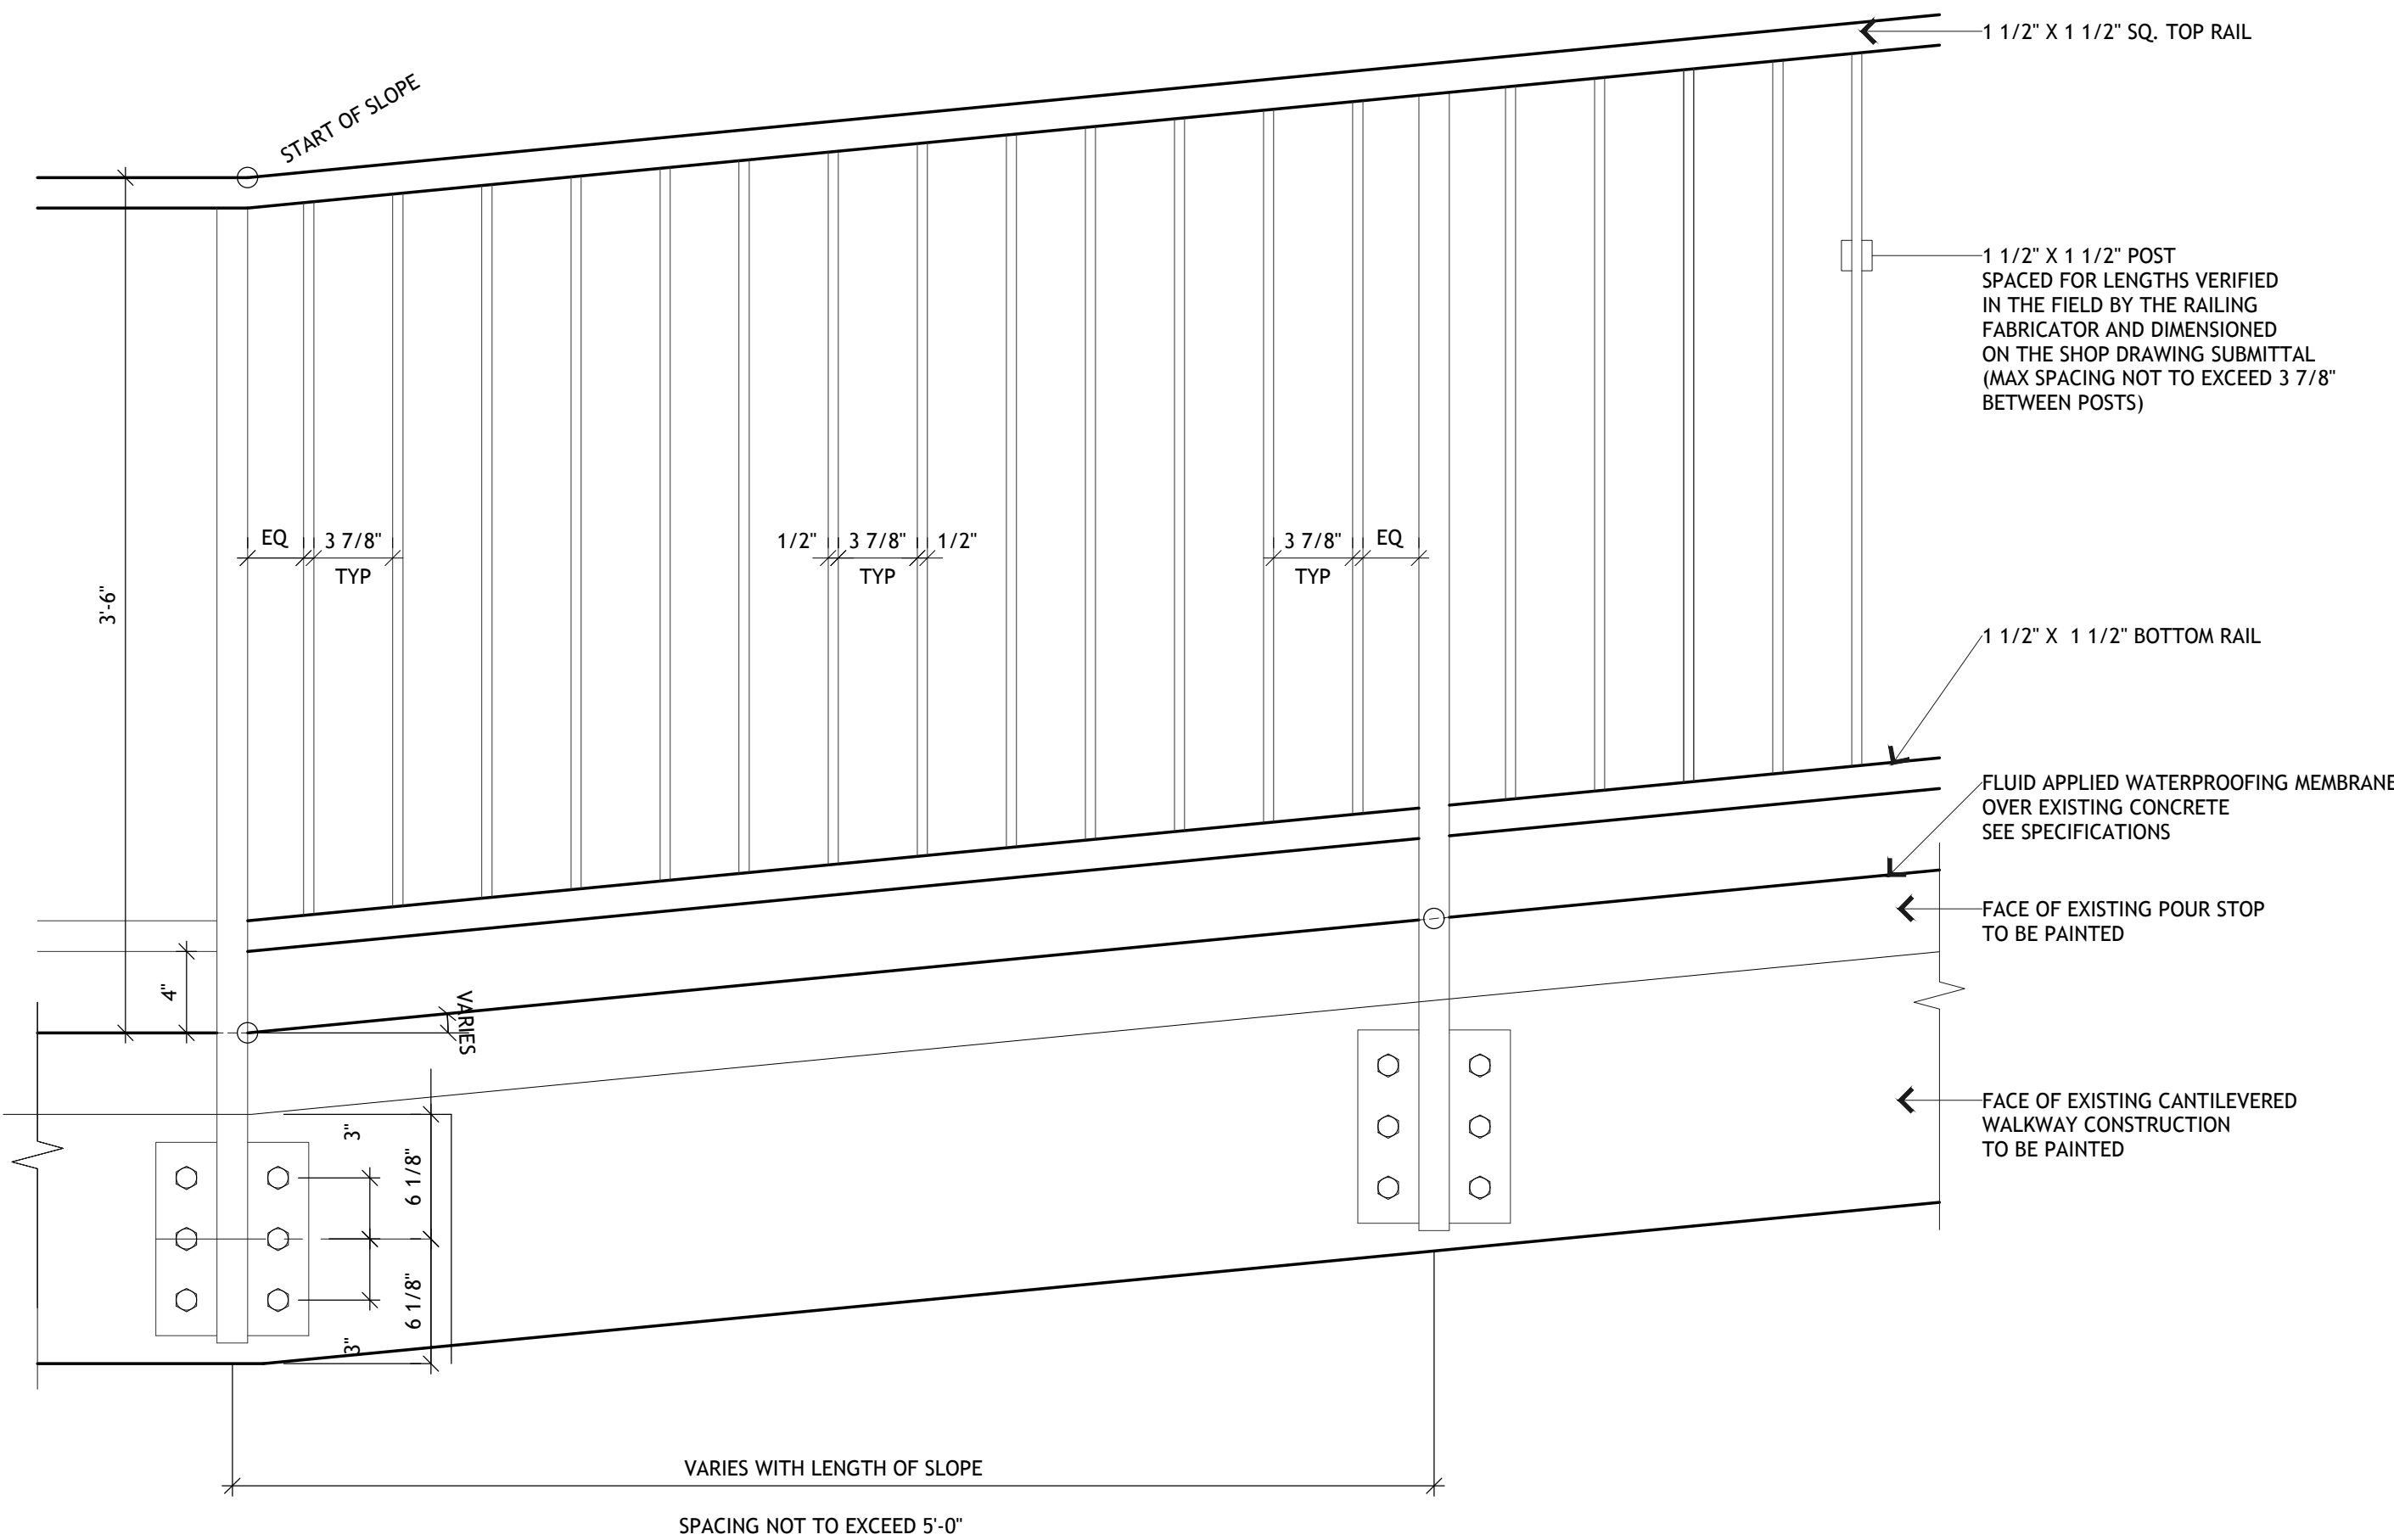

3 DETAIL ELEVATION OF RAILING AT EXISTING SLOPING SECOND FLOOR WALKWAY
SCALE: 1 1/2" = 1'-0"

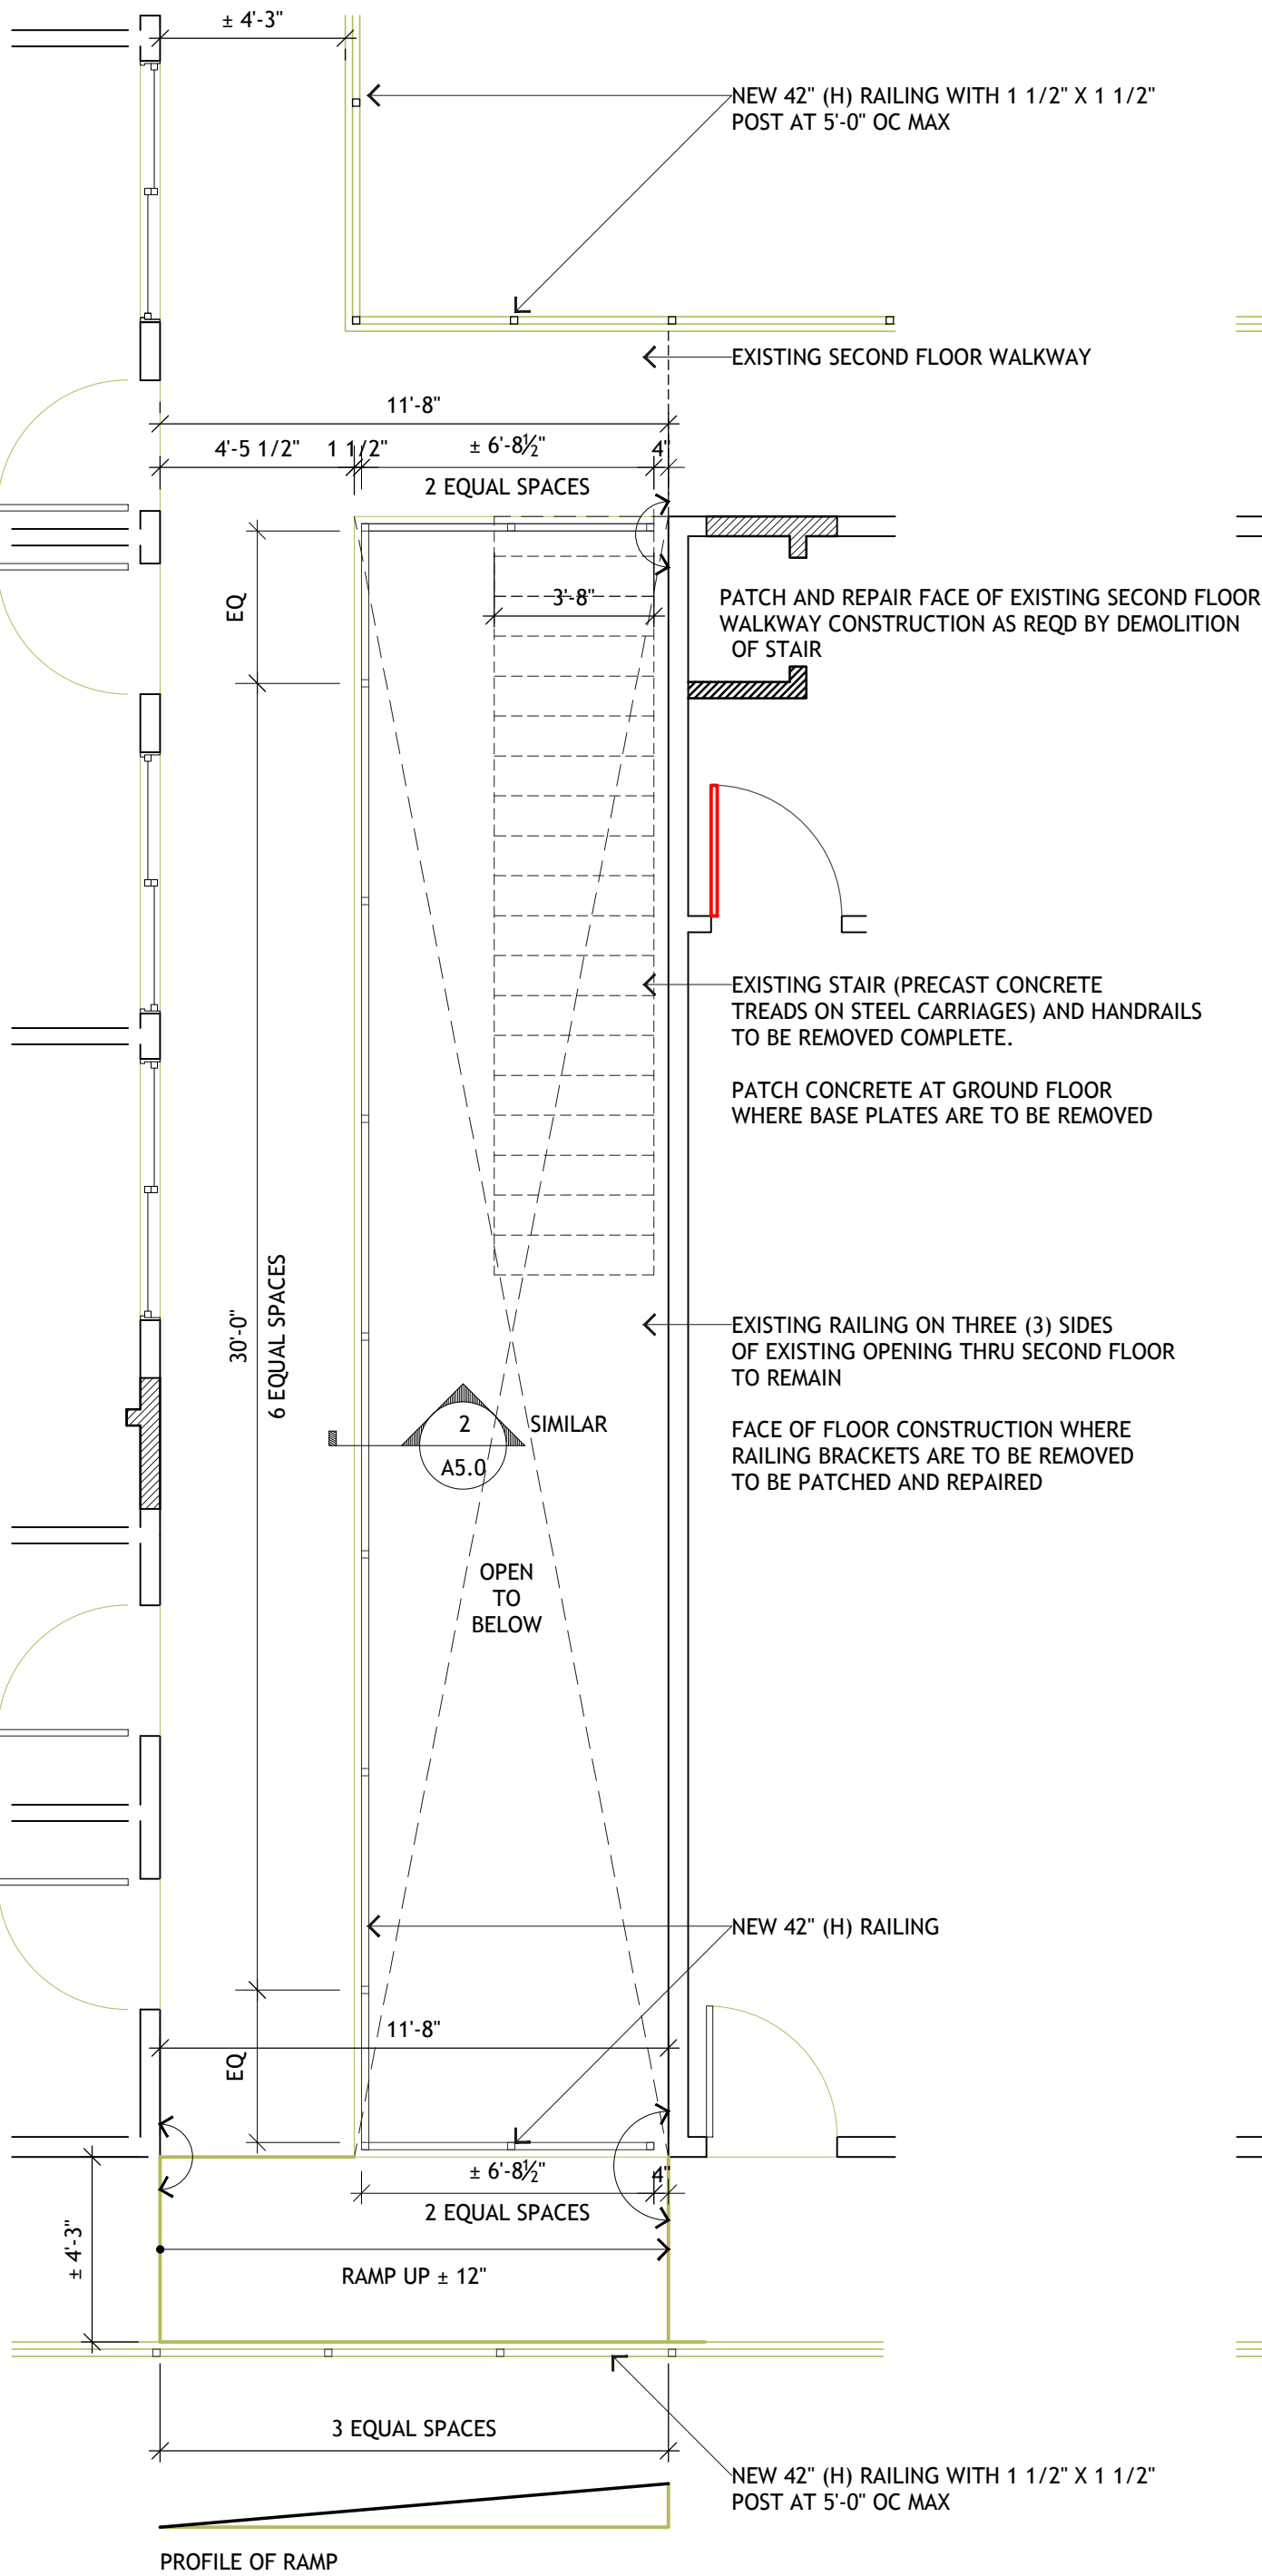



1 DETAIL PLAN OF NEW RAILING AT EXISTING SECOND FLOOR OPENING
SCALE: 14" = 1'-0"

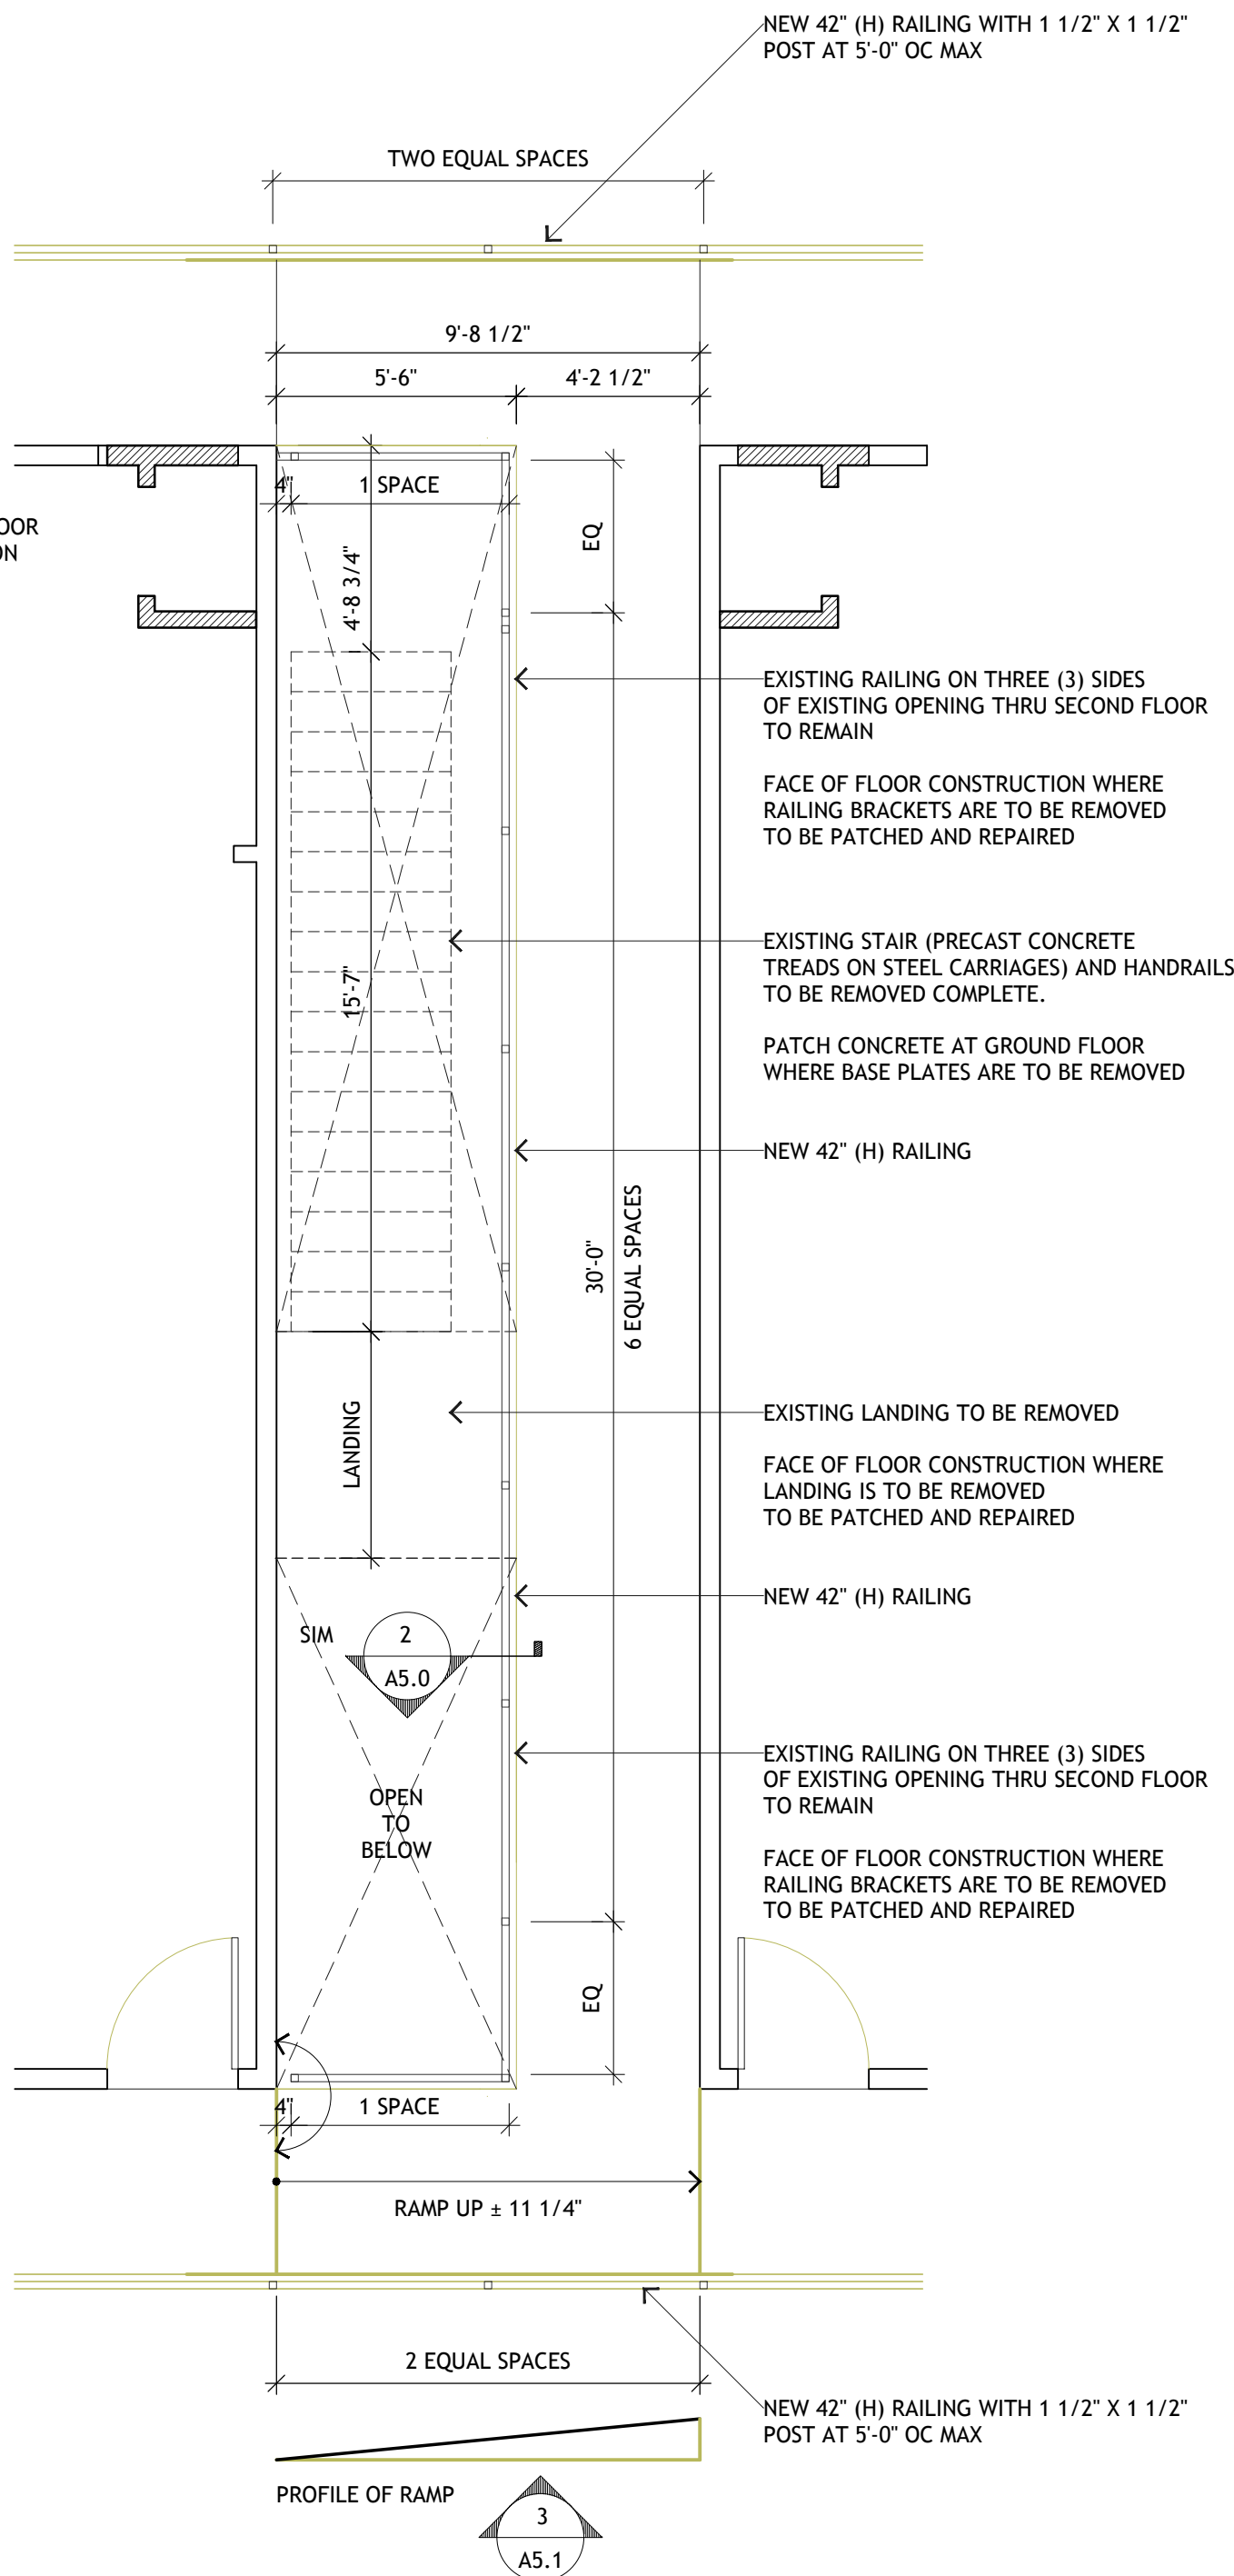

2 DETAIL PLAN OF NEW RAILING AT EXISTING SECOND FLOOR OPENING
SCALE: 14" = 1'-0"

- NOTES:
- GRAB BARS AND TOILET SEAT AND ALL ASSOCIATED FASTENERS SHALL SUSTAIN 250 POUND FORCE IN DIRECT LOAD, POINT LOAD OR SHEAR AT ANY POINT. GRAB BARS SHALL NOT ROTATE WITHIN FITTINGS. INSTALL BLOCKING AS REQUIRED.
 - WALL SURFACES SHALL BE FREE OF SHARP OR ABRASIVE ELEMENTS. EDGES SHALL HAVE A MINIMUM RADIUS OF $\frac{3}{8}$ ".
 - ALL FAUCETS SHALL BE OF LEVER TYPE AND USABLE WITH ONE HAND TO OPERATE.

PROVIDE SHOWER/TUB WITH SHOWER SPRAY UNIT WITH A HOSE 59" LONG MINIMUM THAT CAN BE USED BOTH AS A FIXED POSITION SHOWER HEAD AND AS A HAND-HELD SHOWER. THE SHOWER SPRAY UNIT SHALL HAVE AN ON/OFF CONTROL WITH A NON-POSITIVE SHUT OFF.

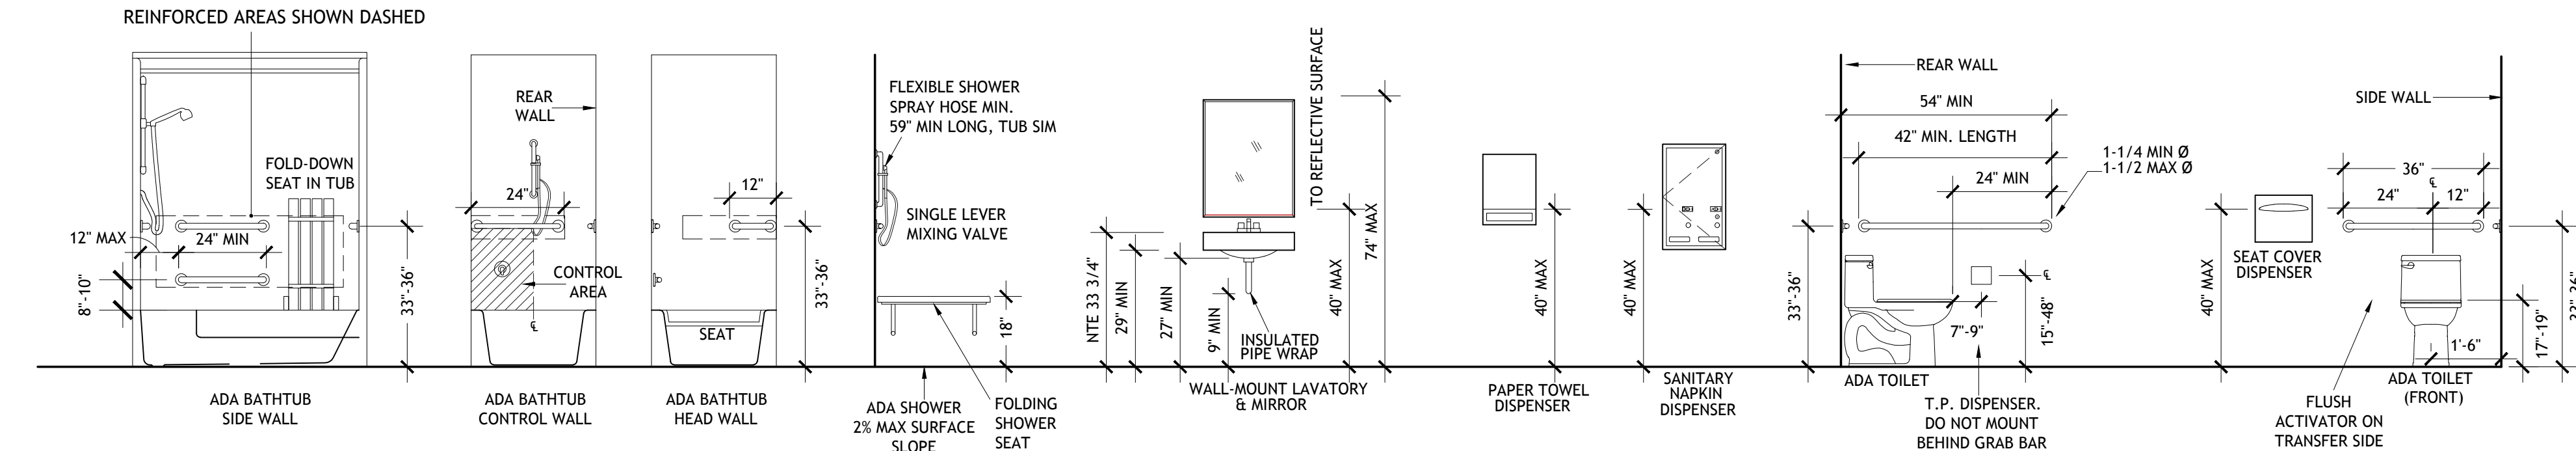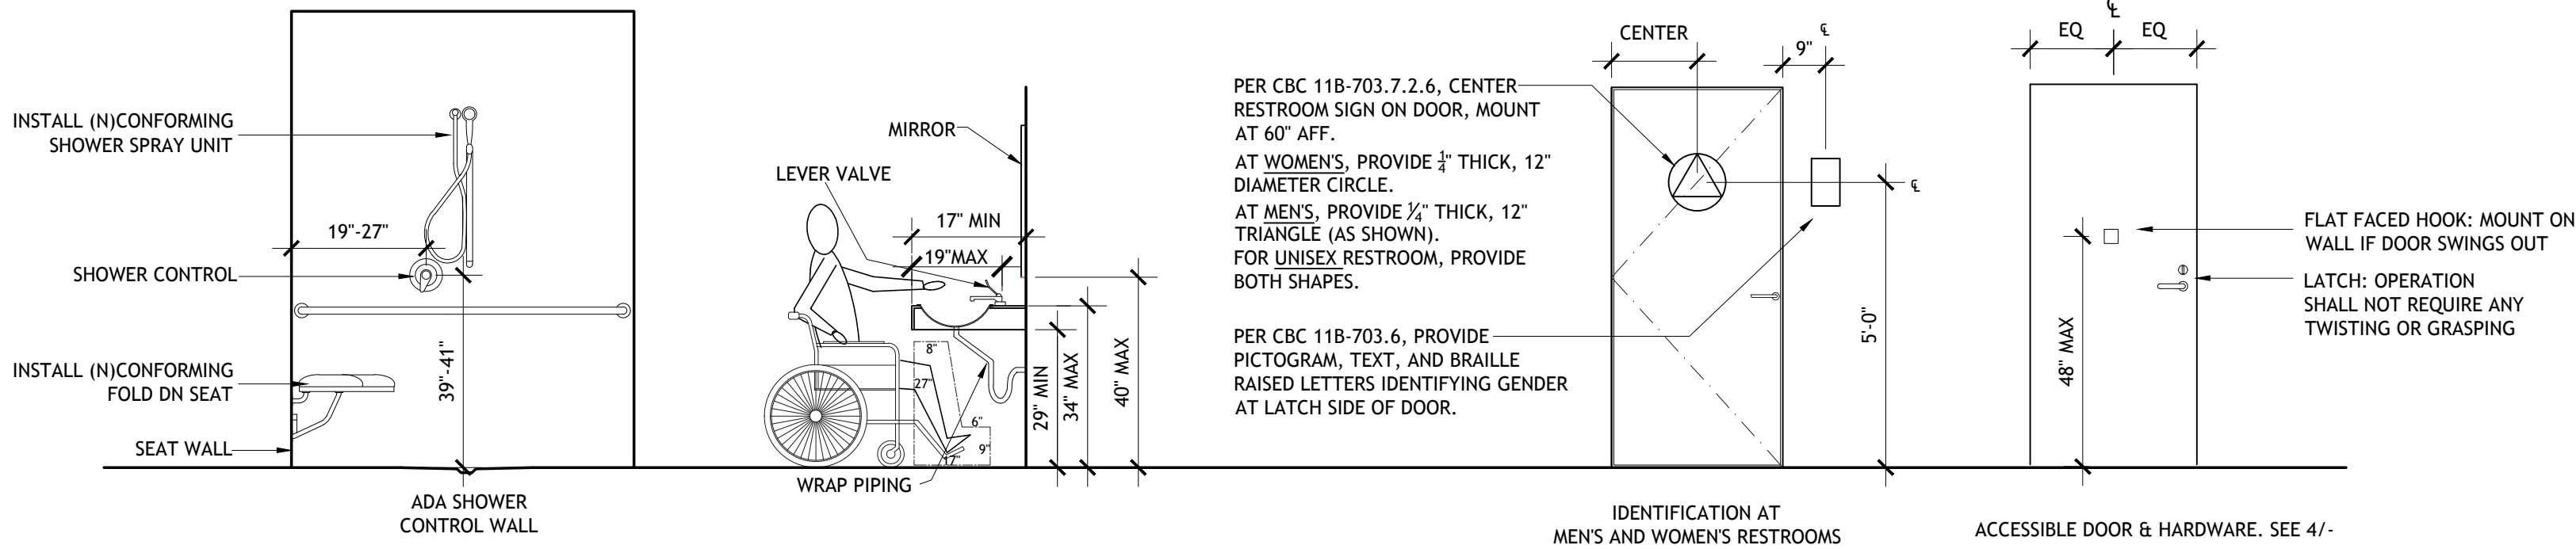


5 REFERENCE MOUNTING HEIGHTS FOR BATHS

SCALE: $\frac{3}{8}$ " = 1'-0"

NOTES:

HANDRAILS ARE REQUIRED ON PEDESTRIAN RAMPS THAT PROVIDE ACCESS, EXCEPT THAT AT EXTERIOR DOOR LANDINGS, HANDRAILS ARE NOT REQUIRED ON RAMPS LESS THAN 6' RISE OR 72" IN LENGTH.


- HANDRAILS ARE ON BOTH SIDES AND CONTINUOUS THE FULL LENGTH OF THE RAMP.
- FINISH HEIGHT OF HANDRAILS 34"-38" ABOVE RAMP SURFACE.
- HANDRAILS EXTEND A MIN. OF 12" OF LEVEL DISTANCE BEYOND TOP AND BOTTOM OF THE RAMP AND ARE RETURNED.
- HANDRAIL HAS SMOOTH SURFACE, NO SHARP EDGES OR CORNERS, AND EDGES HAVE A MIN. RADIUS OF $\frac{1}{4}$ ".
- HANDRAIL HAS ENOUGH MIN. STRUCTURAL STRENGTH TO SUPPORT A 250-LB. POINT LOAD.
- HANDRAILS DO NOT ROTATE WITHIN THEIR FITTINGS.
- WALL OR OTHER SURFACE ADJACENT TO THE HANDRAIL IS FREE OF SHARP OR ABRASIVE ELEMENTS.
- ENDS OF HANDRAILS ARE EITHER ROUNDED OR RETURNED SMOOTHLY TO FLOOR, WALL, OR OTHER POST.

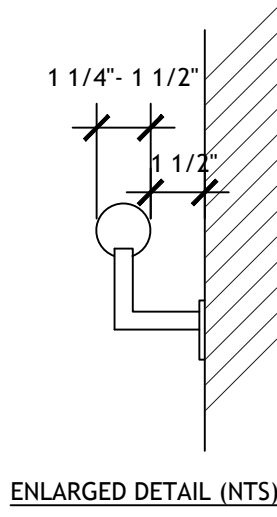

ENLARGED DETAIL (NTS)


9 HANDRAILS

SCALE: 1 1/2" = 1'-0"

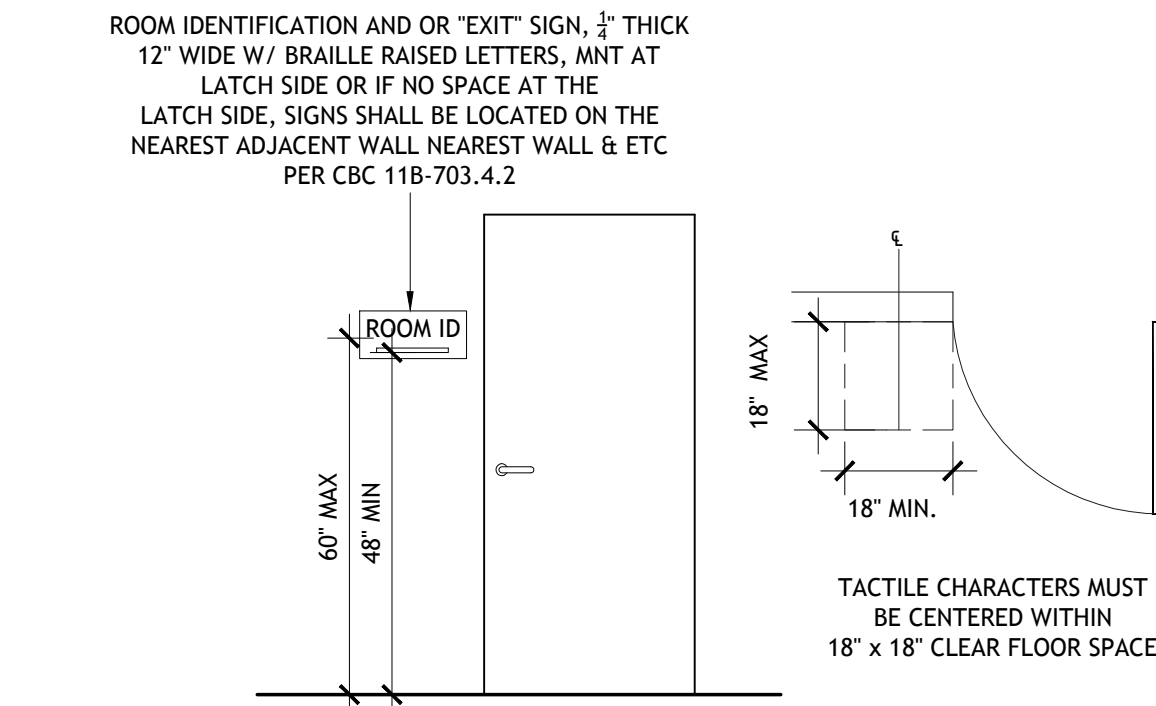

7 INTERIOR OR EXTERIOR ROOM I.D.

SCALE: $\frac{3}{8}$ " = 1'-0"

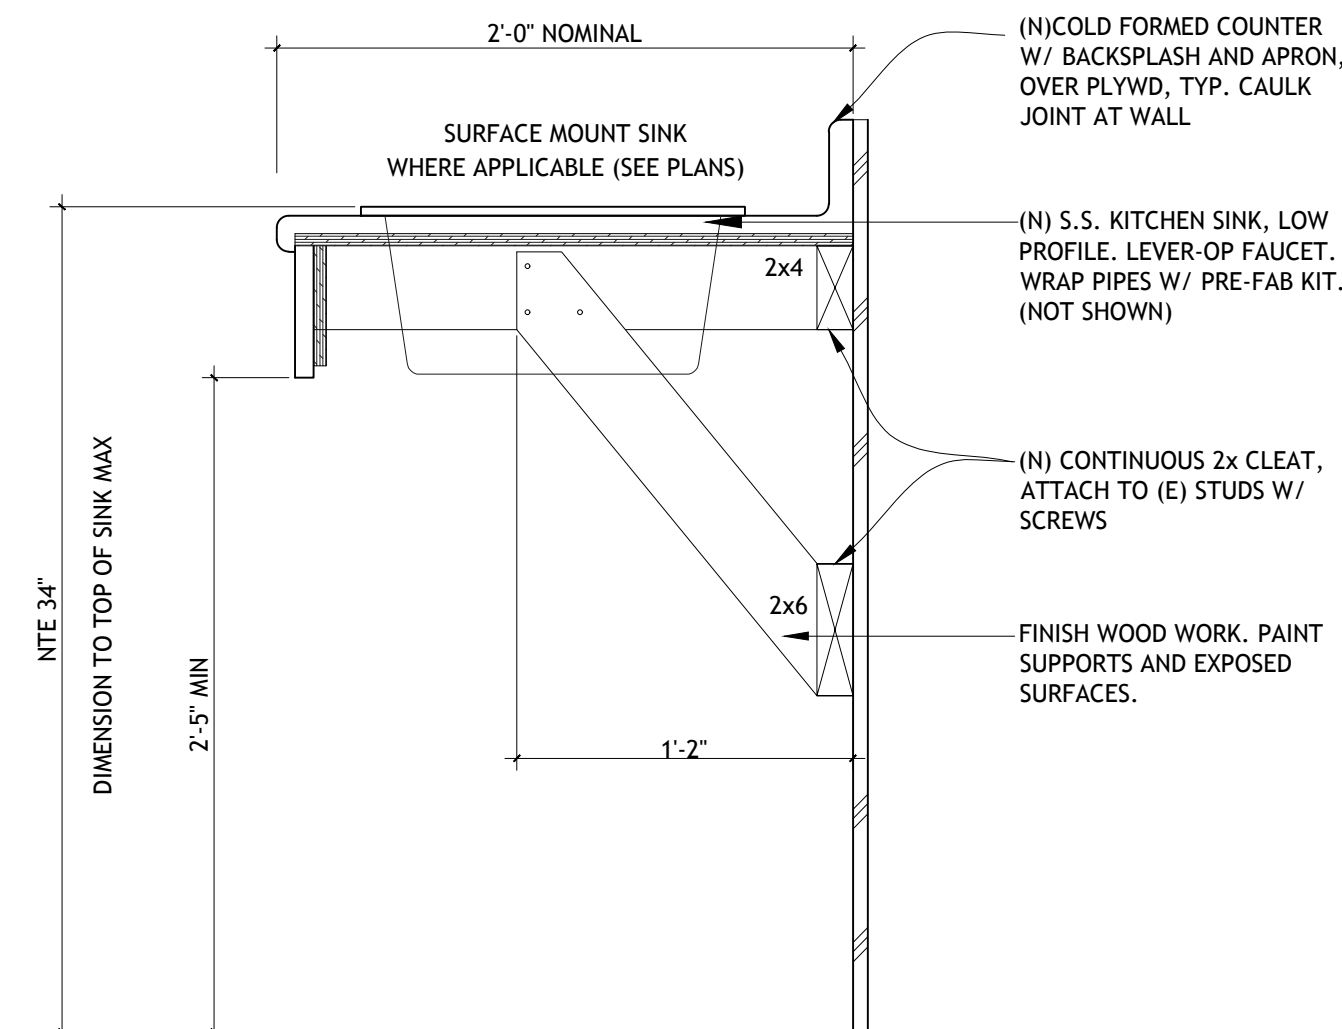

8 LAUNDRY FOLDING COUNTER AND SINK

SCALE: 1 1/2" = 1'-0"


ACCESSIBLE REACH RANGES:

- A CLEAR FLOOR SPACE (30"x48") SHALL BE PROVIDED FOR EITHER A FORWARD OR PARALLEL APPROACH.
- FORWARD REACH:
 - UNOBSTRUCTED: THE HIGH FORWARD REACH SHALL BE 48 INCHES MAXIMUM AND THE LOW FORWARD REACH SHALL BE 15 INCHES MINIMUM ABOVE THE F.F. OR GROUND.
 - OBSTRUCTED HIGH REACH: WHEN REACHING OVER AN OBSTRUCTION, THE CLEAR FLOOR SPACE SHALL EXTEND BENEATH THE ELEMENT FOR A DISTANCE NOT LESS THAN THE REQUIRED REACH DEPTH OVER THE OBSTRUCTION. THE HIGH FORWARD REACH SHALL BE 48 INCHES ABOVE F.F. MAXIMUM WHERE REACH DEPTH IS UP TO 20 INCHES, AND 44 INCHES ABOVE F.F. WHEN REACH DEPTH IS 20-25 INCHES MAXIMUM. NO OBSTRUCTION MAY BE GREATER THAN 25".
- SIDE REACH:
 - UNOBSTRUCTED: THE HIGH SIDE REACH SHALL BE 48 INCHES ABOVE F.F. MAXIMUM AND THE LOW SIDE REACH SHALL BE 15 INCHES MINIMUM ABOVE F.F. OR GROUND.
 - OBSTRUCTED HIGH REACH: WHEN THE SIDE REACH IS OVER AN OBSTRUCTION, THE HEIGHT OF THE OBSTRUCTION SHALL BE 34 INCHES MAXIMUM AND THE DEPTH OF THE OBSTRUCTION SHALL BE 24 INCHES MAXIMUM. THE HIGH SIDE REACH SHALL BE 48 INCHES AND THE FOR A REACH DEPTH UP TO 10 INCHES, AND 46 INCHES MAXIMUM FOR A REACH DEPTH OF 10-24 INCHES MAXIMUM.
- OPERABLE PARTS:
 - OPERABLE PARTS SHALL BE WITHIN REACH THE ACCESSIBLE REACH RANGES.
 - OPERATIONAL PARTS SHALL HAVE THE REQUIRED CLEAR FLOOR SPACE.
 - OPERABLE PARTS SHALL BE OPERABLE WITH ONE HAND AND SHALL NOT REQUIRE TIGHT GRASPING OR TWISTING OF THE WRIST. THE FORCE REQUIRED TO ACTIVATE OPERABLE PARTS SHALL BE 5 POUNDS MAXIMUM.

COMMUNICATIONS FEATURES:



- NOTIFICATION: A DOOR BELL SHALL BE PROVIDED THAT INDICATES AN AUDIBLE TONE AND VISUAL SIGNAL WITHIN THE UNIT.
- IDENTIFICATION: A PEEP HOLE WITH A MINIMUM VIEWABLE ANGLE OF 180 DEGREES & MOUNTED AT 43 INCHES ABOVE F.F. SHALL BE INSTALLED AT UNIT ENTRANCE DOORS.

6 ACCESSIBILITY NOTES

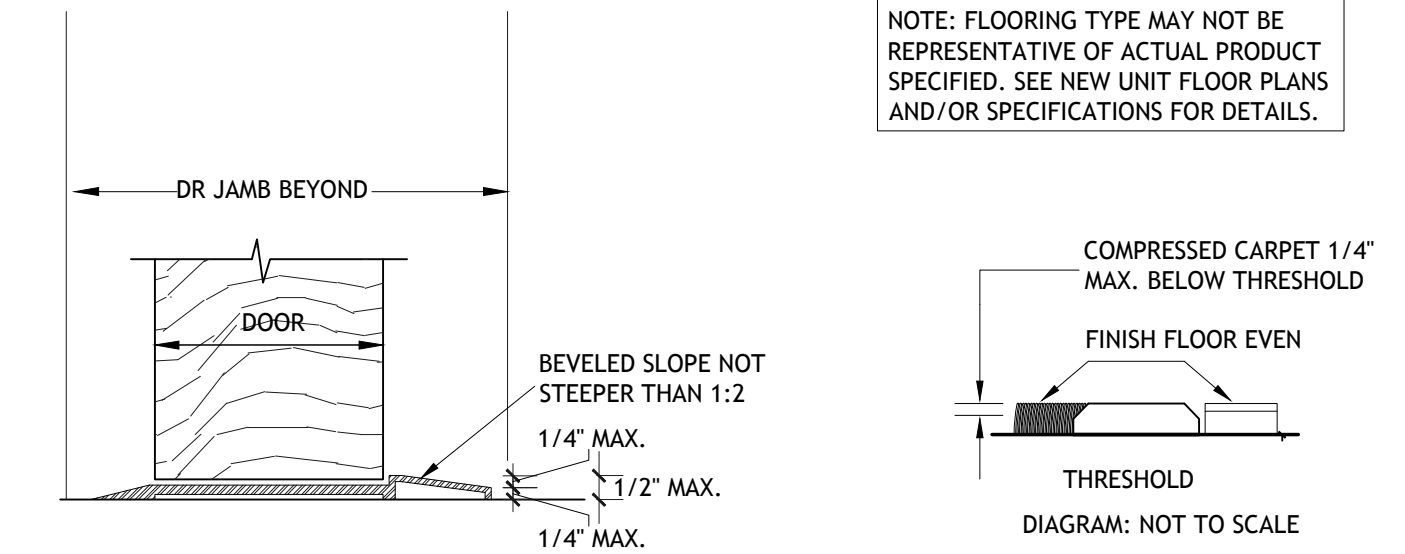

1 THRESHOLD


SCALE: 3" = 1'-0"

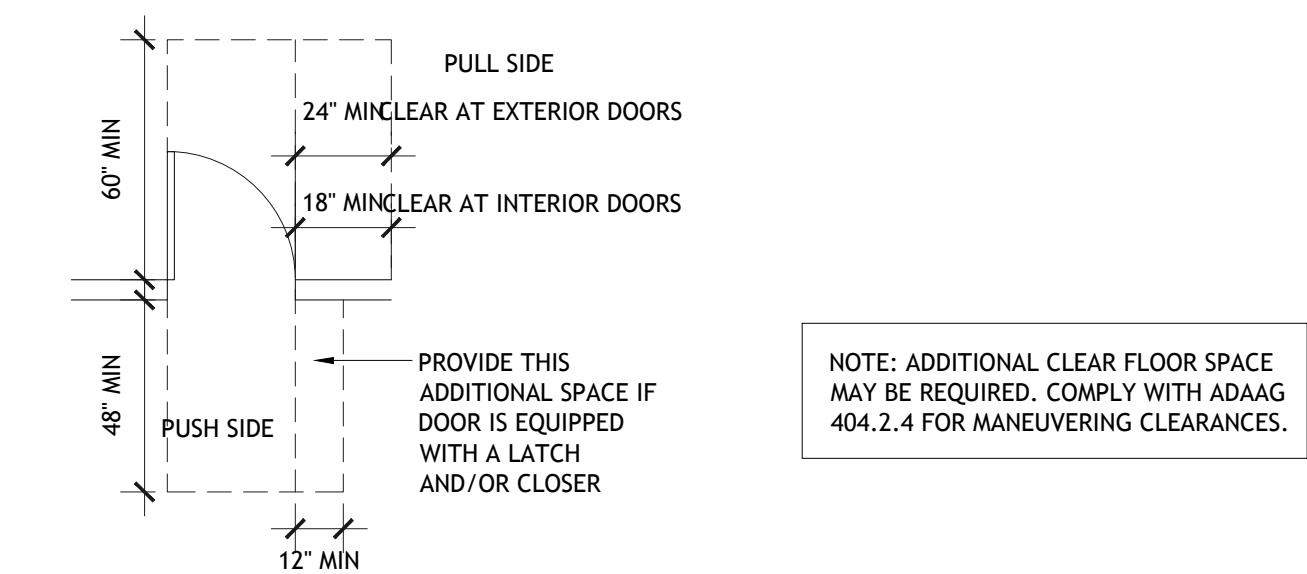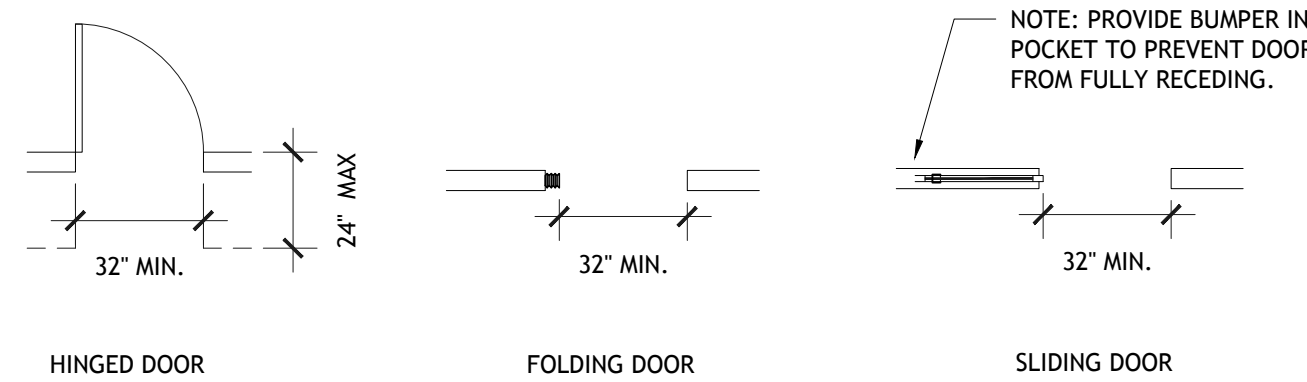

2 MIN. CLEARANCES AT DOORS

SCALE: 1/4" = 1'-0"


- DOOR AND GATE CLOSERS SHALL BE ADJUSTED SO THAT FROM AN OPEN POSITION OF 90 DEGREES, THE TIME REQUIRED TO MOVE THE DOOR POSITION 12 DEGREES FROM THE LATCH IS 5 SECONDS MINIMUM.
- DOOR AND GATE SPRING HINGES SHALL BE ADJUSTED SO THAT FROM THE OPEN POSITION OF 70 DEGREES, THE DOOR OR GATE SHALL MOVE TO THE CLOSED POSITION IN 1.5 SECONDS MINIMUM.

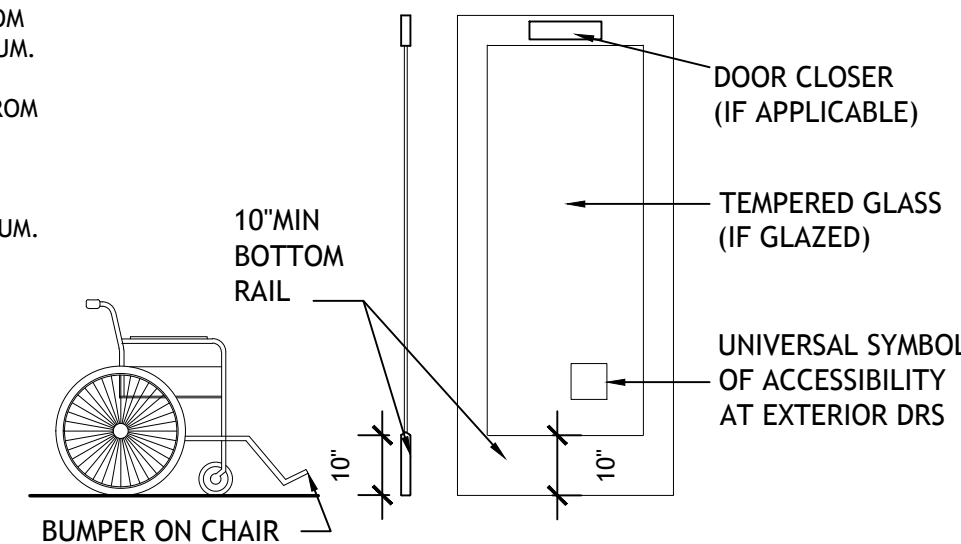

3 DOOR CLOSER AND KICKPLATE

SCALE: 3/8" = 1'-0"

- OPERABLE PARTS SHALL BE OPERABLE WITH ONE HAND AND SHALL NOT REQUIRE TIGHT GRASPING, PINCHING OR TWISTING OF THE WRIST. THE FORCE REQUIRED TO ACTIVATE OPERABLE PARTS SHALL BE 5 LBS MAXIMUM.
- OPERABLE PARTS OF HARDWARE SHALL BE MOUNTED 34" MIN - 48" MAX ABOVE F.F. OR GROUND, WHERE SLIDING DOORS ARE IN THE FULLY OPEN POSITION, OPERATING HARDWARE SHALL BE EXPOSED AND USABLE FROM BOTH SIDES.

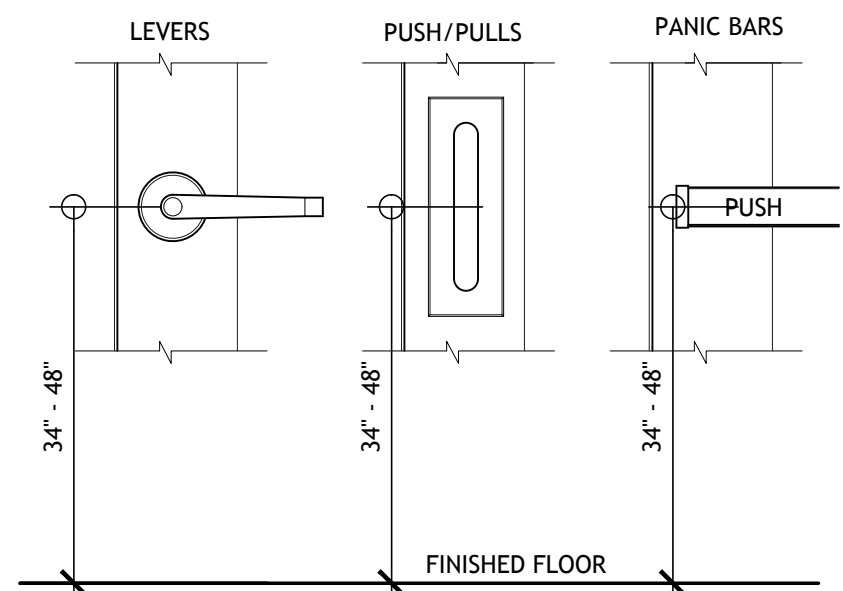

4 DOOR HARDWARE

SCALE: 1 1/2" = 1'-0"

BASIS Architecture & Consulting

2130 FOURTH ST
SAN RAFAEL, CA 94901
PHONE (415) 457-6035
FAX (415) 457-6036

P.O. BOX 150539
SAN RAFAEL, CA 94915

CHARLES PICK, ARCHITECT



DRAWING REVISION LOG

FOR BIO	5-15-2018

PROJECT NAME:

DESERT HAVEN
(QUEEN'S MOTEL)
RE-DEVELOPMENT

PROJECT LOCATION:


16959 STODDARD WELLS RD
VICTORVILLE, CA 92395

SHEET TITLE:

ACCESSIBILITY DETAILS:
INTERIOR


SCALE: AS NOTED

A5.4

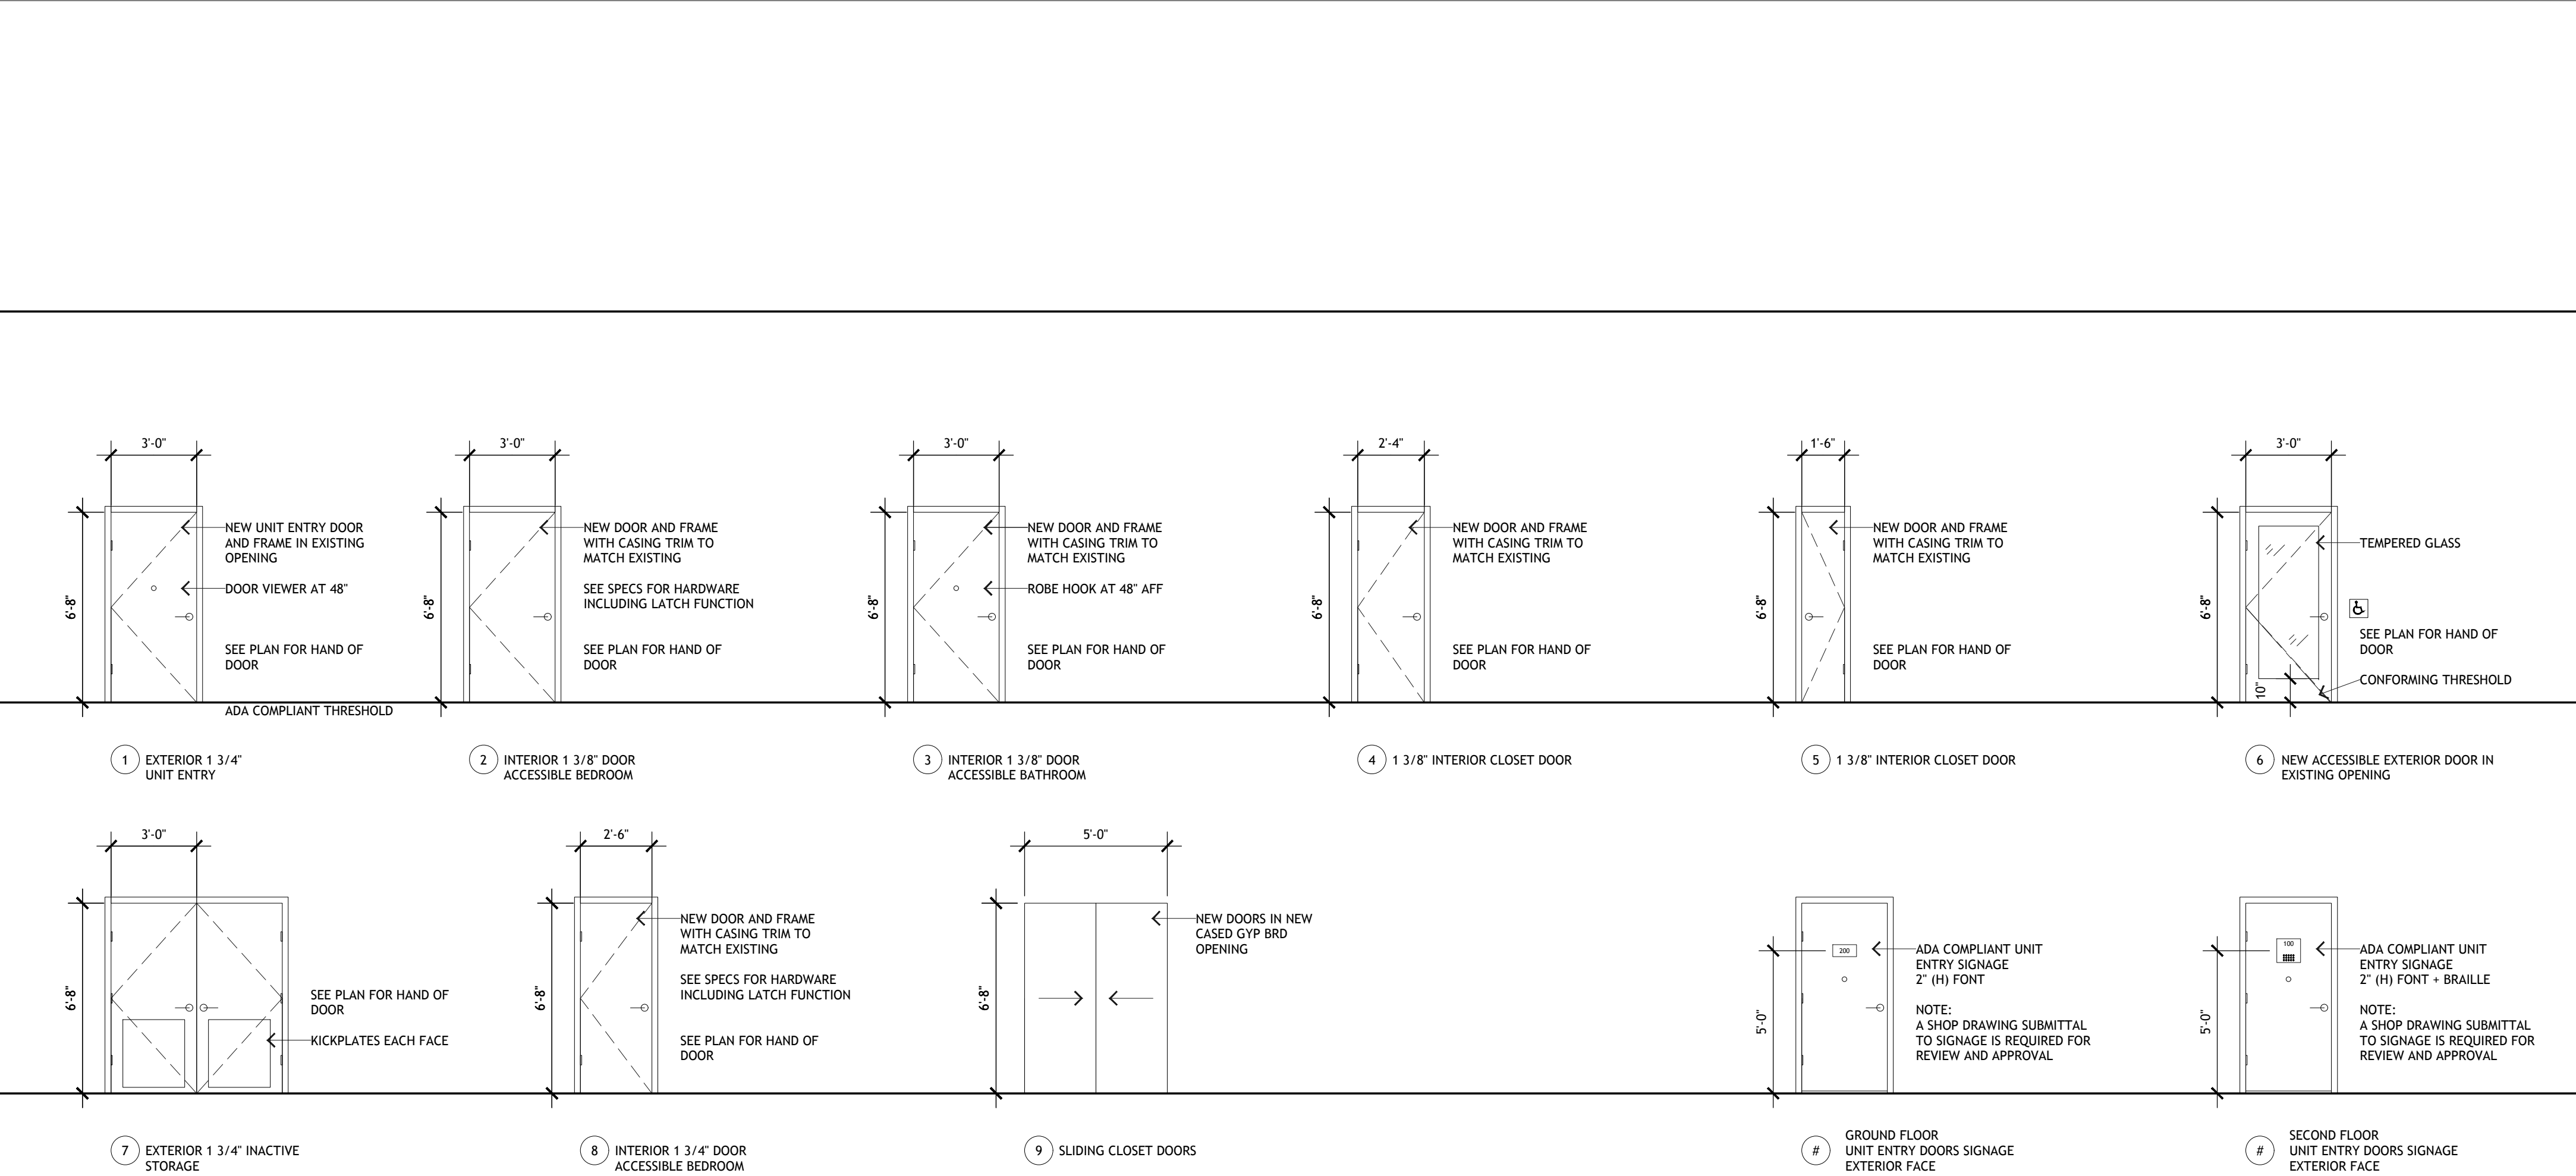

DOOR TYPES

SCALE: 1/4" = 1'-0"

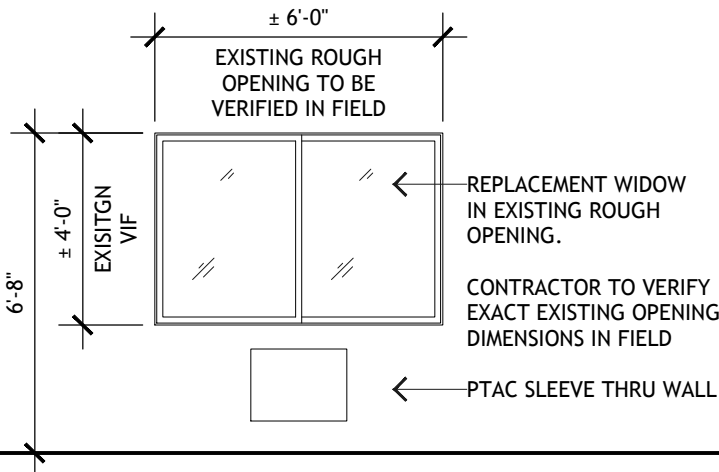

W1 GROUND FLOOR

WINDOW TYPES

SCALE: 1/4" = 1'-0"

WINDOW DEMOLITION NOTES

- 1 THE CONTRACTOR SHALL BE RESPONSIBLE FOR REMOVING AND REINSTALLING ALL WINDOW COVERINGS TO ALLOW FOR NEW WORK.
- 2 THE CONTRACTOR SHALL BE RESPONSIBLE FOR MOVING ALL TENANT'S FURNITURE A MINIMUM OF 5' IN EVERY DIRECTION FROM THE WORK AREA
- 3 THE CONTRACTOR SHALL BE RESPONSIBLE FOR THE PROJECTION OF THE EXISTING FINISHES AND THE TENANT'S FURNISHINGS.
- 4 THE CONTRACTOR SHALL BE RESPONSIBLE FOR CLEANING REFUSE REMOVAL AND THE END OF EACH WORK DAY.

WINDOW NOTES - CONTRACTOR TO NOTIFY ARCHITECT OF ANYDISCREPANCIES PRIOR TO WINDOW ORDER

- 1 IN ADDITION TO REQUIRED MEANS OF EGRESS ALL EXISTING SLEEPING ROOMS HAVE ONE EMERGENCY EGRESS WINDOW WITH A MINIMUM CLEAR OPENING OF 5.7 SQUARE FEET (EXCEPT THE MINIMUM NET CLEAR OPENING FOR EMERGENCY ESCAPE AND RESCUE GRADE FLOOR OPENINGS COULD BE 5 SQUARE FEET). THE MINIMUM NET CLEAR OPENING DIMENSIONS ARE GREATER THAN 24 INCHES (H) AND 20 INCHES (W). THE NET CLEAR OPENING DIMENSIONS SHALL BE THE RESULT OF NORMAL OPERATION OF THE OPENING. THE MAXIMUM HEIGHT FROM THE FLOOR FOR EMERGENCY EGRESS WINDOWS IS NOT GREATER THAN 44 INCHES.
- 2 ALL WINDOWS IN THE DWELLING UNITS ABOVE THOSE AT GRADE SHALL BE EQUIPPED WITH A CHILDPROOF LATCH THAT WILL NOT ALLOW THE WINDOW TO BE OPENED MORE THAN 4 INCHES.
- 3 THE CONTRACTOR SHALL BE RESPONSIBLE FOR VERIFYING ALL EXISTING ROUGH OPENINGS DIMENSIONS FOR NEW REPLACEMENT WINDOWS IN EXISTING OPENINGS AND MAKE ALL NECESSARY ADJUSTMENTS FOR THE FIELD VERIFIED DIMENSIONS IN THE SHOP DRAWING SUBMITTAL REQUIRED FOR REPLACEMENT WINDOWS.
- 4 WINDOW GLAZING IN HAZARDOUS LOCATIONS REQUIRE SAFETY GLAZING MATERIALS, EITHER TEMPERED GLASS OR LAMINATED SAFETY GLASS. WIRED GLASS IS NOT PERMITTED.
- 5 CONTRACTOR PRIOR TO WINDOW ORDER TO PROVIDE FIXED PANEL LOCATIONS AS REQD FOR CONFORMING VENTING CLEARANCES AT RELOCATED GAS METERS & NEW HOT WATER HEATER LOCATIONS.

GLAZING NOTES

- 1 THE FOLLOWING ARE CONSIDERED HAZARDOUS LOCATIONS REQUIRING SAFETY GLAZING:
GLAZING IN AN INDIVIDUAL FIXED OR OPERABLE PANEL ADJACENT TO A DOOR WHERE THE NEAREST EXPOSED EDGE OF THE GLAZING IS WITHIN A 24 INCH ARC OF EITHER VERTICAL EDGE OF THE DOOR IN A CLOSED POSITION AND WHERE THE BOTTOM EXPOSED EDGE OF THE GLAZING IS LESS THAN 60 INCHES ABOVE THE WALKING SURFACE.

DOOR SCHEDULE					
#	LOCATION	DOOR SIZE	DOOR TYPE	HARDWARE FUNCTION	NOTES
1	TYPICAL UNIT ENTRY	3'-0" X 6'-8" X 1 3/4" DOOR AND FRAME IN EXISTING OPENING	HINGED	ENTRY	FURNISH WITH ADA CONFORMING LEVER HARDWARE, THRESHOLD AND DOOR VIEWER
2	TYPICAL UNIT BEDROOM	3'-0" X 6'-8" X 1 3/8" DOOR AND FRAME IN NEW OPENING	HINGED	PASSAGE	FURNISH WITH ADA CONFORMING LEVER HARDWARE
3	TYPICAL UNIT BATHROOM	3'-0" X 6'-8" X 1 3/8" DOOR AND FRAME IN NEW OPENING	HINGED	PASSAGE	FURNISH WITH ADA CONFORMING LEVER HARDWARE, AND ROBE HOOK ON INTERIOR FACE
4	CLOSET	2'-4" X 6'-8" X 1 3/8" DOOR AND FRAME IN NEW OPENING	HINGED	PASSAGE	FURNISH WITH ADA CONFORMING LEVER HARDWARE
5	CLOSET	1'-6" X 6'-8" X 1 3/8" DOOR AND FRAME IN NEW OPENING	HINGED	PASSAGE	FURNISH WITH ADA CONFORMING LEVER HARDWARE
6	COMMUNITY ROOM	3'-0" X 6'-8" X 1 3/4" DOOR AND FRAME IN EXISTING OPENING	HINGED	ENTRY	FURNISH WITH ADA CONFORMING LEVER HARDWARE, THRESHOLD AND DOOR VIEWER
7	TYPICAL UNIT	PAIR 3'-0" X 6'-8" DOORS AND FRAME IN EXISTING OPENING	HINGED	STORAGE	
8	OFFICE UNIT	2'-4" X 6'-8" X 1 3/4" DOOR AND FRAME IN EXISTING OPENING	HINGED	OFFICE	NEW FRAME AND DOOR IN EXISTING ROUGH OPENING (REVERSES SWING OF EXISTGN DOOR TO BE REMOVED) OFFICE LOCK FUNCTION WITH DOOR ALWAYS LOCKED ON PUBLIC SIDE
9	CLOSET	5'-0" X 6'-8" CASED GYP BRD OPENING	BI-PARTING	CLOSET	

CONTRACTOR TO VIF ALL SIZES AND REPLACEMENTS

WINDOW SCHEDULE					
#	WINDOWS DIMENSIONS CONTRACTOR TO VIF	OPERATION	GLAZING	LOCATION	NOTES
W1	REPLACEMENT WINDOW IN ± 6'-0" X 4'-0" EXISTING OPENING	FLIXED/SLIDER	DUAL GLAZED WITH LOW E GLASS	TYPICAL UNIT	CONTRACTOR TO VERIFY EXACT ROUGH OPENINGS IN FIELD AND ACCOUNT FOR THE DIMENSIONS IN 5 SHOP DRAWING SUBMITALL FOR REVIEW AND APPROVAAL PRIOR TO ORDERING

NOTES:
CONTRACTOR TO VIF ALL SIZES & REPLACEMENTS
(R) = REPLACE EXISTING
(N) = NEW


THE OPERABLE PORTION OF THE WINDOWS IS TO BE PROTECTED WITH INSECT SCREENS

BASIS Architecture & Consulting

2130 FOURTH ST
SAN RAFAEL, CA 94901
PHONE (415) 457-6035
FAX (415) 457-6036

P.O.BOX 150539
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CHARLES PICK, ARCHITECT

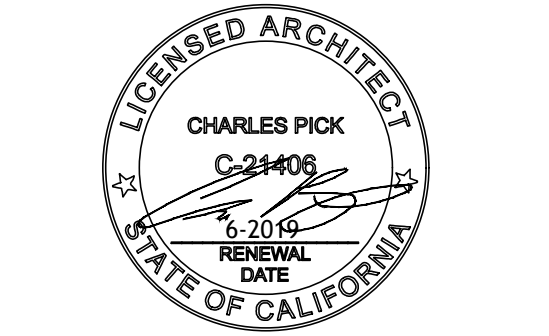

DRAWING REVISION LOG	
FOR BIO	5-15-2018

PROJECT NAME:
**DESERT HAVEN
(QUEEN'S MOTEL)
RE-DEVELOPMENT**

PROJECT LOCATION:
**16959 STODDARD WELLS RI
VICTORVILLE, CA 92395**

SHEET TITLE:
**WINDOW AND DOOR
SCHEDULES**

A6.0